



OVERLAP ENDS TIGHTLY
24" MINIMUM

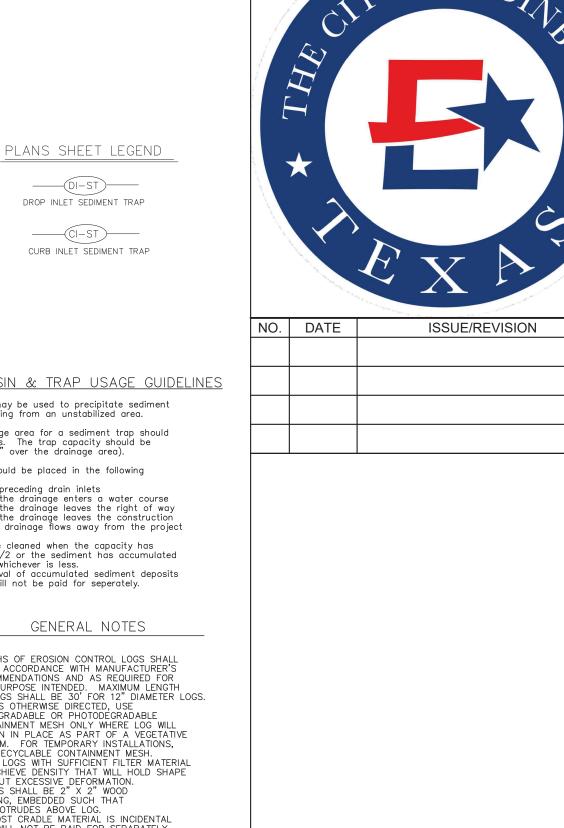


APP.

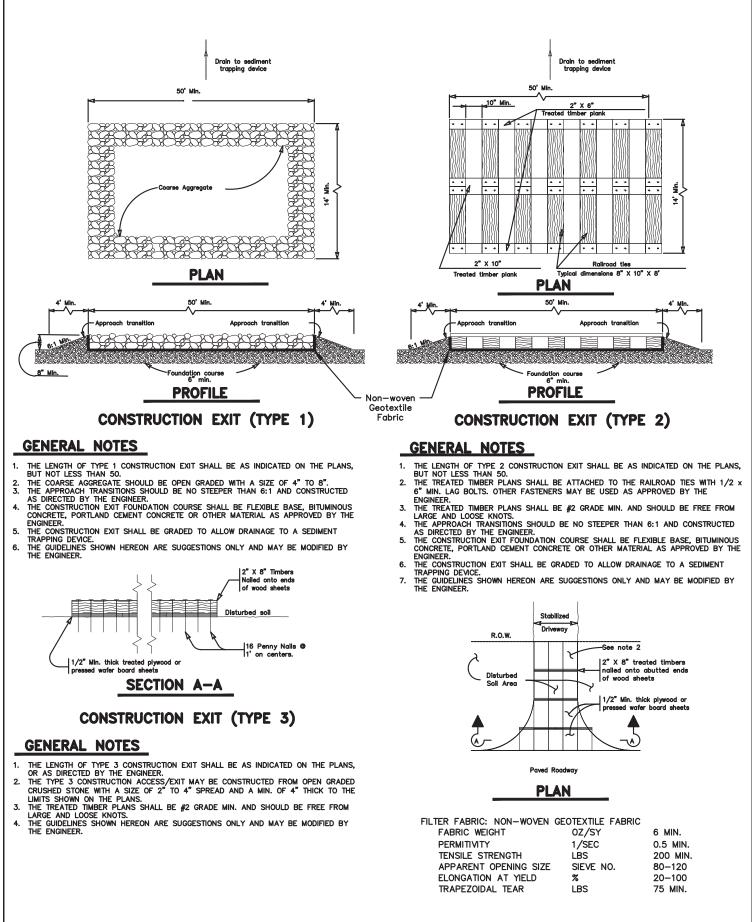



TEMPORARY EROSION CONTROL


CONSTRUCTION ACCESS / EXIT

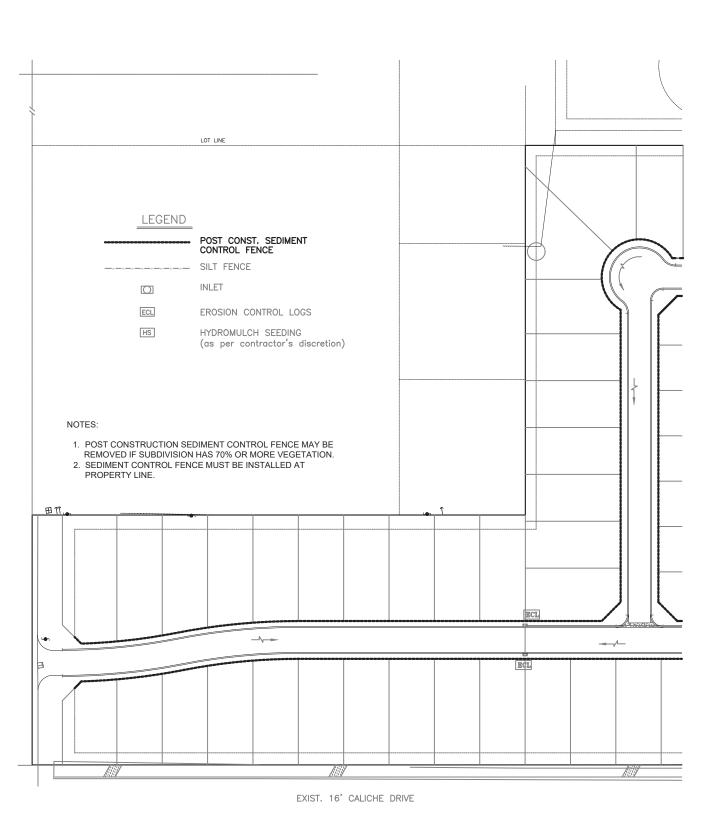



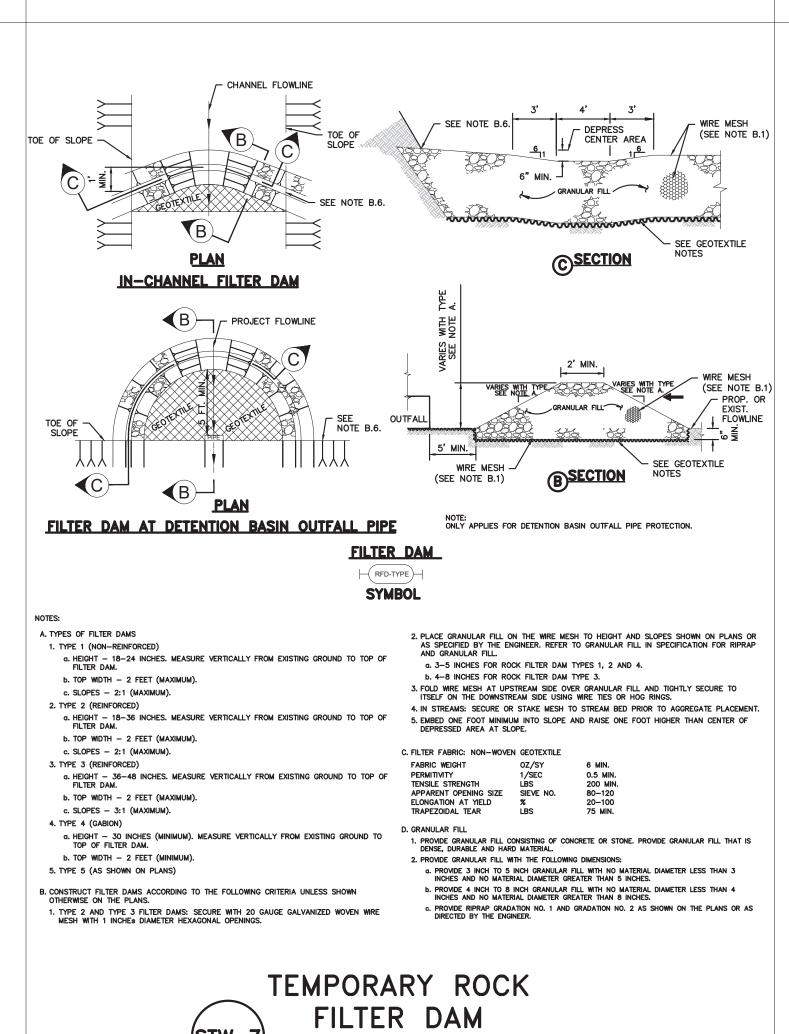

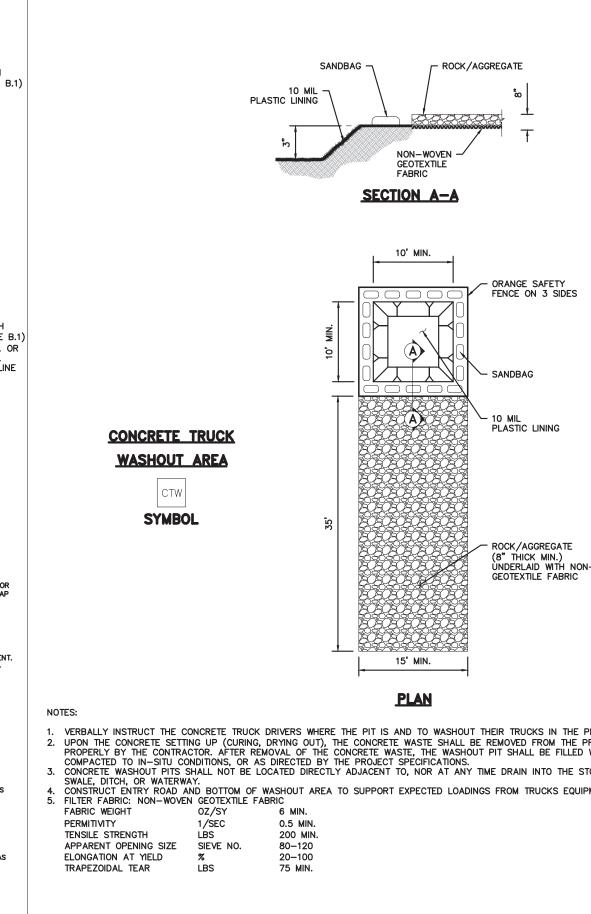

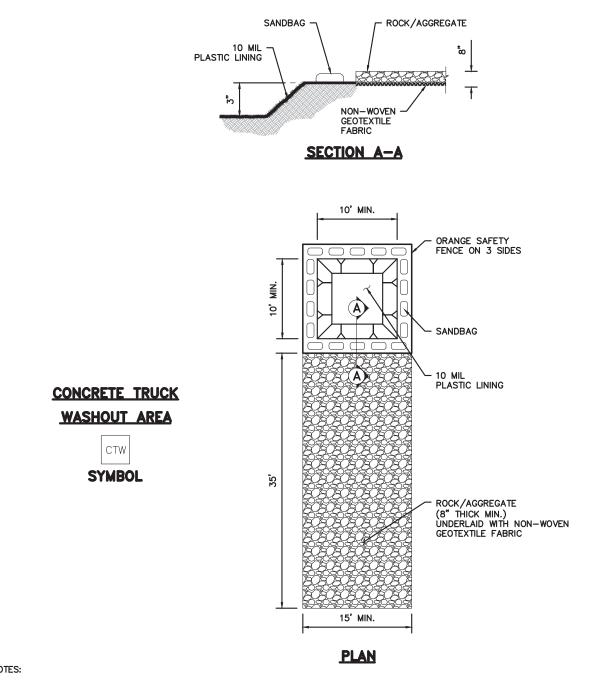

VERBALLY INSTRUCT THE CONCRETE TRUCK DRIVERS WHERE THE PIT IS AND TO WASHOUT THEIR TRUCKS IN THE PIT AND NOWHERE ELSE. . UPON THE CONCRETE SETTING UP (CURING, DRYING OUT), THE CONCRETE WASTE SHALL BE REMOVED FROM THE PROJECT SITE AND DISPOSED OF PROPERLY BY THE CONTRACTOR. AFTER REMOVAL OF THE CONCRETE WASTE, THE WASHOUT PIT SHALL BE FILLED WITH CLEAN FILL MATERIAL AND COMPACTED TO IN-SITU CONDITIONS, OR AS DIRECTED BY THE PROJECT SPECIFICATIONS.

CONCRETE WASHOUT PITS SHALL NOT BE LOCATED DIRECTLY ADJACENT TO, NOR AT ANY TIME DRAIN INTO THE STORM SEWER SYSTEM OR ANY OTHER 4. CONSTRUCT ENTRY ROAD AND BOTTOM OF WASHOUT AREA TO SUPPORT EXPECTED LOADINGS FROM TRUCKS EQUIPMENT 5. FILTER FABRIC: NON-WOVEN GEOTEXTILE FABRIC

> CONCRETE TRUCK WASH AREA

PROJECT NAME:

SHEET NAME: STORMWATER


DETAILS DATE:


SEPTEMBER 2022 **CREATED BY:**

CITY OF EDINBURG ENGINEERING DEPARTMENT

DRAWING SCALE: N.T.S.

SHEET

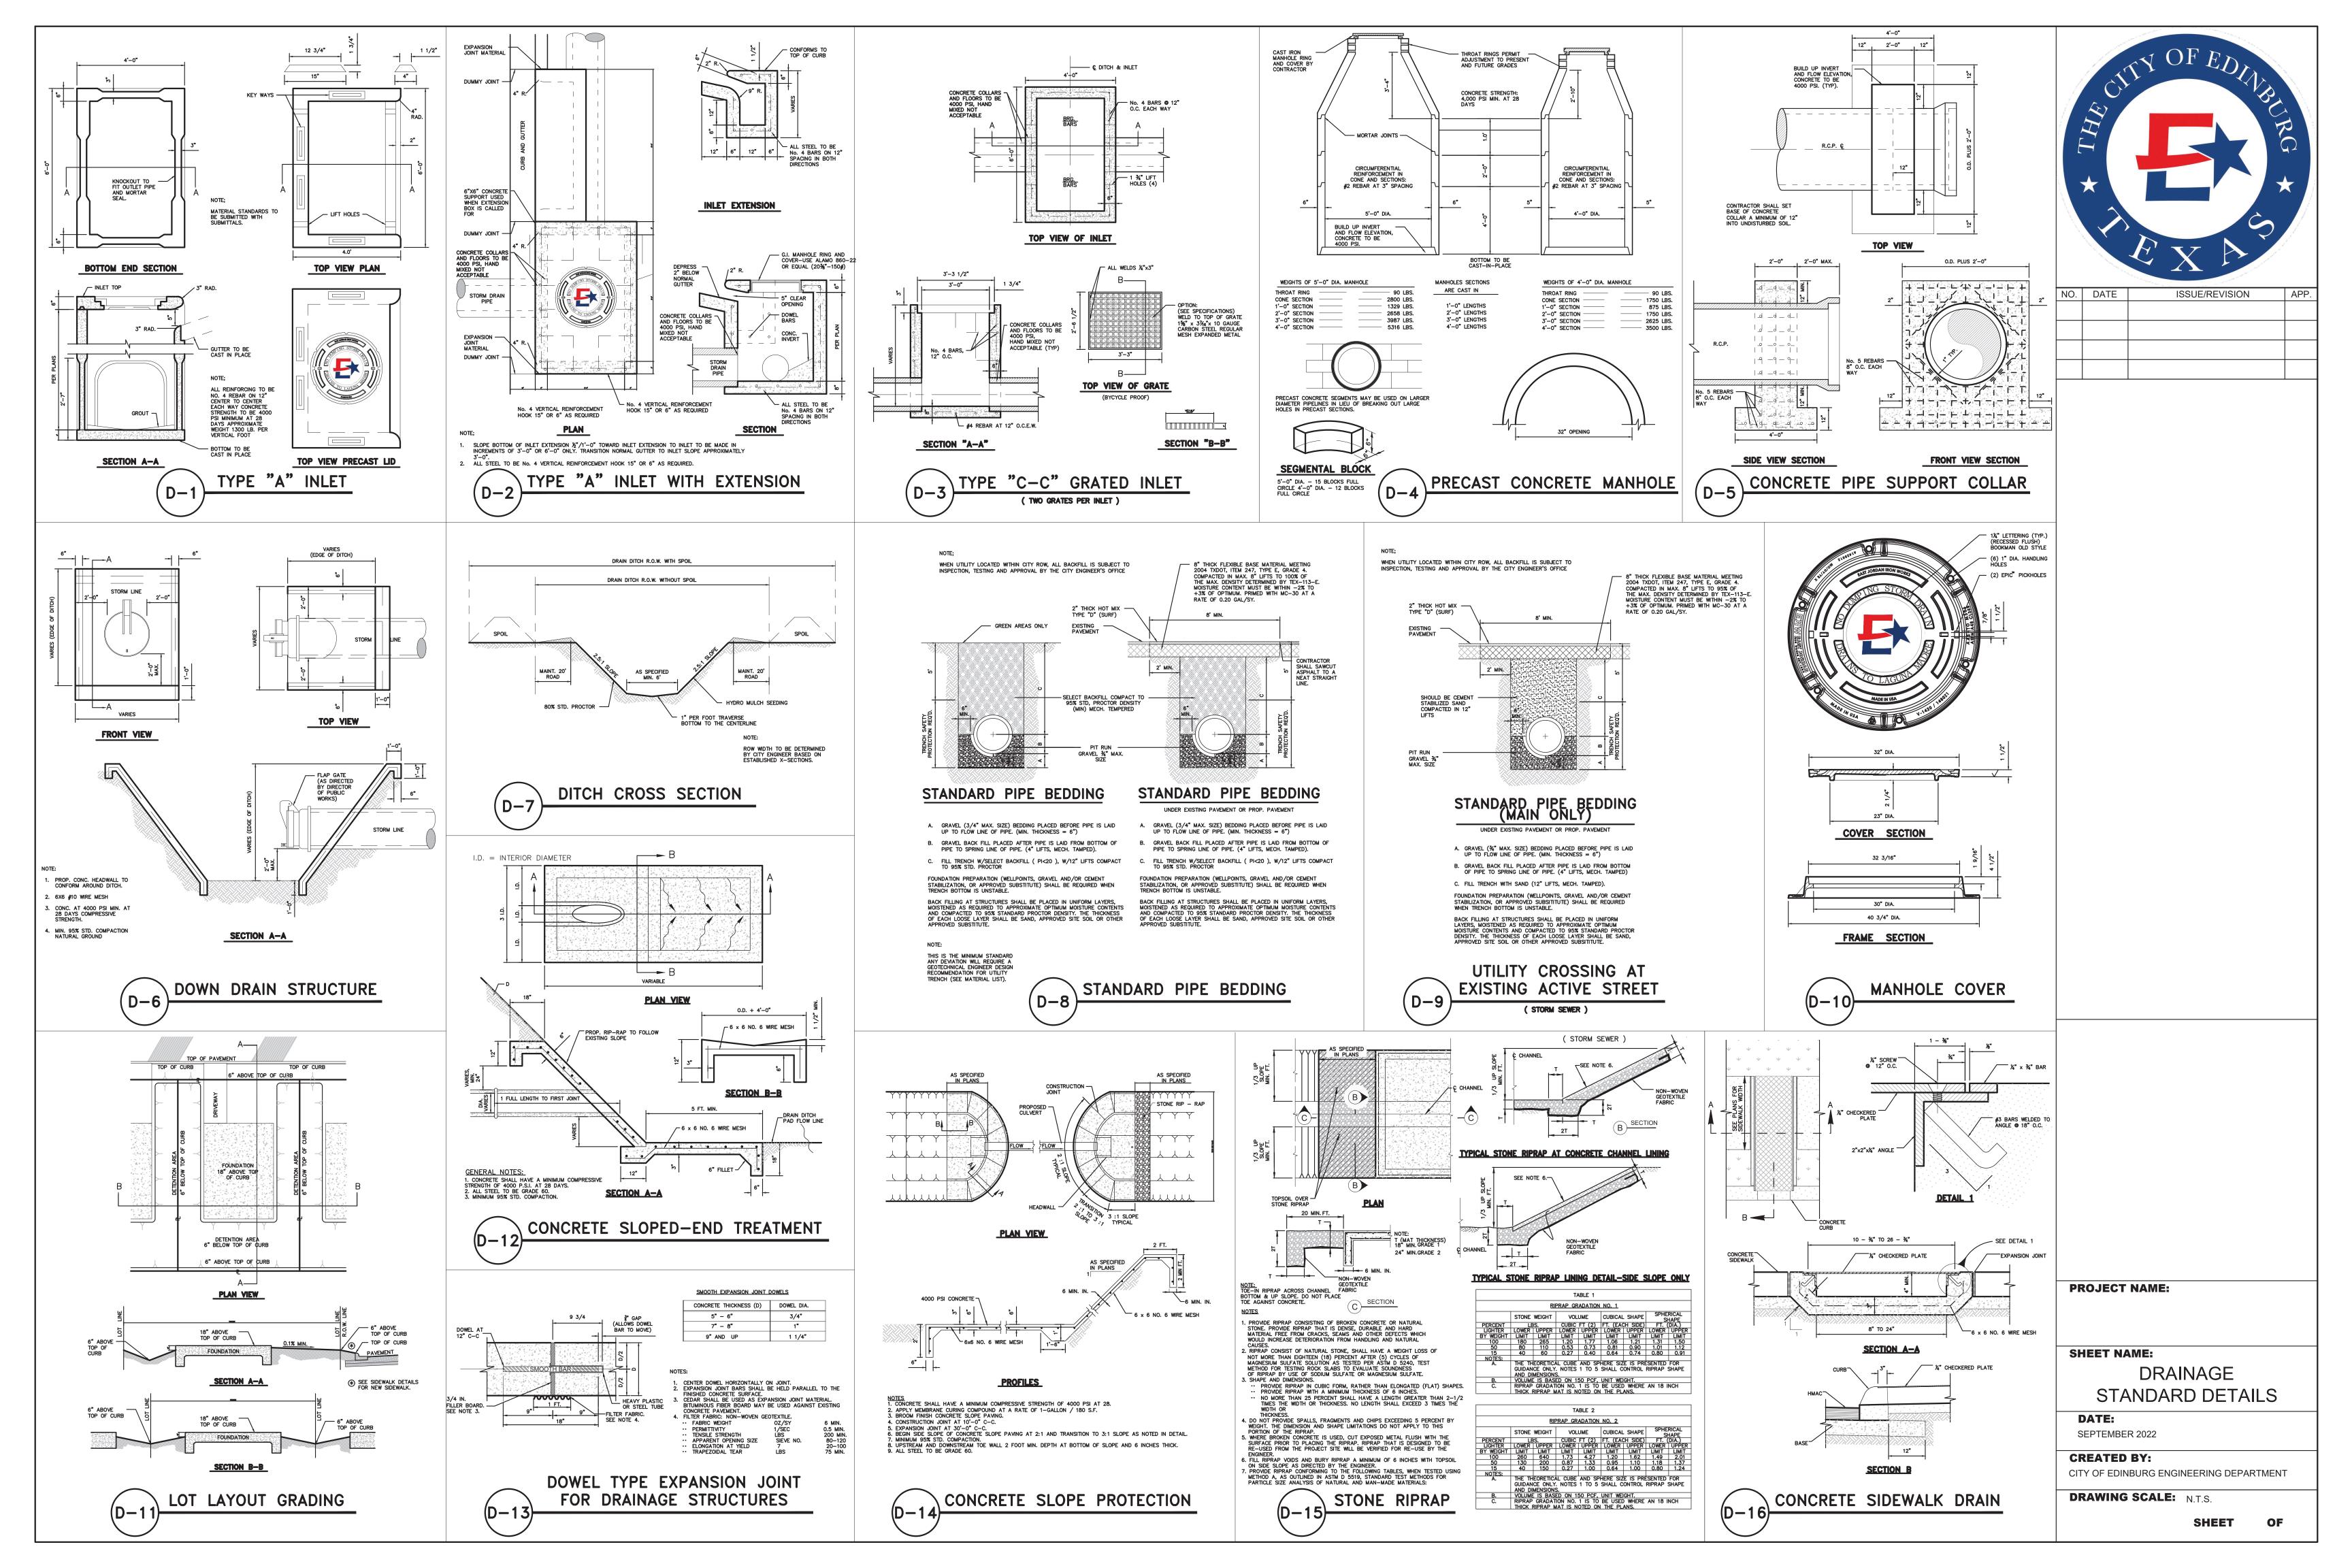

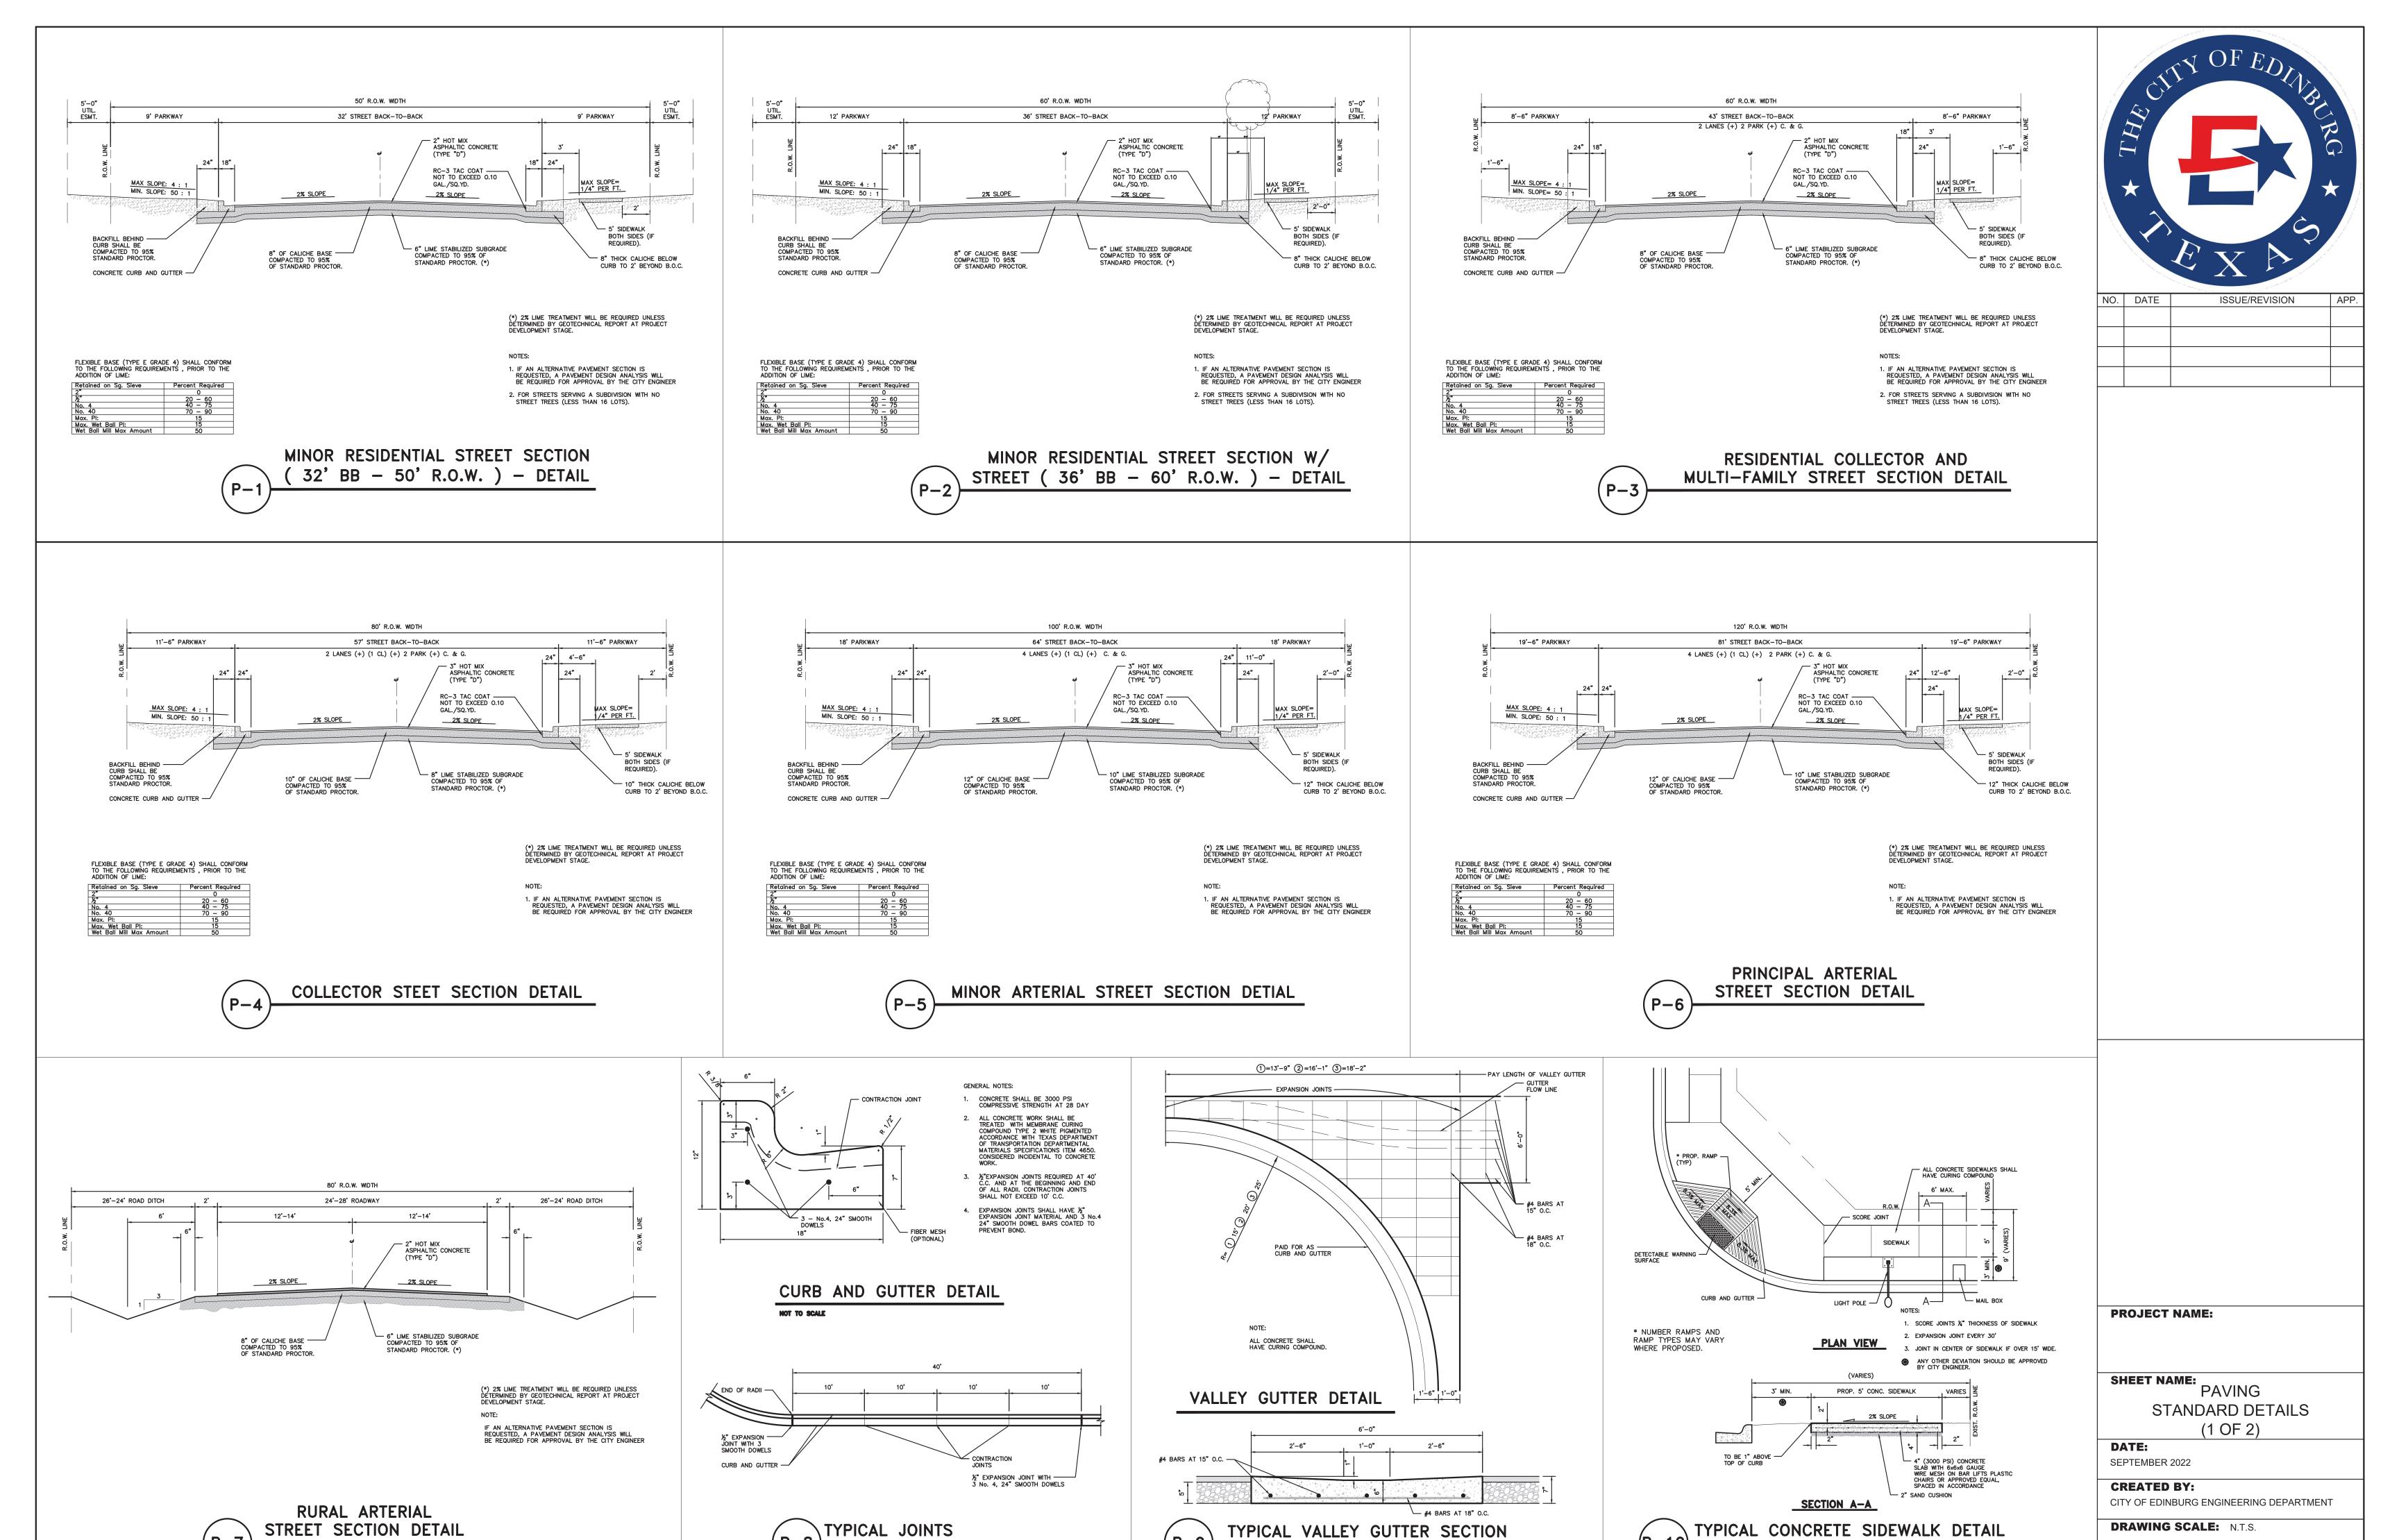

OF

SHEET

