

PLANNING COMMISSION

WEDNESDAY, AUGUST 25, 2021 Sycamore Room – 1st Floor 201 West Ash Street Mason, MI 6:30 P.M.

AGENDA

- 1. CALL TO ORDER
- 2. ROLL CALL
- 3. PUBLIC COMMENT
- 4. APPROVAL OF MINUTES
 - A. Approval of Minutes from Regular Planning Commission Meeting on August 10, 2021.

5. UNFINISHED BUSINESS

- A. Resolutions 2021-04 and 2021-05: Alan Boyer, LSG Engineers & Surveyors, on behalf of Gestamp Mason, LLC, has requested approval of a Special Use Permit and Final Site Plan for construction of a new 49,200 sq. ft. addition on an existing 624,780 sq. ft. building to be used as a Finish Goods Product Storage (Low Bay) and to perform other related site improvements on property located at 200 E. Kipp Rd, parcel 33-19-10-16-100-024. The parcel is zoned M-2 General Manufacturing District.
- 6. **NEW BUSINESS**
- 7. LIAISON REPORT
 - A. City Council Report
 - B. City Manager Report
- 8. ADJOURN

CITY OF MASON PLANNING COMMISSION MEETING MINUTES OF AUGUST 10, 2021 DRAFT

Sabbadin called the meeting to order at 6:30 p.m. in person at Mason City Hall.

MOTION by Waxman, second by Barna, to amend the agenda to include Oath of Office as item 2, and to add the text 'Special Use Permit' to Gestamp's request in item 5.A.

OATH OF OFFICE

City Clerk Sara Jarvis administered the Oath of Office to Kyle Elizabeth Kirkby, Planning Commissioner recently appointed by City Council at their August 2 meeting. Chair Sabbadin welcomed Commissioner Kirkby.

ROLL CALL

Roll Call		Present	Absent	Notes	
Commissioner	Barna	Х			
Council Liaison	Clark	Х			
Vice-Chair	Howe		Х	Without notice	
Commissioner	Husby		Χ	With notice	
Commissioner	Kirkby	X			
Commissioner	Perrault	X			
Chair	Sabbadin	X			
Commissioner	Waxman	Х			
Secretary	Wren	Х		Arrived at 6:49 p.m.	

Also present: Elizabeth A. Hude, AICP, Community Development Director

PUBLIC COMMENT

None.

APPROVAL OF MINUTES

MOTION by Waxman, second by Barna, to approve the Planning Commission meeting minutes from June 15, 2021.

Yes (7) Barna, Clark, Kirkby, Perrault, Sabbadin, Waxman, Wren No (0)

Absent (2) Howe, Husby

MOTION PASSED

PUBLIC HEARING

A. Alan Boyer, LSG Engineers & Surveyors, on behalf of Gestamp Mason, LLC, has requested approval of a Final Site Plan and Special Use Permit for construction of a new 49,200 sq. ft. addition on an existing 624,780 sq. ft. building to be used as a Finish Goods Product Storage (Low Bay) and to perform other related site improvements on property located at 200 E. Kipp Rd, parcel 33-19-10-16-100-024. The parcel is zoned M-2 General Manufacturing District.

OPEN: 6:36 p.m. CLOSED: 6:42 p.m.

PUBLIC COMMENTS: NONE

DISCUSSION: Alan Boyer, LSG Engineers & Surveyors, on behalf of Gestamp Mason, LLC presented a summary of the project as described in the agenda packet. Director Hude provided an overview of the staff report and that additional information had been requested in several areas — parking, lighting, landscaping, sidewalks and traffic/truck routes. Mr. Boyer pointed out their statement in the packet that they are working with staff to address the items and take no exception to the items in the report. He noted additional Gestamp representatives in the audience — Jeff Bowling, Christopher Trevisan, and Damian Starr.

Discussion between the applicant and Commissioners took place. Key points discussed included encouraging the applicant to utilize the provision in the ordinance to defer construction of unnecessary new required parking to minimize impervious surface, the history and need for sidewalk connections on the site, and the need for a traffic study. The applicant reported that an additional 40 trucks per day would visit the site, all routed through an existing high-traffic area from the Kipp Rd exit on US-127 east to turn right and travel south on Hull Rd, then turn left to enter on Trillium Dr. They do not intend to utilize the Barnes Rd exit at this time. They would like to arrange for the traffic study to be completed and made available at a later date as the lead time is about 4 months out for completion. Gestamp would like to begin construction at the end of the month, August 31. They will have the revised plans and additional information ready to meet the deadline for a special meeting of the PC the week of August 23. The Commissioners determined that Wednesday, August 25, at 6:30 p.m. would be best for attendance.

MOTION by Waxman, second by Clark, to table the discussion to Wednesday, August 25, 2021 at 6:30 p.m.

Yes (7) Barna, Clark, Kirkby, Perrault, Sabbadin, Waxman, Wren No (0) Absent (2) Howe, Husby

MOTION PASSED

UNFINISHED BUSINESS

A. Master Plan Update

Director Hude encouraged everyone to sign up for the email updates and to anticipate a request for future joint PC/CC kick-off meeting in the future, possibly late September or October.

NEW BUSINESS

A. Discussion: Ordinance text amendments regarding attached garages and front yard parking Director Hude provided an overview of her request for guidance on a future text amendment to the ordinance that clarifies the community's expectations on projecting garages. There have been different interpretations over the years and staff is seeking PC input on amendments to clarify existing language, and accommodate modern housing styles. Commissioners asked questions and discussion took place regarding the need for an ordinance amendment – some felt no changes were necessary; if the amendment should limit projecting garages at all or only in certain areas such as older neighborhoods with established patterns (infill) vs. newer subdivisions; and if it was necessary to regulate architectural details like windows in a garage door. Some expressed support for addressing the issue noting examples of housing that appeared to be a wall of garages and the need to consider the character of Mason. Staff was advised to revise the proposal and bring to the next meeting in September, removing some of the detail on restrictions, and to focus the amendments toward clarifying and strengthening subjective language.

A. Discussion: Youth Advisor Role

Youth Advisor, Thomas De LaFuente was unable to attend the meeting. Commissioners agreed to take up the discussion further at the September meeting when he was present.

LIAISON REPORT

A. Council Liaison Report

Council Liaison Clark provided an update regarding actions taken at the last City Council meeting on August 2.

B. City Manager Report

Director Hude stated that they were still working to fix the link in the packet, and that printed copies were made available this evening.

Meeting was adjourned at 8:25 p.m.					
Magan Wron Coordon					
Megan Wren, Secretary					



City of Mason Planning Commission Staff Report

TO: Planning Commission

FROM: Elizabeth A. Hude, AICP, Community Development Director

SUBJECT: 200 E. Kipp - Gestamp

DATE: August 19, 2021 for August 25, 2021 mtg - FINAL

Alan Boyer, LSG Engineers & Surveyors, on behalf of Gestamp Mason, LLC has submitted a request for approval of a Special Use Permit and Final Site Plan for construction of a new 49,200 sq. ft. addition on an existing 624,780 sq. ft. building to be used as a Finish Goods Product Storage (Low Bay) and to perform other related site improvements on property located at 200 E. Kipp Rd, parcel 33-19-10-16-100-024. The parcel is zoned M-2 General Manufacturing District.

The applicant has submitted revised drawings to address comments and requests for additional information as noted in the August 10, 2021 Planning Commission packet. The revised documents were received Monday, August 16, 2021 and include:

- Plans for Construction of Gestamp Expansion, prepared by LSG Engineers & Surveyors, dated May 24, 2021, last revised August 13, 2021:
 - o Cover, Sheet C
 - As Built Site Survey Existing Conditions, Sheet C1.0
 - Topographic Survey, Sheet C1.1
 - o Overall Site Plan, Sheet C2.0
 - o Overall Site Plan Traffic Plan, Sheet C2.01 (New)
 - o Overall Site Plan Construction Phasing, Sheet C2.02 (New)
 - Detailed Demolition Plan, Sheet C2.1
 - o Detailed Site Plan, Sheet C3.0
 - o Detailed Sidewalk Plans, Sheet C3.1 (New)
 - o Detailed Grading Plan, Sheet C4.0
 - Detailed Utility Plan, Sheet C5.0
 - o Fire Main Plan and Profile, Sheet C5.1
 - Storm Drainage Plan and Profile, Sheet C5.2
 - o Miscellaneous Details, Sheet C6.0
 - Fire Main Details, Sheet C6.1
 - o Storm Drainage Details, Sheet C6.2
 - Soil Erosion Control Plan, Sheet C7.0
 - Soil Erosion Control Details, Sheet C7.1
 - Soil Erosion Control Notes, Sheet C7.2
 - Landscape Plan, Sheet L1.0

- o Site Photometric Plan, Sheet E2.0 (New)
- o Parking detail for the proposed future parking bank (New)

Click here to access the packet of materials from the August 10, 2021 Planning Commission Meeting and Public Hearing – MEETING PACKET LINK.

The applicant paid a fee of \$375, and together with the plans and documents listed above, the application appears to satisfy the submittal requirements of Sec. 94-225(b) and 94-226(a).

PUBLIC NOTICE

Notice was given as required in Sec. 94-101 which requires notices to be published in a newspaper of general circulation, and to be mailed to owners and occupants within 300 feet of the boundary of the subject property. The public hearing notice was posted at City Hall and published in the Ingham County Community News Legal Section on Sunday, July 25, 2021; notices were mailed to owners and occupants on July 22, 2021.

CONSTRUCTION SCHEDULE

In the submission letter dated July 2, 2021, it states Gestamp Mason, LLC, plans to begin construction immediately upon approval and permitting. Building occupancy is desired in Spring of 2022 or sooner. The construction will happen in two phases. Phase 1 will be the road installation and Phase 2 will be the construction of the new 49,200 sq. ft. building addition.

SITE HISTORY

The facility was first constructed in 1997 beginning at 241,444 sq. ft. Expansions occurred in 2007, 2011, 2016 resulting in the current total square footage of 624,780 sq. ft. With the proposed expansion, the facility will reach 673,980 total sq. ft.

LAND USE/ZONING/MASTER PLAN

The site is bordered by Kipp Road to the north, Hull Road to the west, and Trillium Drive to the south. The Jackson & Lansing Railroad borders the property to the east. Approximately 850 feet of the Sycamore Creek crosses the northeast corner of the property. A portion of the 100-year floodplain is located in northeast corner of the site. Kipp and Hull rights of way are under the jurisdiction of the Ingham County Road Department. The parcel is zoned M-2 General Manufacturing District.

This is a material change to a previously approved site plan and therefore subject to Planning Commission review per Sec. 94-228. A Special Use Permit is required only in accordance with Sec. 94-152(d)(1) Above ground storage of flammable liquids or combustible materials. There are above ground propane storage tanks being relocated on the site. The current and proposed uses are allowed by right under Sec. 94-152(b)(12)f. Industrial manufacturing, processing, or assembling of transportation equipment, such as motor vehicles and non-motorized vehicles and parts. A prior draft of the staff report suggested a SUP may not be required and has since been confirmed as stated here.

The surrounding land us	es and zoning are	as follows:
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	Current Land Use	Zoning	Future Land Use
North	Commercial and Undeveloped	C-2 (General Commercial) M-1 (Light Manufacturing)	Mixed Use
East	Jackson and Lansing Railroad Vevay Township	Vevay Township	Vevay Township
South	Industrial and Undeveloped	M-2 (Light Manufacturing)	Industrial
West	Commercial, Residential and Vacant Residential	C-2 (General Commercial) AG (Single Family Agricultural)	Commercial

The Master Plan Goal and Objectives that are most relevant include:

Community Character, Historic Preservation and the Environment on p. 2-3:

GOAL: Preserve the quiet, historical, and small-town character of Mason along with the integrity of its environmental resources. Objectives 1) Encourage land development designed in scale with existing developed areas and the dominant character of the City, through reasonable standards addressing density, building size, height, architectural design, setbacks, signage, opens space, and other development features. (cont.) 9) Maintain and beautify established and new parking areas through appropriate landscaping and screening. 10) Encourage landscaping and screening programs, in association with new commercial and industrial development, to minimize negative impacts on community character. 11) Encourage the preservation of open spaces and natural resources (such as woodlands, wetlands, and stream corridors) as part of the land development process, including the use of clustered housing design.

Industrial Development are stated on p. 2-6:

<u>GOAL</u>: Provide opportunities for the reasonable expansion of industrial development in a manner that is sensitive to the predominant small-town character of the community, minimizes new public service costs, and protects the viability and desirability of residential and commercial areas.

Objectives: 1) Recognize the significance of key corridors such as U.S. 127 and the Jackson and Lansing Railroad as potential opportunities for the location of new industrial development. 2) Emphasize industrial development that is in character and scale with surrounding land uses and the City as a whole, considering such features as building size and height, architectural design, setbacks, signage, lighting, landscaping, and open spaces. 3) Encourage industrial development to be located in targeted areas rather than indiscriminately encroach into residential and commercial areas. 4) Emphasize industrial uses that have comparatively low public services and infrastructure needs. 5) Emphasize industrial uses that minimize negative impacts upon adjacent land uses, taking into consideration such factors as noise, traffic, lighting, fumes and shadow patterns. 6) Encourage industrial uses to locate within well-designed industrial parks, characterized by ample landscaping buffering and interior street systems. 7) Through site plan review proceedings, work to ensure that new industrial uses reflect a visual character that is complementary to the City as a whole. 8) Encourage the redevelopment and upgrading of deteriorating and unsightly industrial properties.

COMMENTS – DEPARTMENTS AND AGENCIES

A public hearing was held on August 10, 2021 where no public comments were received. Click here to access the packet of materials from the August 10, 2021 Planning Commission Meeting and Public Hearing – MEETING PACKET LINK.

Staff circulated the application and plans to city staff and agencies with jurisdiction over the project. The following comments were received.

Engineer	See email in August 10 packet. Comments have been addressed.
Fire	[City Engineer email] captures my concerns about access roads and the hydrant connections. Additionally, will there be any hazardous chemicals or products stored in the addition and are they up to date with the Ingham County P-2 reporting? Applicant has confirmed IC P-2 reporting is up to date, the new canopy will store empty steel shipping racks and steel baskets.
Police	Add sufficient lighting for safety and security – all entrances and travel/parking areas. <i>Lighting plan addresses concerns.</i>
Public Works	See City Engineer comments above.
Building	A preliminary review of the applicable code references including area, occupant load, egress requirements, use and occupancy classification, etc all seem to be correct.
Ingham County Drain Commission	SESC Permit application has been submitted and is in review.
Ingham County Road Department	(New) See letter received August 10, 2021. Copy of Traffic Study requested.
Michigan Department of Transportation (MDOT)	None
Michigan Department of Environment, Great Lakes, and Energy (EGLE)	EGLE PERMIT NO. WRP030048 V1.0 was issued on 8/3/2021
Federal Aviation Administration (FAA)	Review is pending.

STAFF REVIEW

Staff finds that the Site Plan <u>appears to meet</u> the standards for Final Site Plan Approval. This is based upon a review of the revised materials submitted. Staff has revised the sections below based upon the revised materials received.

Section 94-191(f) of the Mason Code provides the Basis of Determination for Special Use Permits.

Before approving a special use permit, the planning commission shall find by clear and convincing proof that the applicable standards set forth by this chapter shall be satisfied by the completion and operation of the proposed development. The planning commission shall review the particular circumstances and facts of each proposed use in terms of these standards and shall make written findings showing that such use shall:

STATUS/NOTE	REQU	IREMENT		
M = Appears to meet requirement; D = Does not appear to meet requirement; I = Information Needed; R				
= Recommendation; W = Waiver Requested; Italics = Staff comments				
M	(1)	Be designed, constructed, operated, and maintained so as to be harmonious		
		and appropriate in appearance with the existing or intended character of the		
		general vicinity and that such a use will not change the essential character of		
		adjacent property or the zoning district in which it is proposed.		
The location is d	urrentl	y zoned M-2 General Manufacturing District. The zoning and future land use of		
the surrounding	proper	ties ranges from manufacturing and commercial to residential as indicated in the		
zoning table on	page 3	of this report. It appears that these criteria will be met related to the proposed		
placement of th	e above	ground propane storage tanks. Tanks on the east side of the building are not		
generally visible	from ti	he road; tanks on the southwest corner of the property are screened by a		
berm/landscapi	ng from	the road.		
M	(2)	Not be hazardous or disturbing to uses in the same general vicinity and will be		
		a substantial improvement to property in the immediate vicinity and to the		
		community as a whole.		
The proposed a	above g	round propane storage tanks will be placed away from the building across the		
travel lane and	protect	ed by bollards and fence. This is an improvement in safety to the property		
M	(3)	Be served adequately by essential facilities and services, such as highways,		
		streets, police and fire protection, drainage structures, refuse disposal, water		
		and sewage facilities, and schools.		
The site is curre	ntly ade	equately served by essential facilities and services.		
M	(4)	Not create additional requirements at public cost for public facilities and		
		services.		
Staff is not awa	re of an	y additional requirements related to the above ground propane storage tanks.		
M	(5)	Not involve uses, activities, processes, materials, and equipment or conditions		
		of operation that will be detrimental to any person, property, or the general		
		welfare by noise, fumes, glare, or odors.		
		t the proposed location and continued use of the above ground propane storage		
tanks will cause a detriment of this nature.				
M	(6)	Not be located such that it will directly or indirectly have a substantial adverse		
		impact on the natural resources of this city.		
Staff is not aw	are of	any conditions associated with this project that would create any substantial		
adverse impact.				
M	(7)	Be in compliance with other applicable local, county, state, or federal rules and		
		regulations.		
The applicant is responsible for pursuing the necessary county, state, or federal approvals and permits				
related to the in	stallati	on of the above ground propane storage tanks in addition to this local SUP.		

§94-227. **Standards for site plan review and approval**. In reviewing an application for site plan review and approval the following standards shall apply:

STATUS/NOTE	REQUIREMENT			
M = Appears to	meet requirement; D = Does not appear to meet requirement; I = Information Needed; R =			
Recommendation; W = Waiver Requested; <i>Italics = Staff comments</i>				
M	(1) The site shall be developed so that all elements shall be harmoniously and			
	efficiently organized in relation to the size, shape, type and topography of the site and			
	surrounding property.			
The site appear	rs to be harmonious and efficiently organized. The new building addition is appropriately			
	e remainder of the building and along with the new service lane will improve traffic			
	oughout the site. The changes are integrated with the topography and appear to be			
	h surrounding properties. See parking and sidewalk discussion below.			
M	(2) The site shall be developed so as not to impede the normal and orderly			
	development, improvement, and use of surrounding property for uses permitted in this			
	chapter.			
The new addition	on and service drive does not appear to impact the uses of surrounding property.			
M	(3) All buildings or groups of buildings shall be arranged to permit emergency vehicle			
	access by some practical means to all sites.			
The service driv	e extension will improve emergency vehicle access to the building. Sheet C2.02 satisfies the			
City Engineer's	previous email requesting information regarding the staging plan for maintaining			
emergency vehi	icle access during construction.			
M	(4) Every structure or dwelling unit shall have direct access to a public street or indirect			
	access to a public street via an approved dedicated private street.			
The site has ac	cess on a public street to the north (Kipp) and a private street to the south (Trillium) and			
meets this criter				
M	(5) Appropriate measures shall be taken to ensure that the addition or removal of			
	surface waters will not adversely affect neighboring properties, that controls are in place			
to minimize sedimentation and erosion, and that topographic alterations are minimized				
	to accommodate storm water management.			
The site will be subject to requirements of the Ingham County Drain Commission. A revised Storm Water				
,	greement with the City will be required and storm drains must be sealed inside the building			
	e City Engineer's previous email and indicated on Sheet C5.2 Note #6.			
M	(6) Provisions shall be made for the construction of storm sewer facilities including			
	grading, gutters, piping, on-site storage, and treatment of turf as required to handle			
	stormwater and prevent erosion.			
Same as previou				
M	(7) Secondary containment for above ground areas where hazardous substances are			
	stored or used shall be provided as required by the city fire chief.			
Above ground propane storage tanks are being relocated and are subject to a Special Use Permit. The plans				
	fy this requirement.			
M	(8) Exterior lighting shall be designed and located so that the source of illumination is			
	directed away from adjacent properties, the intensity of lighting is the minimum			
	necessary, and the direction of lighting is downward as much as is possible and			
A / / /	appropriate for the project.			
	plan demonstrating that site lighting be consistent with the lighting requirements listed in			
Section 94-177	(e) of the zoning ordinance has been provided on Sheet E2.0 and appears to meet this			

requirement.

M	(9) All loading and unloading areas, outside storage areas, and refuse receptacles shall			
	be screened from casual view from the public rights-of-way and adjoining land uses.			
The revised plans appear to satisfy the requirements of Sec. 94-293 and 94-173(b).				
M	(10) Site plans shall meet the driveway, traffic safety, and parking standards of the city			
	in such manner as necessary to address the following:			
	a. Safe and efficient vehicular and non-vehicular circulation, including parking areas,			
	non-motorized linkages to abutting parcels, uses, sidewalks, and trails.			
	b. Shared driveways and service drives.			
	c. Adequate and properly located utilities.			

PARKING – Parking is based upon USABLE FLOOR AREA (UFA) which is defined in Sec. 1-2. The plan has been revised to accurately reflect calculations based upon UFA. Pursuant to Section 94-292(g)(2) the Planning Commission may defer parking space requirements only where the applicant has demonstrated that the required parking standards is excessive. Given the employee traffic data supplied on sheet C2.01 and that no increase in employees is anticipated, staff recommends granting the waiver and allowing the deferment. Revised Sheet C2.0 shows a designated future parking bank with detail provided on a separate sheet for 91 spaces, 20% measuring 9x20 as allowed. For 423 parking spaces, the Americans with Disabilities Act (ADA) requires a total of nine (9) handicap parking spaces, 2 of which must meet the standards for a van. Staff will add a condition for approval that existing spaces be converted to handicap parking as required prior to obtaining Certificate of Occupancy.

SIDEWALKS - The City is holding \$4,500 which was received from Gestamp after the 2012 expansion (PC Resolution 2011-03) as security for the completion of the sidewalk. As discussed in the Memo dated Sept. 26, 2011 and the City Engineer's email, due to a shallow gas line at the corner, an alternative sidewalk connection is necessary. Per Sheets C2.0 and C3.1, the site plan has been amended to accommodate the remaining sidewalk, to be installed by Gestamp. Upon completion, Gestamp will grant a sidewalk easement to the City for the purpose of future maintenance, and the City will refund the money being held.

TRAFFICE, DRIVEWAYS AND SERVICE DRIVES – Sheet C2.01 provides revised traffic counts and a circulation plan. The plan proposes a second access point along Trillium Drive. There appears to be no record of a Traffic Study done previously per Sec. 94-176(g) which is required for both a second drive and for 100 trips generated during a peak hour. The County Road Department has also requested a copy of the traffic study. The requirement for completion of a traffic study will be added as a condition for approval to be completed prior to obtaining a Certificate of Occupancy.

UTILITIES – The plan appears to meet the requirements for utilities and has satisfied the concerns in the City Engineer's previous email contained in the August 10, 2021 packet.

Engineer's previous email contained in the August 10, 2021 packet.				
M	(11) Provisions shall be made for proposed common areas and public features to be			
	reasonably maintained.			
The revised plan	n indicates that a sidewalk easement will be granted to the City of Mason for the connection			
in the northwest corner of the property at the corner of Kipp and Hull roads.				
See below	(12) The site plan submittal shall demonstrate compliance with all applicable			
	requirements of this chapter, chapters 58 and 74, the building code, and county, state,			
	and federal law.			
M	Chapter 94 – Zoning and Chapter 100 – Dimensional Requirements			
The plan appears to the meet the building height, setbacks and lot coverage site development standards				
listed in Section 94-121(c) and Tables 100-1 and 100-2 as noted on the plan sheets.				
M	Sec. 94-172(3) Vision clearance across corner lot.			
The proposed plan appears to meet the requirements for vision clearance where the drives intersect with				

The proposed plan appears to meet the requirements for vision clearance where the drives intersect with the roads. There appear to be no obstructions caused by landscaping or signage.

D/R Sec. 94-241 Landscape, screening and buffer requirements

The applicant has requested waivers from the landscaping requirements as shown on Sheet L1.0. The Planning Commission may choose to waive the requirements as requested so long as the intent to provide landscaping within parking areas, and to enhance aesthetic and ecological qualities, character, privacy, and land value is met. The Planning Commission has the option to accept the proposed plan and waive the requirements for the landscaping pursuant to Section 94-241 (e)(6), or require the plan to be revised with the required vegetation. Due to the significant natural buffer to the east, the berm on the west, and the proposed addition of trees around the pre-existing parking area where no changes to parking are proposed, staff recommends granting the waivers.

M Chapter 58 - Signs

No new or expanded freestanding sign is proposed. Any proposed signage will require a separate building permit subject to the requirements of Chapter 58 of the Zoning Ordinance, including Division 2 of said chapter.

The applicant has submitted a Final Site Plan that, with the requested waivers and conditions, appears to meet the requirements for approval of a Special Use Permit with joint Preliminary/Final Site Plan approval for the above ground propane storage tanks, and for approval of a Final Site Plan for the proposed 49,200 sq. ft. building addition.

Therefore, the following motions are offered for consideration:

MOTION 1 – SPECIAL USE PERMIT FOR ABOVE GROUND PROPANE STORAGE TANKS

Motion to approve Resolution 2021-04.

MOTION 2 – FINAL SITE PLAN FOR 49,200 S.F. BUILDING ADDITION

Motion to approve Resolution 2021-05.

Attachments:

- 1. Letter from Ingham County Road Department dated
- 2. Revised Site Plan set
- 3. Parking detail for proposed designated parking bank.
- 4. Click here to access the full August 10, 2021 Planning Commission packet

Introduced: Second:

CITY OF MASON PLANNING COMMISSION RESOLUTION No. 2021-04

A RESOLUTION GRANTING A SPECIAL USE PERMIT AND JOINT PRELIMINARY/FINAL SITE PLAN APPROVAL FOR ABOVE GROUND PROPANE STORAGE TANKS ON PROPERTY LOCATED AT 200 E. KIPP RD, PARCEL 33-19-10-16-100-024.

August 25, 2021

WHEREAS, a request has been received from Alan Boyer, LSG Engineers & Surveyors, on behalf of Gestamp Mason, LLC, for approval of a Special Use Permit and joint Preliminary and Final Site Plan Approval for above ground propane storage tanks and,

WHEREAS, the subject property is located at 200 E. Kipp Rd, parcel 33-19-10-16-100-024; and,

WHEREAS, the proposal was shown on application materials originally provided on July 6, 2021 and revisions submitted on August 16, 2021; and,

WHEREAS, the parcel is zoned M-2 General Manufacturing District; and

WHEREAS, Section 94-152(d)(1) states that a Special Use Permit is required for Above ground storage of flammable liquids or combustible materials in an M-2 General Manufacturing District; and,

WHEREAS, Section 94-222(4) states that any use permitted by a Special Use Permit requires site plan review; and

WHEREAS, a public hearing on the request was noticed and held at the Planning Commission's regular meeting on August 10, 2021 with testimony given and public comment solicited in accordance with Section 94-101 of the Mason Code; and

WHEREAS, the Planning Commission has received, reviewed and accepts the staff report dated August 19, 2021, as findings of fact that the use will comply with the Special Use Permit Review Standards listed in Section 94-191(f) of the Mason Code, and Site Plan Review Standards listed in Section 94-227.

NOW THEREFORE BE IT RESOLVED, that the City of Mason Planning Commission does hereby grant a Special Use Permit and joint Preliminary/Final site plan approval with no further conditions.

Yes (0) No (0) Absent (0)

CLERK'S CERTIFICATION: I hereby certify that the foregoing is a true and accurate copy of a resolution adopted by the City of Mason Planning Commission at its special meeting held Wednesday, August 25, 2021, the original of which is part of the City of Mason Planning Commission minutes.

Sarah J. Jarvis, Clerk
City of Mason
Ingham County, Michigan

Introduced: Second:

CITY OF MASON PLANNING COMMISSION RESOLUTION No. 2021-05

A RESOLUTION GRANTING APPROVAL OF A FINAL SITE PLAN FOR CONSTRUCTION OF A NEW 49,200 SQ. FT. ADDITION ON AN EXISTING 624,780 SQ. FT. BUILDING TO BE USED AS A FINISH GOODS PRODUCT STORAGE (LOW BAY) AND TO PERFORM OTHER RELATED SITE IMPROVEMENTS ON PROPERTY LOCATED AT 200 E. KIPP RD, PARCEL 33-19-10-16-100-024.

August 25, 2021

WHEREAS, a request has been received from Alan Boyer, LSG Engineers & Surveyors, on behalf of Gestamp Mason, LLC, for approval of an amendment to a previously approved Final Site Plan for the construction of a new 49,200 sq. ft. addition on an existing 624,780 sq. ft. building to be used as a Finish Goods Product Storage (Low Bay) and to perform other related site improvements; and,

WHEREAS, the subject property is located at 200 E. Kipp Rd., parcel 33-19-10-16-100-024; and,

WHEREAS, the proposal was shown on application materials originally provided on July 6, 2021 and revisions submitted on August 16, 2021; and,

WHEREAS, the parcel is zoned M-2: Manufacturing District; and

WHEREAS, Sec. 94-228(b) states that an amendment to a site plan which, in the opinion of the zoning official, represents a material change shall be referred to the planning commission for review and approval if the planning commission exercised original approval; and

WHEREAS, the Planning Commission has received, reviewed and accepts the staff report dated August 19, 2021 as findings of fact that, with the waivers and conditions listed herein, the plans will comply with the Final Site Plan Review Standards listed in Section 94-227; and

WHEREAS the Planning Commission further makes the following findings of fact:

- The applicant has demonstrated that the required amount of parking is excessive and qualifies for a
 waiver of the parking requirement to allow the deferment of the expansion of parking to the area
 indicated as Designated Parking Bank as shown on the plan; and
- The Planning Commission finds that the proposed future parking bank meets the minimum requirement for spaces, the minimum requirement is greater than 40 spaces, making the new area eligible to allow 20% of the parking spaces to measure 180 s.f. each.
- The proposed landscaping plan will meet the intent to provide landscaping within parking areas, and
 to enhance aesthetic and ecological qualities, character, privacy, and land value as demonstrated by
 the significant natural buffer to the east, the berm on the west, and the proposed addition of trees
 around the pre-existing parking area.

NOW THEREFORE BE IT RESOLVED, that the City of Mason Planning Commission does hereby grant of an amendment to a previously approved Final Site Plan for the construction of a new 49,200 sq. ft. addition on an existing 624,780 sq. ft. building to be used as a Finish Goods Product Storage (Low Bay) and to

Sarah J. Jarvis, Clerk City of Mason Ingham County, Michigan perform other related site improvements for property located at 200 E. Kipp Rd., parcel 33-19-10-16-100-024 with the following conditions and waivers:

- 1. The applicant will provide the necessary easements to the City of Mason for the future installation and maintenance of sidewalks and shall be 10' in width.
- 2. The applicant will provide a drainage facilities maintenance agreement to the City of Mason prior to the issuance of a certificate of occupancy.
- 3. The applicant will provide a record drawing for the site documenting conformance with the approved site plan and ADA parking standards prior to the issuance of a certificate of occupancy.
- 4. The applicant will provide a Traffic Study that meets the requirements of Sec. 94-176(g) of the City of Mason Ordinance prior to the issuance of a certificate of occupancy.
- 5. The applicant has demonstrated that the required amount of parking is excessive and may defer expansion of parking in the area indicated as Designated Parking Bank with 20% of the proposed spaces measuring 180 s.f.
- 6. The proposed landscaping plan will meet the intent to provide landscaping within parking areas, and to enhance aesthetic and ecological qualities, character, privacy, and land value as demonstrated by the significant natural buffer to the east, the berm on the west, and the proposed addition of trees around the pre-existing parking area; therefore, the remaining requirements of Sec. 94-241 are waived.

Yes (0) No (0) Absent (0)

CLERK'S CERTIFICATION: I hereby certify that the foregoing is a true and accurate copy of a resolution adopted by the City of Mason Planning Commission at a Special Meeting held Wednesday, August 25, 2021, the original of which is part of the City of Mason Planning Commission minutes.


Sarah J. Jarvis, Clerk
City of Mason

Ingham County, Michigan

INGHAM COUNTY ROAD DEPARTMENT

AUSTIN E. CAVANAUGH ADMINISTRATION BUILDING 301 Bush Street, P.O. Box 38, Mason, MI 48854-0038

William M. Conklin, PE Managing Director

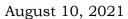

Ms. Elizabeth Hude Community Development Director City of Mason 201 W. Ash Street Mason, MI 48854

Via Email

RE: Gestamp Expansion

Dear Ms. Hude:

The Ingham County Road Department (ICRD) is providing the following comments on the proposed Gestamp Expansion located at the corner of Kipp Road and Hull Road based on the following information provided for our review:

o Plans prepared by LSG Engineers & Surveyors dated May 24, 2021

Comments:

The following comments reference requirements set forth in the Ingham County Road Department (ICRD) Rules, Standards and Procedures for Driveways, Banners and Parades:

- 1. Has a traffic impact study been prepared for this site? Please provide a copy to the Road Department as soon as possible for review. The study should incorporate the intersections of Kipp Rd/Hull Rd, Kipp Rd/Cedar St and Hull Rd/Trillium Dr in addition to analyzing the traffic impacts at the driveway access points on Kipp Road and Trillium Drive.
- 2. The only work that appears to be occurring within the road right of way is the connection of the internal site sidewalk to the public sidewalk along Hull Road, which will require a permit from the Road Department as described below.
- 3. Any work proposed within the public road right-of-way will require approval by the County Highway Engineer and the issuance of the applicable ICRD permit. The right-of-way permit application is available online at roads.ingham.org on the "Permits" section of the website. Please submit a ROW permit application, \$500 site plan review fee, a \$150 right-of-way permit fee, updated plans (if applicable) and traffic control plans (if applicable). The contractor insurance should be submitted once the contractor has been selected. Please note, no work may be performed within the road ROW until a permit has been issued by the ICRD.

Telephone: (517) 676-9722 E-Mail: roads@ingham.org Web Site: http://roads.ingham.org
An Equal Opportunity Employer

The above consists of preliminary comments based on limited information. The ICRD reserves the right to comment further when a complete permit application is submitted. Should you have questions or need clarification on the above information, please contact me via email at kjones2@ingham.org.

Sincerely,

Kelly R. Jones, PE

Director of Engineering & County Highway Engineer

INGHAM COUNTY ROAD DEPARTMENT

cc: Swanson, Knauff - Ingham County Road Department

File


GESTAMP 2021 EXPANSION

200 EAST KIPP ROAD MASON, MICHIGAN 48854

LOCATION MAP

SCALE: 1"=2000'

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	<i>,</i> ,%
(P) SPOT ELEVATION	\$ 00.
(P) 1' CONTOUR	851
(P) 5' CONTOUR	850
(P) GAS LINE	——————————————————————————————————————
(P) TELEPHONE LINE	——T——T——T—
(P) ELECTRIC LINE	——Е——Е——Е—
(P) STORM DRAIN	
(P) SANITARY SEWER	
(P) WATER MAIN	
(P) CHAIN LINK FENCE	xxx
(P) WOOD FENCE	
(P) GUARD RAIL	
(P) FIRE HYDRANT ASSEMBLY	.
(P) WATER MAIN VALVE	•
(P) WATER MAIN BEND	4
(P) WATER MAIN REDUCER	◀
(P) CURB INLET	
(P) CATCH BASIN	
(P) TRENCH DRAIN	
(P) FLARED END SECTION	>
(P) MANHOLE	•
(P) LIGHT POLE	
7- 2	C.O.
(P) SANITARY SEWER CLEANOUT	•
(P) UTILITY CROSSING	\circ
(P) BUILDING WALLPACK	•
(P) SIGN	-

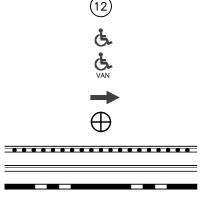

С	COVER
C1.0	AS BUILT SITE SURVEY - EXISTING CONDITIONS
C1.1	TOPOGRAPHIC SURVEY
C2.0	OVERALL SITE PLAN
C2.01	OVERALL SITE PLAN - TRAFFIC PLAN
C2.02	OVERALL SITE PLAN - CONSTRUCTION PHASING
C2.1	DETAILED DEMOLITION PLAN
C3.0	DETAILED SITE PLAN
C3.1	DETAILED SIDEWALK PLANS
C4.0	DETAILED GRADING PLAN
C5.0	DETAILED UTILITY PLAN
C5.1	FIRE MAIN PLAN AND PROFILE
C5.2	STORM DRAINAGE PLAN AND PROFILE
C6.0	MISCELLANEOUS DETAILS
C6.1	FIRE MAIN DETAILS
C6.2	STORM DRAINAGE DETAILS
C7.0	SOIL EROSION CONTROL PLAN

SOIL EROSION CONTROL DETAILS

SOIL EROSION CONTROL NOTES

LANDSCAPE PLAN

SITE PHOTOMETRIC PLAN

PREPARED FOR: Gestamp 🜽 200 EAST KIPP ROAD MASON, MICHIGAN 48854 PHONE: (517) 244-8800

REVISED PER REVIEW COMMENTS FOR SITE PLAN REVIEW AND PERMITS

DESCRIPTION

REVISIONS/SUBMITTALS

DATE

PREPARED FOR:

WEILAND

4162 ENGLISH OAK DRIVE LANSING, MICHIGAN 48911 PHONE: (517) 372-8650



3135 PINE TREE ROAD SUITE D LANSING, MI 48911 PH. (517) 393-2902 FAX (517) 393-2608 www.lsg-es.com



GENERAL

1. BENCHMARKS

- #1. Northwest flange bolt on fire hydrant, 204'± North and 93'± West of the Northeast corner of building. Elevation: 908.84 (NAVD 88)
- #2. Northwest flange bolt on fire hydrant, 81'± West and 66'± South of the Northeast corner of building. Elevation: 915.75 (NAVD 88)
- #3. Northwest flange bolt on fire hydrant, 88'± West and 494'± South of the Northeast corner of building. Elevation: 912.53 (NAVD 88)
- 2. The contractor shall call "MISS DIG" at 1-800-482-7171 at least 3 working days (excluding weekends and holidays) prior to construction.
- 3. All work shall be done in accordance with the applicable codes, ordinances, design standards and standard specifications of the following agencies which have the responsibility of reviewing plans and specifications for construction of all items included in these plans:
 - a. City of Mason b. Ingham County
 - c. State of Michigan
- 4. The contractor shall apply for and obtain all necessary permits as required for construction of this project prior to the beginning of work from the previously mentioned
- 5. The contractor shall notify the City of Mason a minimum of 24 hours prior to any construction in the road right-of-way of Kipp Road and Hull Road.
- 6. The contractor agrees that in accordance with generally accepted construction practices, the contractor will be required to assume sole responsibility for job site conditions during the course of construction of the project, including the safety of all persons and property. This requirement shall be made to apply continuously and not be limited to normal working hours.
- 7. The locations and dimensions shown on the plans for existing facilities are in accordance with all available information. The engineer does not guarantee the accuracy of this information or that all existing underground facilities are shown.
- 8. When any existing utility requires adjustment or relocation, the contractor shall notify the proper utility company and coordinate the work accordingly. There shall be no claim made by the contractor for any costs caused by delays in construction due to the adjustment or relocation of
- 9. The contractor is to verify that the plans and specifications that he/she is building from are the very latest plans and specifications that have been approved by all applicable permit—issuing agencies and the owner. All items constructed by the contractor prior to receiving the final approval and permits having to be adjusted or re-done, shall be done at the contractor's expense.
- 10. Should the contractor encounter conflict between these plans and specifications, either among themselves or with the requirements of any and all reviewing and permit—issuing agencies, he/she shall seek clarification in writing from this engineer before commencement of construction. Failure to do so shall be at the sole expense to the contractor
- 11. Unless otherwise noted the contractor shall furnish as—built drawings indicating all changes and deviations from approved drawings.
- 12. All signs and traffic control measures during construction and maintenance activities shall be constructed and installed per the latest edition of the Michigan Manual of Uniform Traffic Control Devices (M.M.U.T.C.D.).
- 13. LSG Engineers & Surveyors will not be responsible for field design changes made by the contractor or the contractor's surveyor where LSG Engineers & Surveyors has not approved these design changes.

GRADING AND SITE WORK

- 1. Prior to grading, cutting and filling the contractor shall remove all topsoil, debris, vegetation, etc. from the site. Acceptable material excavated from the cut areas shall be used for fill. Fill shall be placed in layers not exceeding depths of 12 inches and shall be compacted to 95% of its maximum unit weight.
- 2. The contractor shall proof—roll the existing subgrade to determine its suitability. If, in the opinion of the engineer, the subgrade is unsuitable that portion of the subgrade shall be excavated and replaced with a minimum of 12" M.D.O.T. Class II granular material.
- 3. All site grading must be performed to insure positive drainage across the entire site, throughout the period of construction and after project completion.
- 4. All sedimentation and soil erosion control measures shall be constructed prior to the commencement of site grading and must conform to Part 91 of Act 451 of the Public Acts of 1994 as amended. All applicable permits shall be obtained before implementing these measures. The contractor shall be responsible for maintaining the sedimentation and soil erosion control measures throughout construction.

STORM DRAINAGE SYSTEM

- 1. Unless otherwise noted all storm drain pipe shall be ASTM C-76 Class III or better, with premium joints. All storm drain with less than 3 feet of cover below paved areas shall be ASTM C-76 Class IV, with premium joints.
- 2. All storm drain service leads shall be 4" minimum Schedule 40 or SDR-35 unless otherwise noted on these
- 3. All storm drain manholes and catch basins shall conform to the City of Mason Standard Details or the details included in these plans.
- 4. All storm drain below paved areas shall be backfilled with 100% granular material (or approved other) and compacted to 95% of its maximum unit weight (see typical trench details included in these plans).
- 5. All frames and covers on drainage structures shall be non-rocking, made of heavy duty cast iron and shall conform to the casting schedule on sheet C6.2.
- 6. All rim elevations in outlawn areas are approximate only and shall be adjusted by the contractor after final grades
- 7. See storm drain details on sheet C6.2.

WATER (FIRE) MAIN SYSTEM

- 1. All water (fire) main shall be DI CL52 unless otherwise noted on these plans.
- 2. All construction of the water main service system shall conform to the water main construction plans and specifications approved by the City of Mason.
- 3. All water main shall be installed with a minimum of 5.5 feet of cover from finished grades.
- 4. A full length of water main pipe shall be centered from the point of crossings of all sewers with a minimum vertical clearance of 1.5 feet. In the event a clearance of less than 1.5 feet is constructed, the intersection shall be
- 5. All elevations in outlawn areas are approximate only and shall be adjusted by the contractor after finish grades are
- 6. All water main within a 45° zone of influence of paved areas shall be backfilled with 100% granular material (or approved other) and compacted to 95% of its maximum unit weight (see typical trench details included in these
- 7. All water main shall have a minimum 10' horizontal separation from any storm or sanitary sewer.
- 8. All ductile iron water main pipe, fittings, and valves are to be encased within 8-mil thick polyethylene wrap.
- 9. Water main and fittings shall be installed with restrained
- 10. See water main details on sheet C6.1.

(E) SPOT ELEVATION

(E) 1' CONTOURS

(E) 5' CONTOURS

(E) TELEPHONE LINE

(E) ELECTRIC LINE

(E) STORM DRAIN

(E) WATER MAIN

(E) WOOD FENCE

(E) WATER WELL

(E) FIRE HYDRANT

(E) WATER VALVE

(E) SANITARY MANHOLE

(E) STORM MANHOLE

(E) CATCHBASIN

(E) CULVERT

(E) SIGN

(E) MAILBOX

(E) LIGHT POLE

(E) UTILITY POLE

(E) CONIFEROUS TREE

(E) DECIDUOUS TREE

(P) DRAINAGE SWALE

(P) DRAINAGE FLOW ARROW

(P) HEAVY DUTY ASPHALT AREA

(P) LIGHT DUTY ASPHALT AREA

(P) DRAINAGE BASIN BOUNDARY

(P) CONCRETE SURFACE

(P) AGGREGATE SURFACE

(P) BASIN DESIGNATION

(P) BASIN AREA IN ACRES

(P) SIDE SLOPE

(P) RIP RAP LOW POINT

HIGH POINT

FINISH FLOOR BENCHMARK

WATER SURFACE

GRADE BREAK

(E) SANITARY SEWER

(E) CHAIN LINK FENCE

(E) GAS LINE

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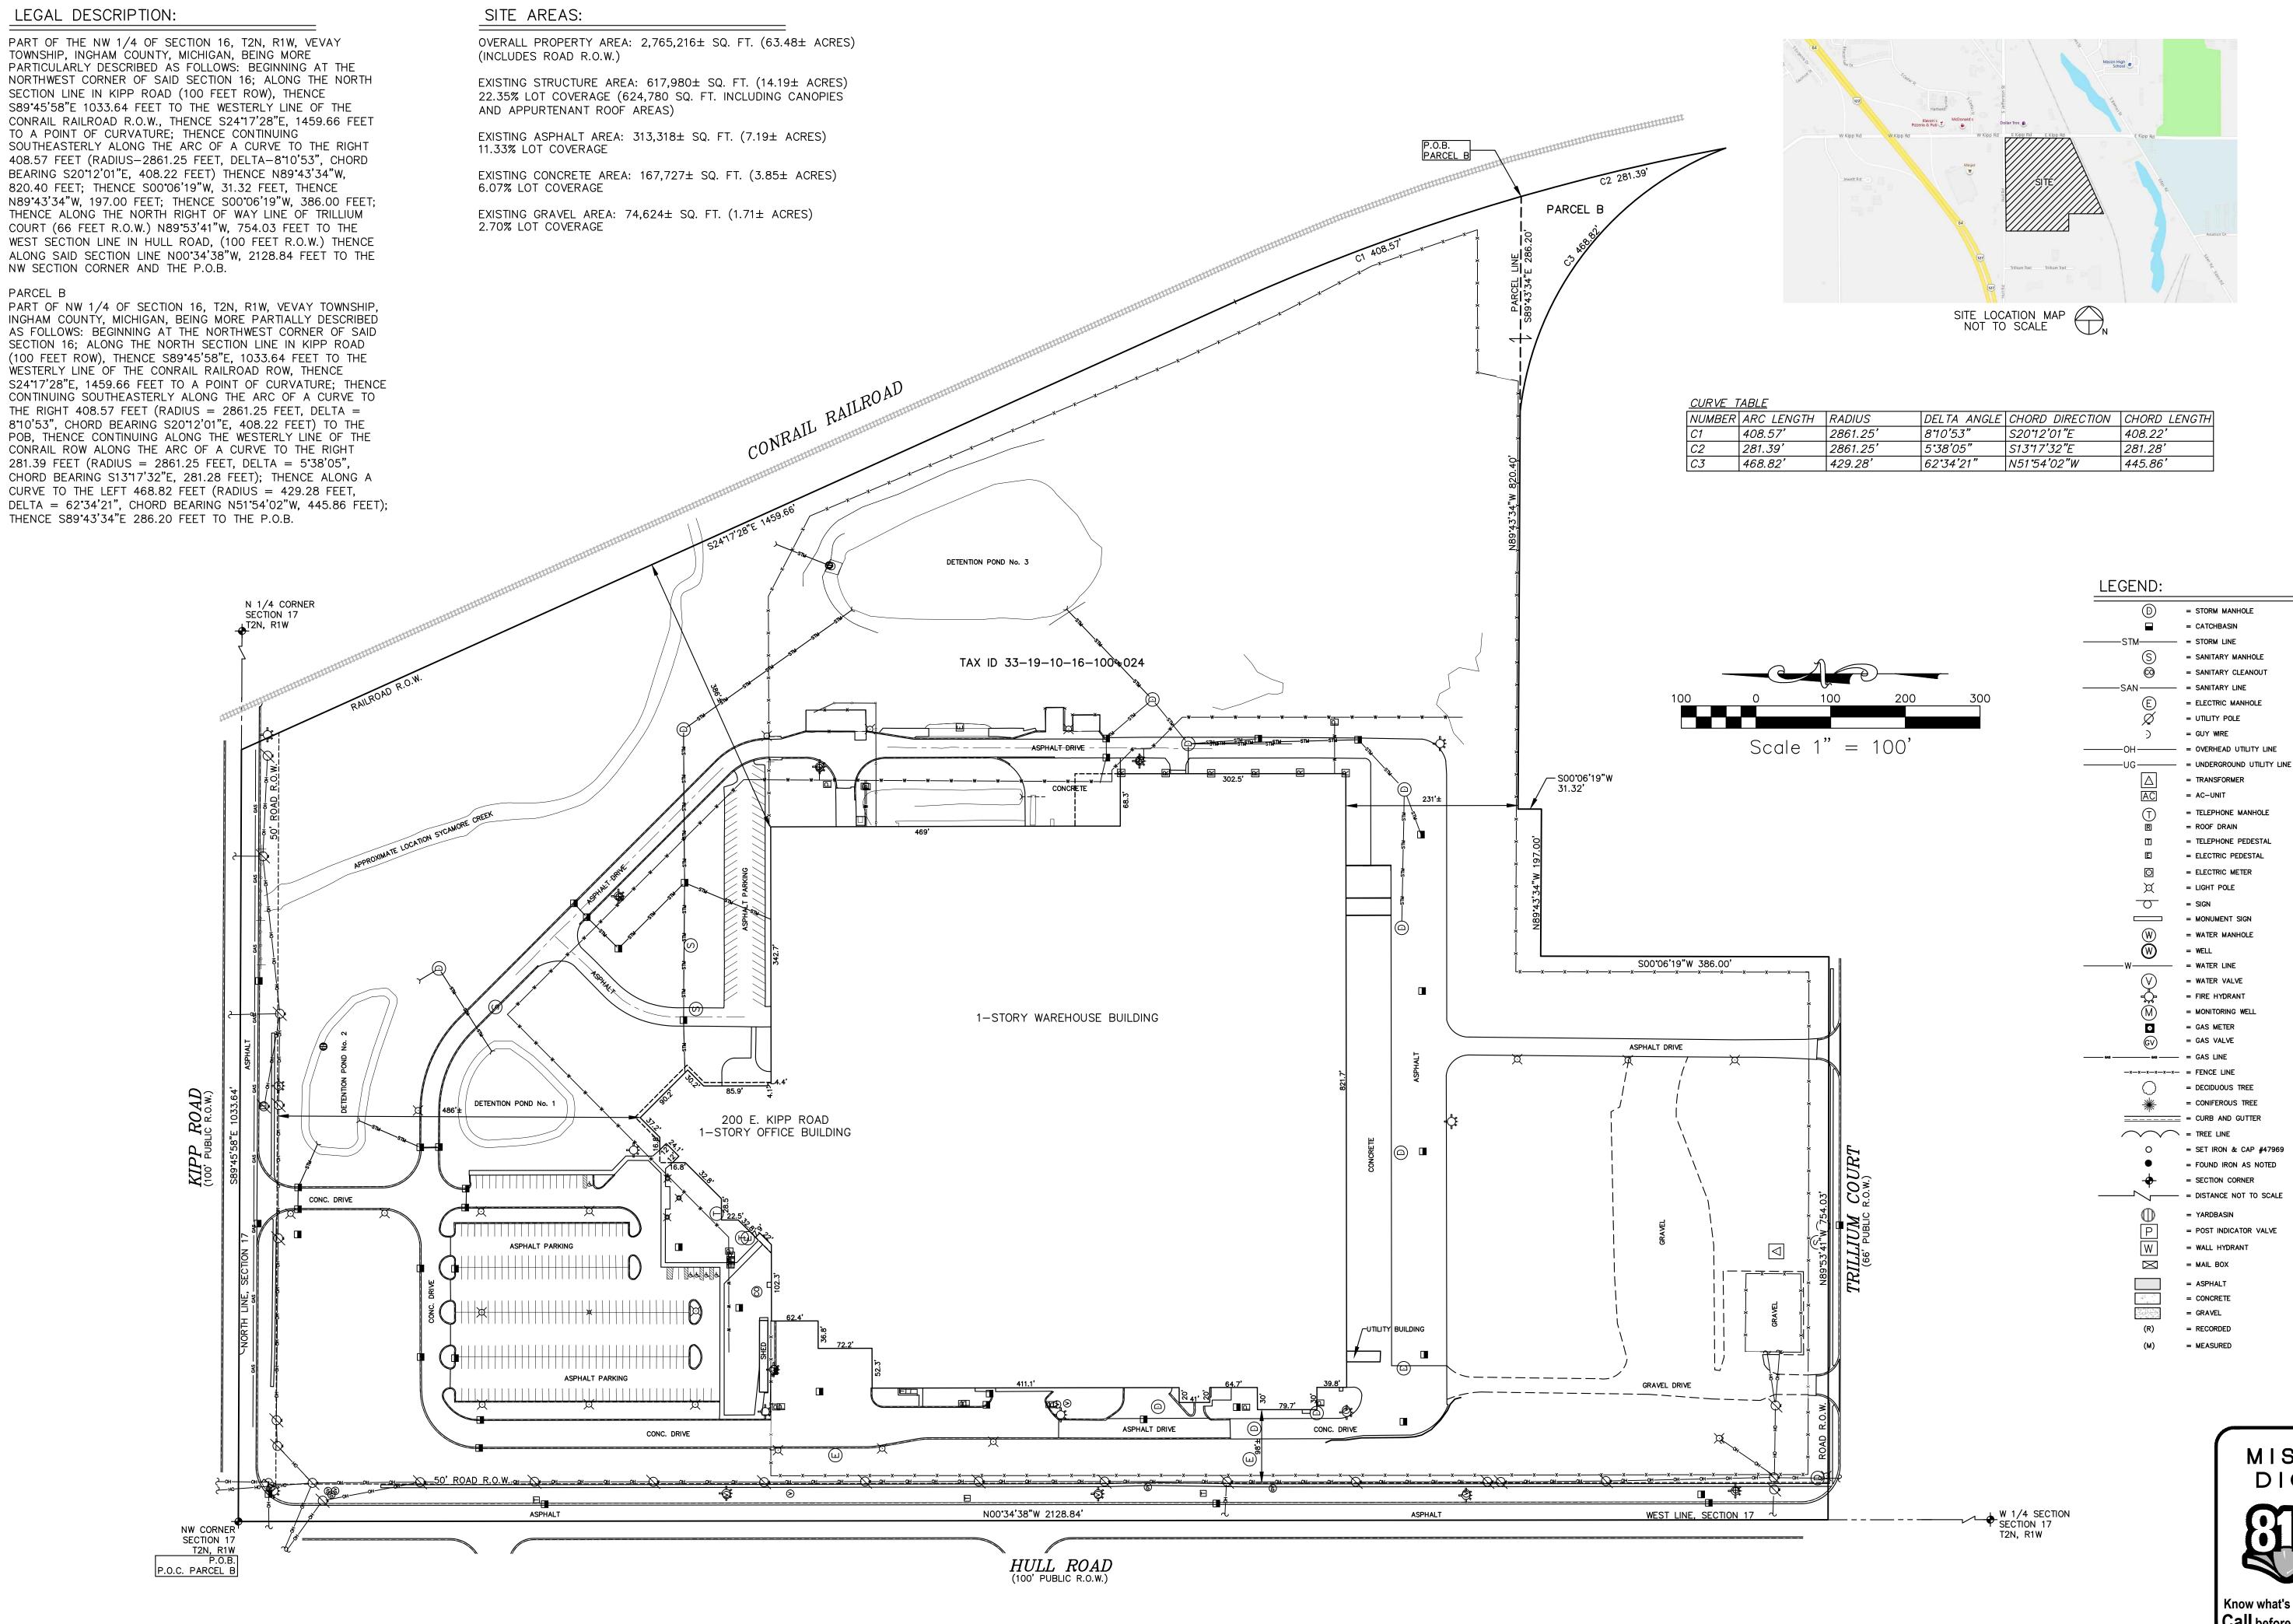
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(P) SCREEN WALL OR RETAINING WALL (E) - INDICATES EXISTING (P) - INDICATES PROPOSED

(P) TELEPHO (P) ELECTRIC

_____ 2.52



| P | SEP | P |

Engineers & Surveyors

3135 PINE TREE ROAD SUITE D LANSING, MI 48911 PH. (517) 393-2902 FAX (517) 393-2608 www.lsg-es.com

PREPARED FOR: Gestamp (

200 EAST KIPP ROAD MASON, MICHIGAN 48854 PHONE # (517) 244-8800



LANSING, MICHIGAN 48911 PHONE # (517) 372-8650

= SET IRON & CAP #47969 = FOUND IRON AS NOTED

= WALL HYDRANT

= STORM MANHOLE

= SANITARY MANHOLE

= SANITARY CLEANOUT

= ELECTRIC MANHOLE = UTILITY POLE = GUY WIRE

= AC-UNIT

= TELEPHONE MANHOLE = ROOF DRAIN

= TELEPHONE PEDESTAL = ELECTRIC PEDESTAL

= ELECTRIC METER

= MONUMENT SIGN = WATER MANHOLE

= WATER LINE

= GAS METER

= CONIFEROUS TREE

= SECTION CORNER

= WATER VALVE = FIRE HYDRANT = MONITORING WELL

= CATCHBASIN

= ASPHALT = CONCRETE = GRAVEL = RECORDED

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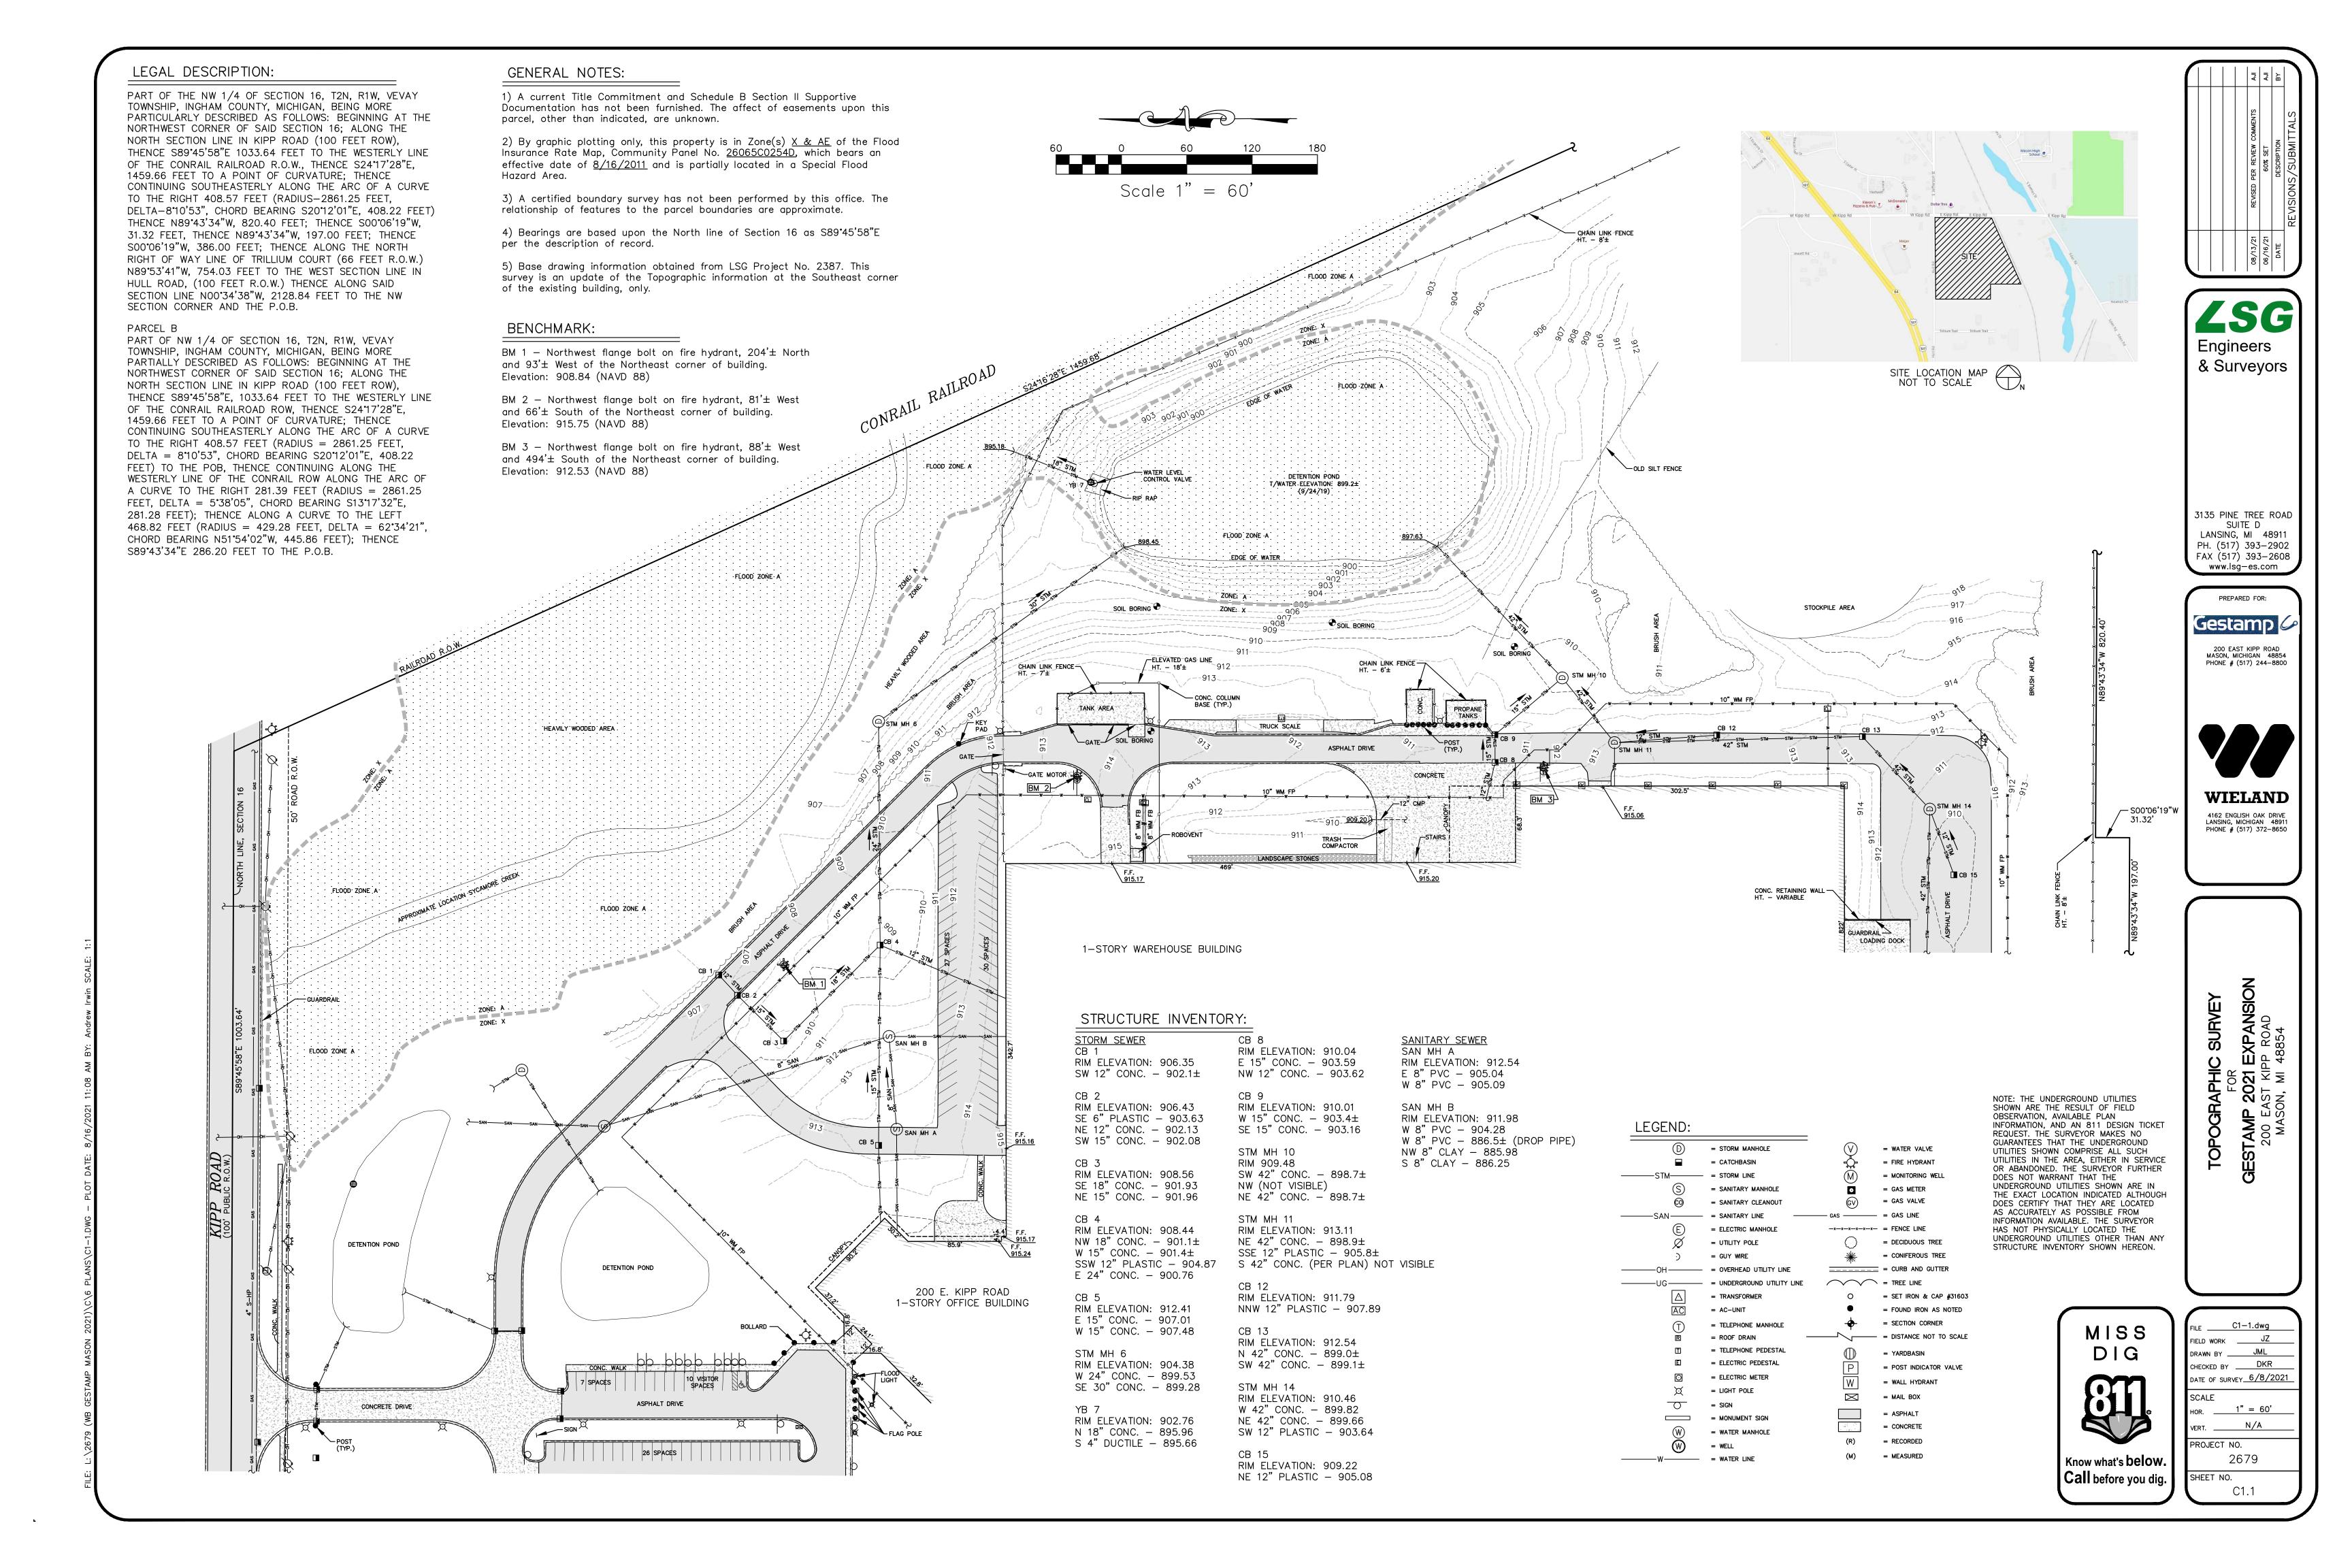



Know what's below. Call before you dig.

DRAWN BY _____JML CHECKED BY DKR DATE OF SURVEY 9/26/2019

2679 SHEET NO.

PROJECT NO.



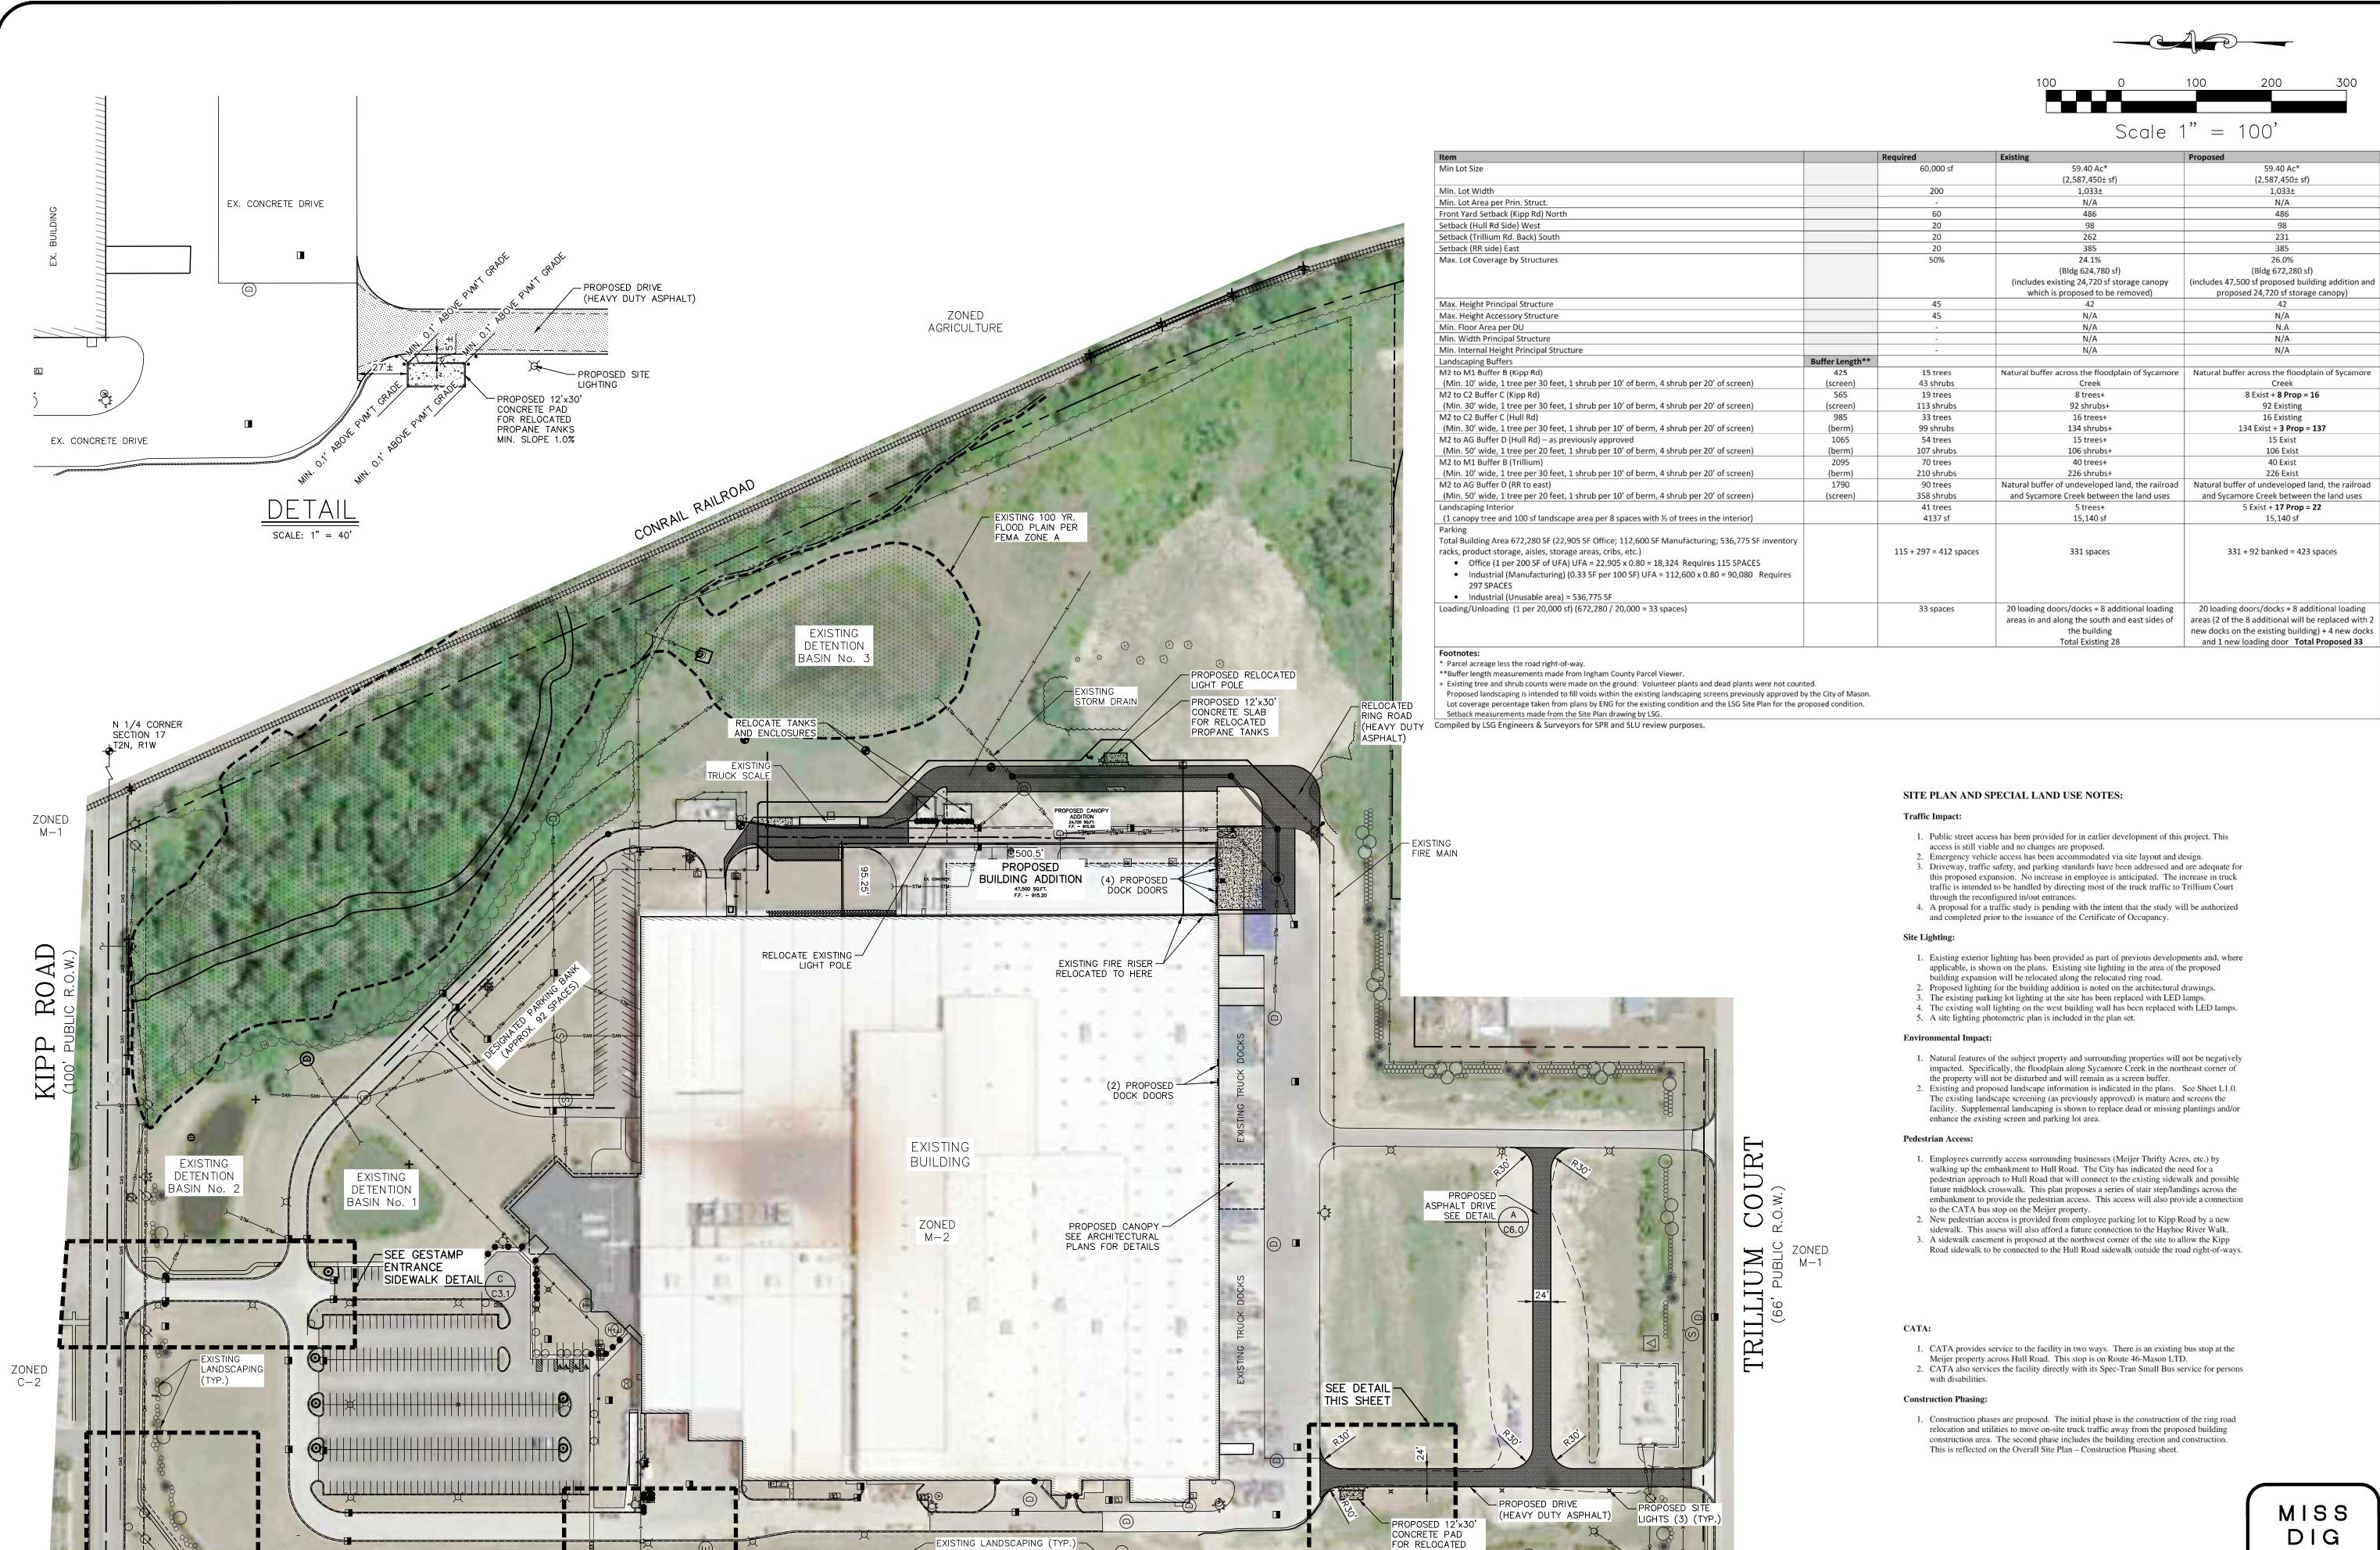

ZONED

C-2/AGRICULTURE

HULL ROAD

(100' PUBLIC R.O.W.)


SEE GESTAMP/ HULL A

SEE GESTAMP/NORTHWEST CORNER

SIDEWALK DETAIL D

ZONED

C-2

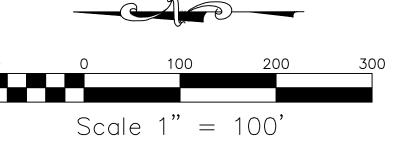

Engineers & Surveyors

3135 PINE TREE ROAD SUITE D LANSING, MI 48911 PH. (517) 393-2902 FAX (517) 393-2608 www.lsg-es.com

PREPARED FOR: **Jestamp**

200 EAST KIPP ROAD MASON, MICHIGAN 48854 PHONE # (517) 244-8800



4162 ENGLISH OAK DRIVE LANSING, MICHIGAN 48911 PHONE # (517) 372-8650





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110K	1"=100' N/A
PROJEC [*]	T NO.

2679

C2.0



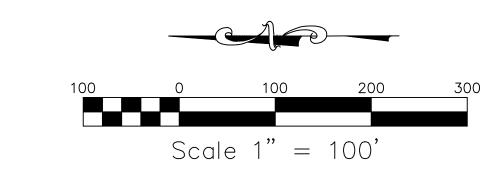

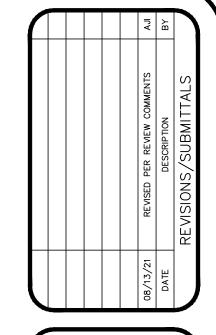Engineers

& Surveyors

3135 PINE TREE ROAD SUITE D LANSING, MI 48911 PH. (517) 393-2902 FAX (517) 393-2608 www.lsg-es.com

PREPARED FOR:

200 EAST KIPP ROAD MASON, MICHIGAN 48854 PHONE # (517) 244-8800

4162 ENGLISH OAK DRIVE LANSING, MICHIGAN 48911 PHONE # (517) 372–8650

Gestamp

EMPLOYEE TRAFFIC - AUTOS

Description	Time Frame	Arrivals	Departures	Comments
Shift change 3 rd /1 st	5:00 am – 6:00 am	138	80	218 trips
Arrival of salaried staff	6:00 am – 8:00 am	80	0	80 trips (average 40 per hour)
Shift change 1 st /2 nd	1:30 pm – 2:30 pm	116	128	244 trips (324 cars in parking lot at max occupancy)
	2:30 pm – 2:45 pm	0	10	10 trips (average 40 per hour)
Departure of salaried staff	4:00 pm – 6:00 pm	0	80	80 trips (average 40 per hour)
Shift change 2 nd /3 rd	9:30 pm – 10:30 pm	80	80	160 trips

Date Data Collected: Wednesday June 2, 2021

FREIGHT/DELIVERY TRAFFIC - TRUCKS

		CURRENT D	DAILY COUNTS			
	Monday	Tuesday	Wednesday	Thursday	Friday	Saturday
Kipp Rd. Entrance						
4:00AM to 8:30AM	2	2	2	2	2	1
8:30AM to 1:00PM	2	2	2	2	2	
1:00PM to 6:00PM	3	3	3	3	3	1
Kipp Rd. Daily Totals	7	7	7	7	7	2
Trillium St. Entrance						
Midnight to 4:00AM	18	18	18	16	18	16
4:00AM to 8:30AM	32	32	32	29	31	24
8:30AM to 1:00PM	37	38	38	38	37	24
2:00PM to 6:00PM	25	25	32	25	32	17
6:00PM to Midnight	17	17	18	16	17	16
Other					2	
Trillium St. Daily Totals	129	130	138	124	137	97
Current Grand Total	136	137	145	131	144	99

PROJECTED DAILY COUNTS						
	Monday	Tuesday	Wednesday	Thursday	Friday	Saturday
Kipp Rd. Entrance						
4:00AM to 8:30AM	2	2	2	2	2	1
8:30AM to 1:00PM	2	2	2	2	2	
1:00PM to 6:00PM	3	3	3	3	3	1
Kipp Rd. Daily Totals	7	7	7	7	7	2
Trillium St. Entrance						
Midnight to 4:00AM	24	25	25	22	26	22
4:00AM to 8:30AM	42	41	42	40	41	35
8:30AM to 1:00PM	48	49	49	49	47	35
2:00PM to 6:00PM	33	34	40	33	39	25
6:00PM to Midnight	22	21	22	20	22	20
Other					2	
Trillium St. Daily Totals	169	170	178	164	177	137
Projected Grand Total June 2022	176	177	185	171	184	139

Note: The counts shown are round trips. Each count includes one in and one out.




- EMPLOYEE/VISITORS CAR TRAFFIC

DIG

S j	FILE C2-01.DWG DESIGNED BY ADB DRAWN BY AJI CHECKED BY ADB DATE AUG. 12, 2021
	SCALE HOR1"=100' VERTN/A
elow.	PROJECT NO. 2679
	■ CHEET NO

C2.01


Know what's be Call before you dig.

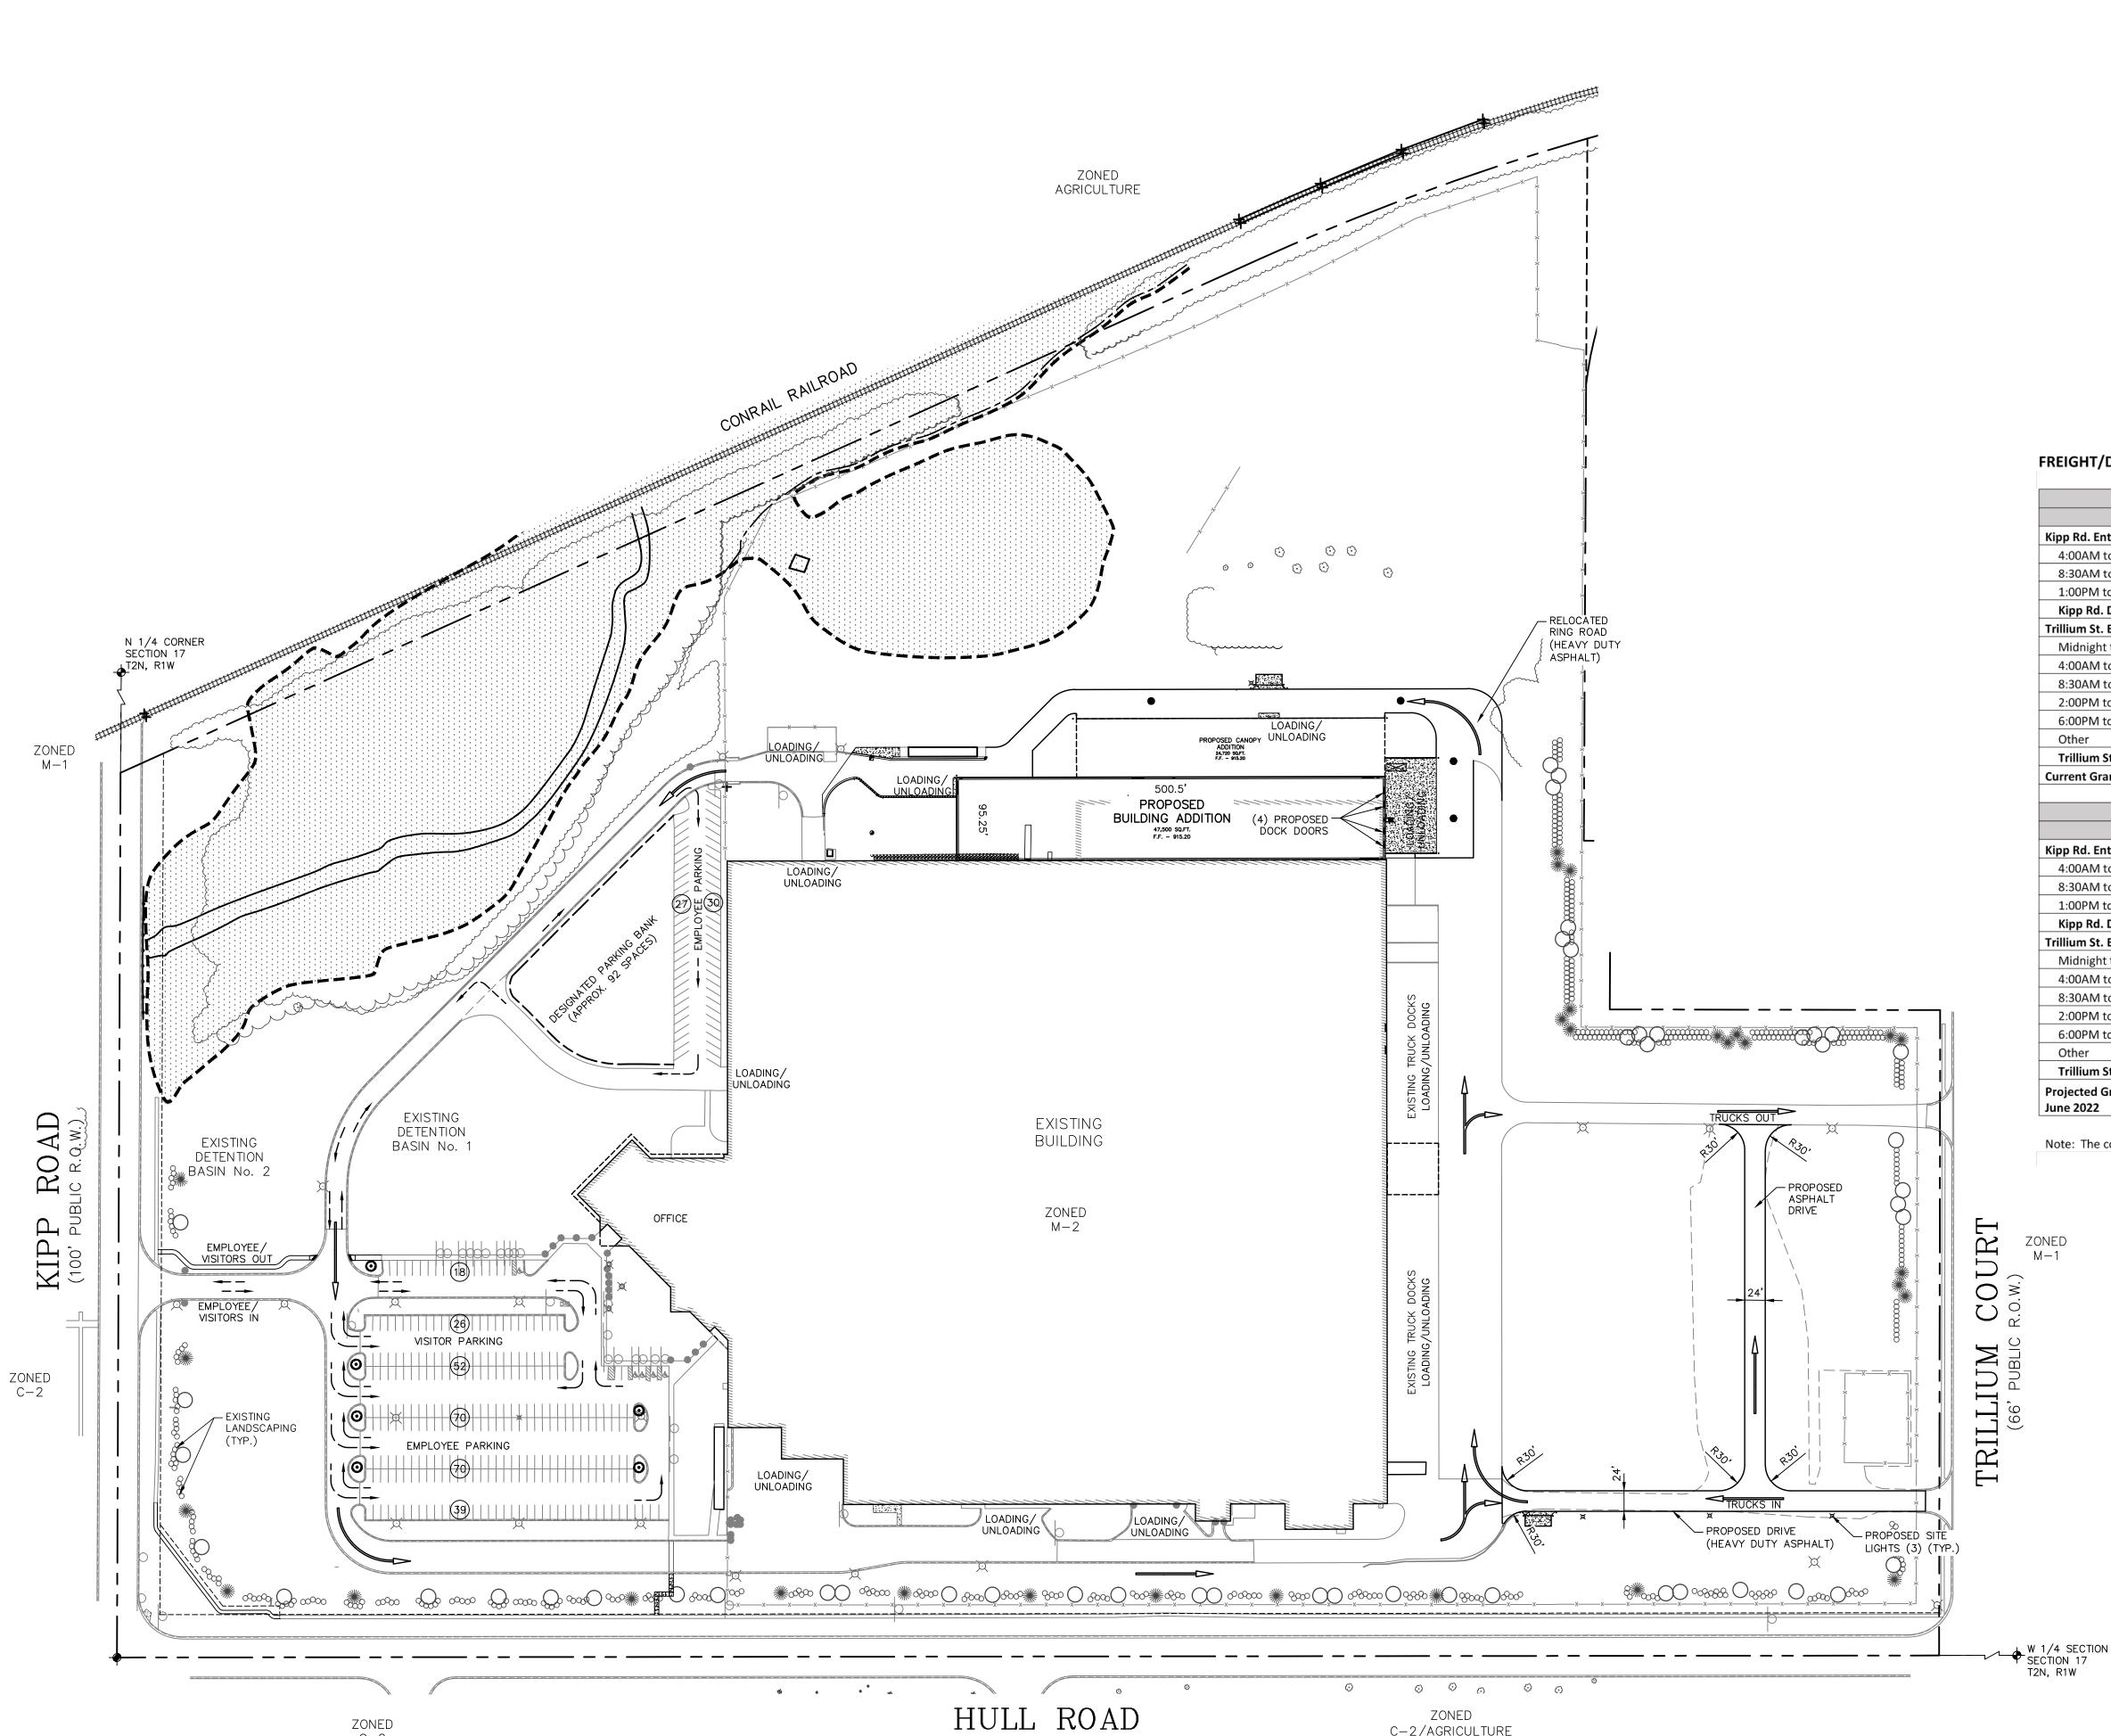



(100' PUBLIC R.O.W.)

ZONED C-2

ZONED C-2/AGRICULTURE

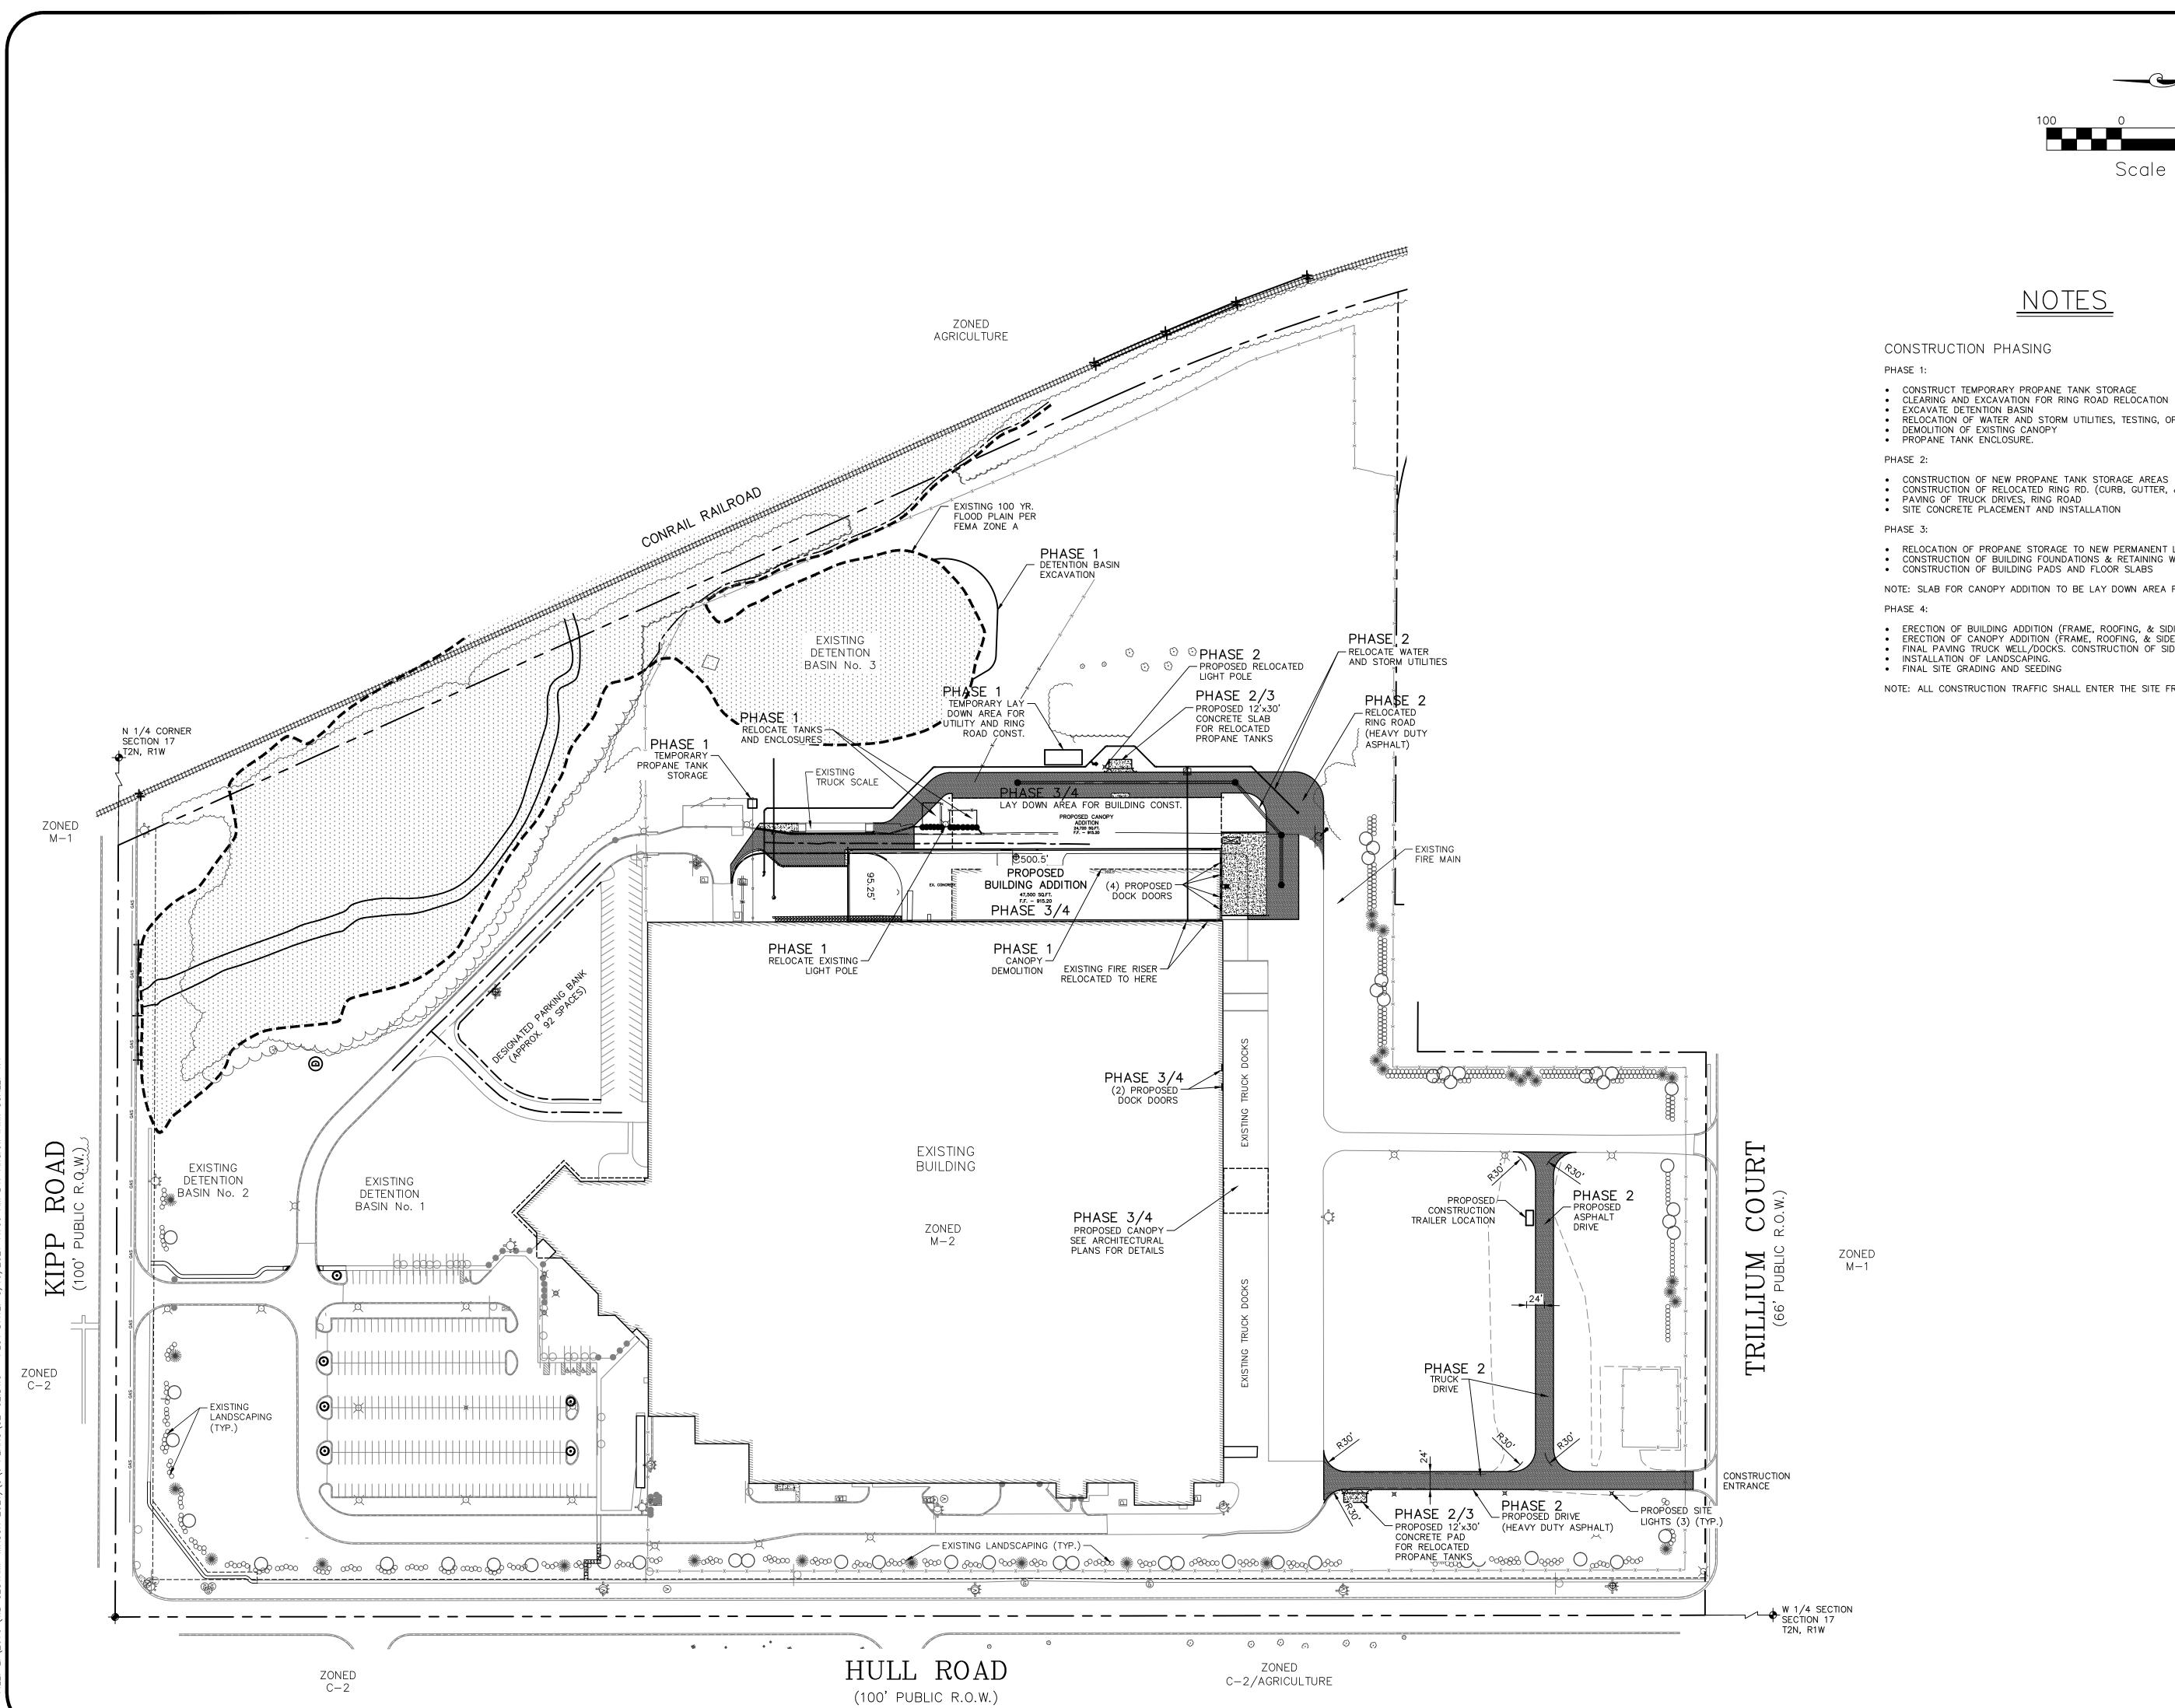

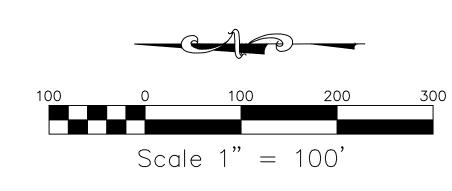

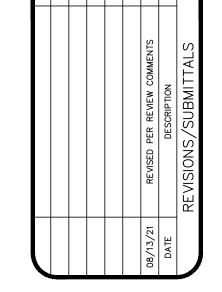

CONSTRUCTION PHASING

- CONSTRUCT TEMPORARY PROPANE TANK STORAGE
- CLEARING AND EXCAVATION FOR RING ROAD RELOCATION
 EXCAVATE DETENTION BASIN
- RELOCATION OF WATER AND STORM UTILITIES, TESTING, OPERATION DEMOLITION OF EXISTING CANOPY
- PROPANE TANK ENCLOSURE.
- CONSTRUCTION OF RELOCATED RING RD. (CURB, GUTTER, & PAVING). PAVING OF TRUCK DRIVES, RING ROAD
- SITE CONCRETE PLACEMENT AND INSTALLATION

PHASE 3:

- RELOCATION OF PROPANE STORAGE TO NEW PERMANENT LOCATION CONSTRUCTION OF BUILDING FOUNDATIONS & RETAINING WALLS
 CONSTRUCTION OF BUILDING PADS AND FLOOR SLABS
- NOTE: SLAB FOR CANOPY ADDITION TO BE LAY DOWN AREA FOR BUILDING STEEL.
- PHASE 4:
- ERECTION OF BUILDING ADDITION (FRAME, ROOFING, & SIDING) ERECTION OF CANOPY ADDITION (FRAME, ROOFING, & SIDE PÁNELS).
- FINAL PAVING TRUCK WELL/DOCKS. CONSTRUCTION OF SIDE WALLS. INSTALLATION OF LANDSCAPING.
- FINAL SITE GRADING AND SEEDING

NOTE: ALL CONSTRUCTION TRAFFIC SHALL ENTER THE SITE FROM TRILLIUM COURT.



3135 PINE TREE ROAD SUITE D LANSING, MI 48911 PH. (517) 393-2902 FAX (517) 393-2608 www.lsg-es.com



200 EAST KIPP ROAD MASON, MICHIGAN 48854 PHONE # (517) 244-8800




4162 ENGLISH OAK DRIVE LANSING, MICHIGAN 48911 PHONE # (517) 372–8650


PLAN



DESIGNED BY ADB DRAWN BY ____AJI CHECKED BY ADB DATE ____AUG. 12, 2021 HOR. 1"=100' VERT. N/A PROJECT NO. 2679

Call before you dig. SHEET NO. C2.02

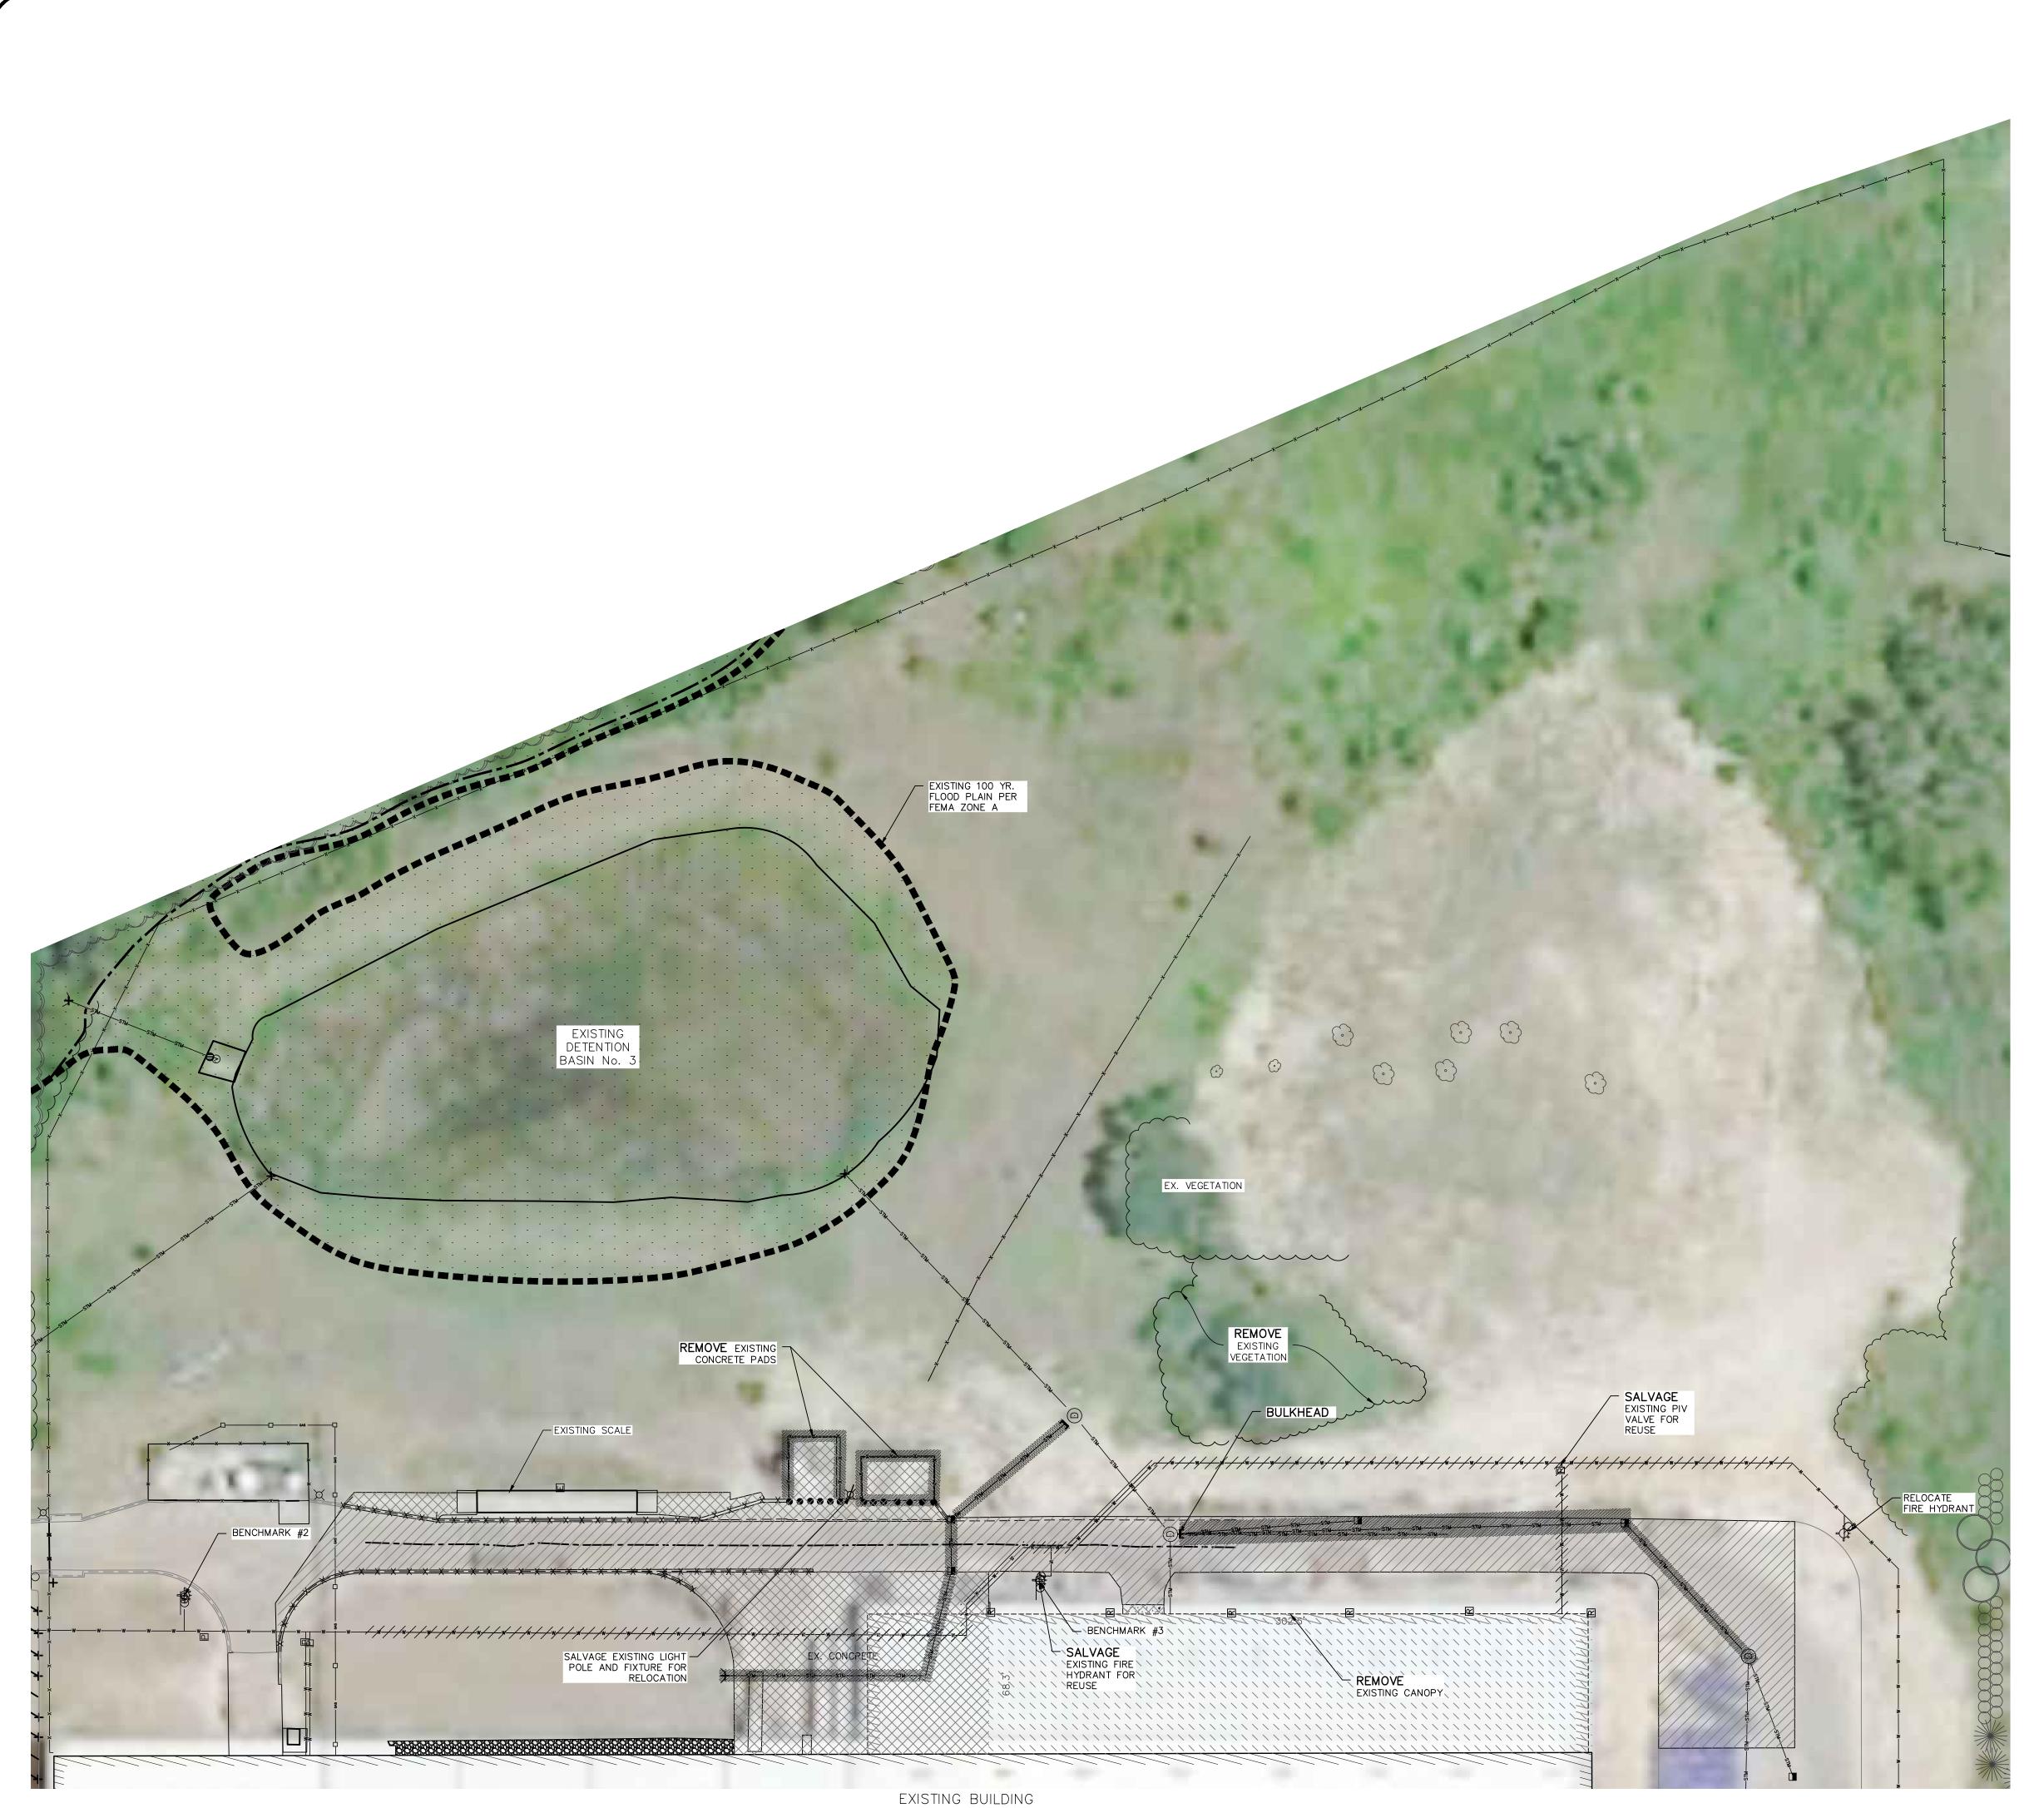

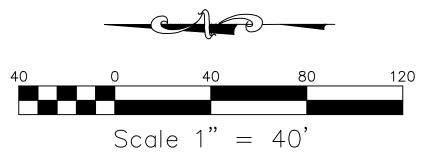

1. BENCHMARKS

- #1. NORTHWEST FLANGE BOLT ON FIRE HYDRANT, 204'± NORTH AND 93'± WEST OF THE NORTHEAST CORNER OF BUILDING. ELEVATION: 908.84 (NAVD 88)
- #2. NORTHWEST FLANGE BOLT ON FIRE HYDRANT, 81'± WEST AND 66'± SOUTH OF THE NORTHEAST CORNER OF BUILDING. ELEVATION: 915.75 (NAVD 88)
- #3. NORTHWEST FLANGE BOLT ON FIRE HYDRANT, 88'± WEST AND 494'± SOUTH OF THE NORTHEAST CORNER OF BUILDING. ELEVATION: 912.53 (NAVD 88)
- THE CONTRACTOR SHALL CALL "MISS DIG" AT 811 OR 1-800-482-7171
 AT LEAST THREE (3) WORKING DAYS (EXCLUDING WEEKENDS AND
 HOLIDAYS) PRIOR TO CONSTRUCTION.
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- 4. UNLESS OTHERWISE NOTED, ALL DIMENSIONS ARE TO THE FACE OF CURB AND ALL BUILDING AND PAVEMENT LINES ARE PARALLEL AND/OR PERPENDICULAR TO THE EAST WALL OF THE BUILDING.
- 5. SEE SHEET 2.02 FOR CONSTRUCTION PHASING.

TREES TO BE REMOVED

DEMOLITION LEGEND

CONCRETE REMOVAL ASPHALT REMOVAL BUILDING DEMOLITION (SEE ARCH. PLANS) EXISTING UTILITIES ----12"STM------12"STM-----TO BE REMOVED FENCING REMOVAL ----x----x-----x------x LIGHT POLE & BASE REMOVAL SIGN POLE & BASE REMOVAL EXISTING UTILITY (ABANDON) CURB & GUTTER REMOVAL

Engineers & Surveyors

3135 PINE TREE ROAD SUITE D LANSING, MI 48911 PH. (517) 393-2902 FAX (517) 393-2608 www.lsg-es.com

PREPARED FOR:

Gestamp (200 EAST KIPP ROAD MASON, MICHIGAN 48854 PHONE # (517) 244-8800

4162 ENGLISH OAK DRIVE LANSING, MICHIGAN 48911 PHONE # (517) 372–8650


XX

MISS

DRAWN BY ____AJI_ CHECKED BY ADB DATE ____MAY 24, 2021 HOR. ___1"=40' PROJECT NO. 2679

Know what's below. Call before you dig. SHEET NO. C2.1



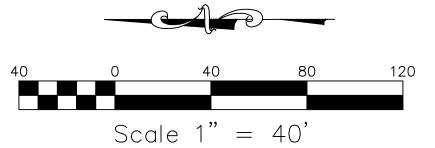

- BENCHMARKS
- #1. NORTHWEST FLANGE BOLT ON FIRE HYDRANT, 204'± NORTH AND 93'± WEST OF THE NORTHEAST CORNER OF BUILDING. ELEVATION: 908.84 (NAVD 88)
- #2. NORTHWEST FLANGE BOLT ON FIRE HYDRANT, 81'± WEST AND 66'± SOUTH OF THE NORTHEAST CORNER OF BUILDING. ELEVATION: 915.75 (NAVD 88)
- #3. NORTHWEST FLANGE BOLT ON FIRE HYDRANT, 88'± WEST AND 494'± SOUTH OF THE NORTHEAST CORNER OF BUILDING. ELEVATION: 912.53 (NAVD 88)
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Engineers & Surveyors

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PREPARED FOR:

Gestamp

200 EAST KIPP ROAD MASON, MICHIGAN 48854 PHONE # (517) 244-8800




4162 ENGLISH OAK DRIVE LANSING, MICHIGAN 48911 PHONE # (517) 372–8650


MISS Know what's below.


DESIGNED BY ADB DRAWN BY ____AJI_ CHECKED BY ADB DATE <u>MAY 24, 2021</u> SCALE HOR. 1"=40' VERT. N/A PROJECT NO. 2679 Call before you dig.


SHEET NO.

C3.0

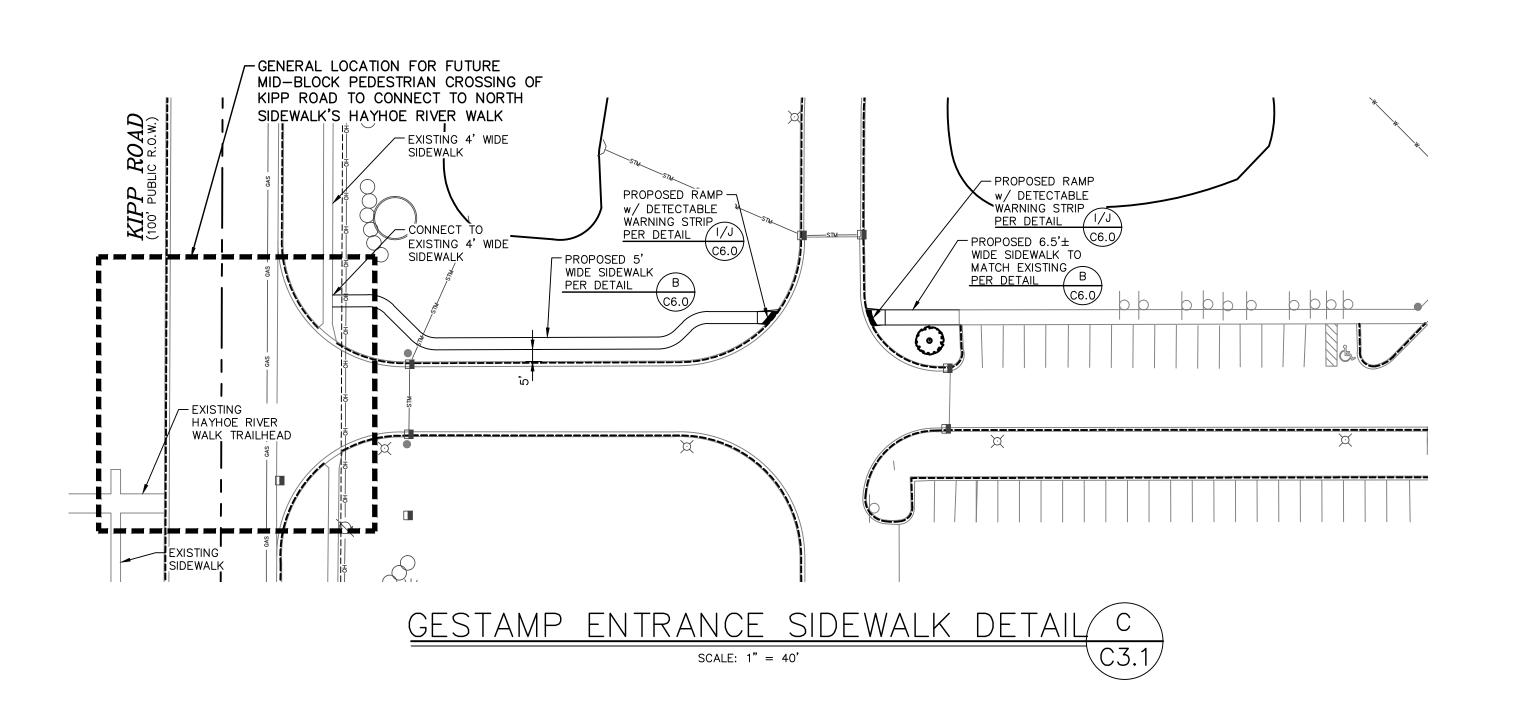


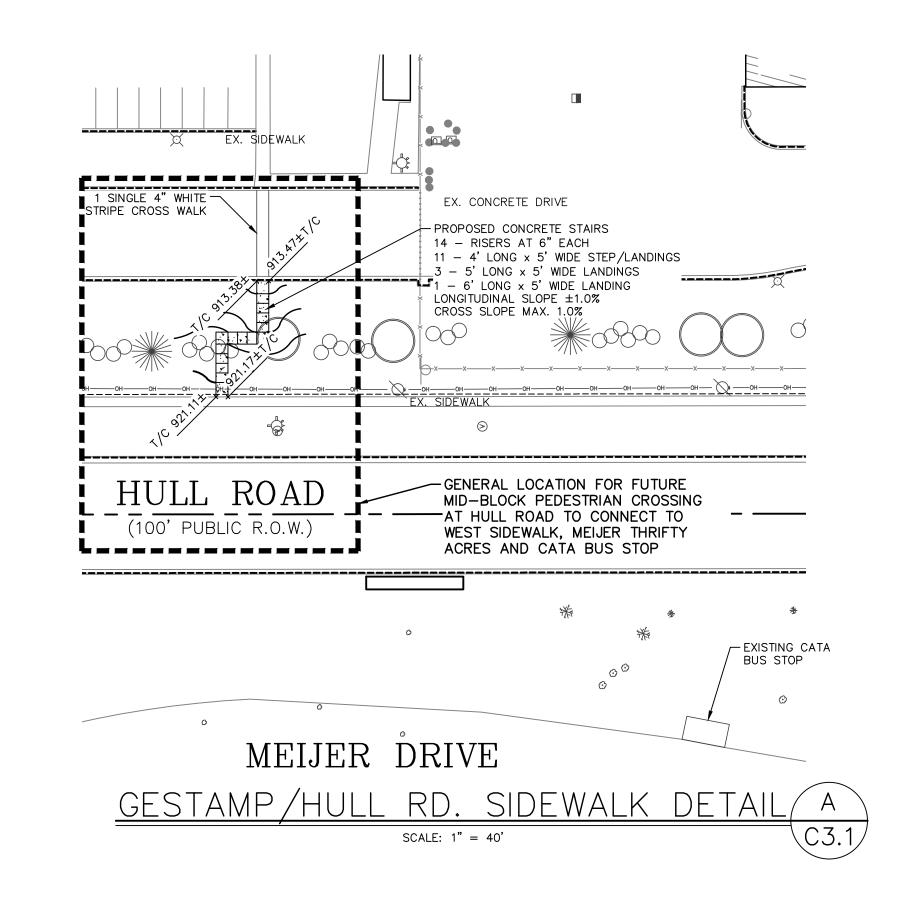

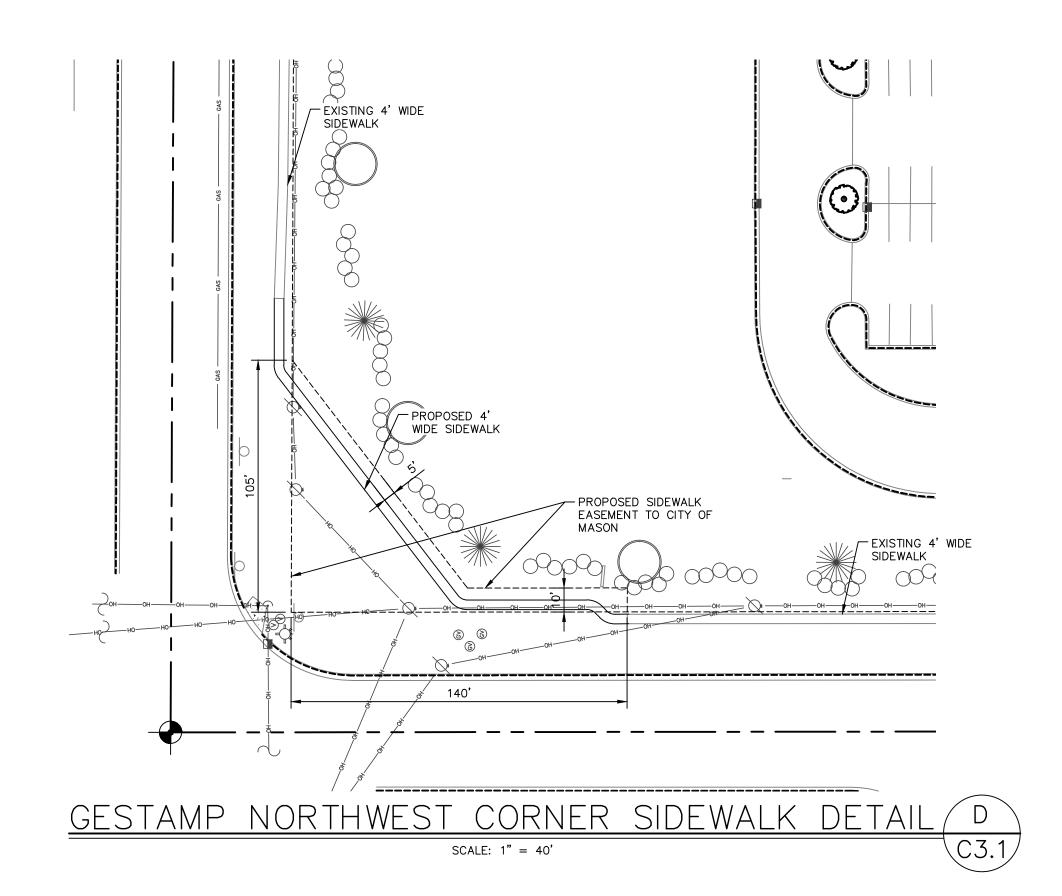

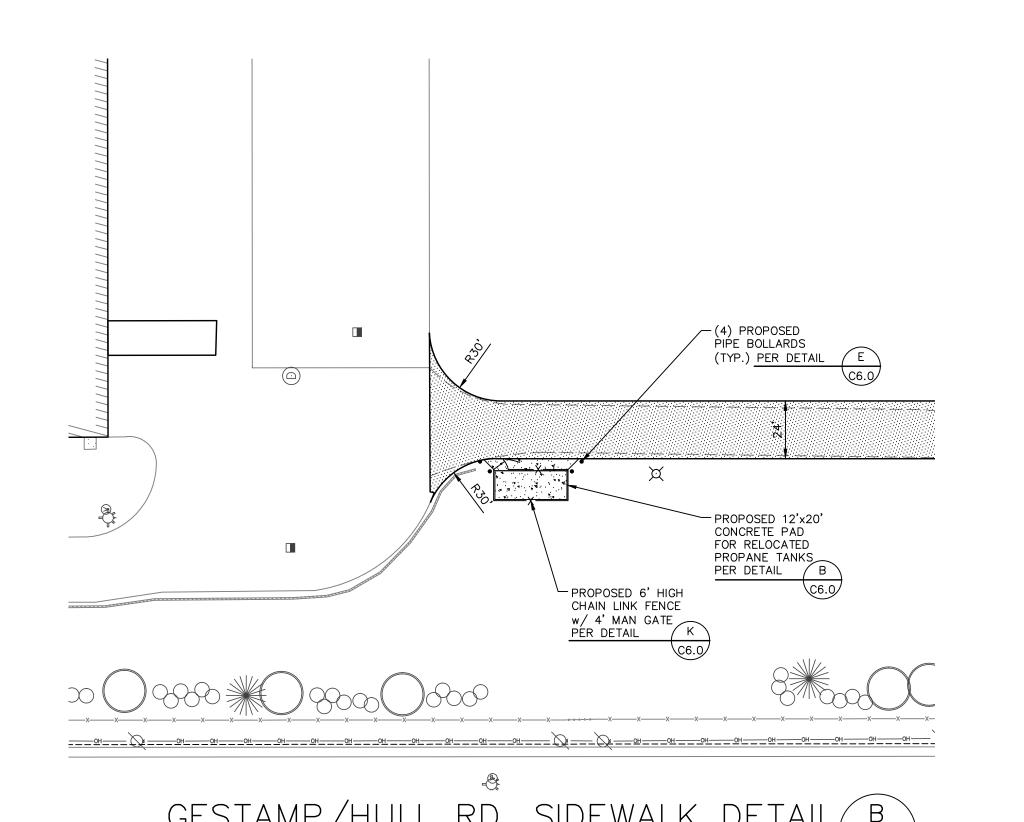

SCALE: 1" = 40'

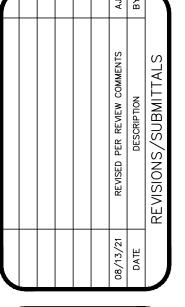



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Gestamp

200 EAST KIPP ROAD MASON, MICHIGAN 48854 PHONE # (517) 244-8800




WIELAND


4162 ENGLISH OAK DRIVE
LANSING, MICHIGAN 48911
PHONE # (517) 372-8650

DETAILED SIDEWALK PLANS
FOR
GESTAMP 2021 EXPANSION
200 EAST KIPP ROAD
MASON MI 48854




_	
	FILEC3-1.DWG DESIGNED BYADB DRAWN BYAJI CHECKED BYADB DATEAUG. 08, 2021
•	SCALE HOR1"=40'
7	VERT. N/A
elow.	PROJECT NO. 2679
ou dia	SHEET NO.

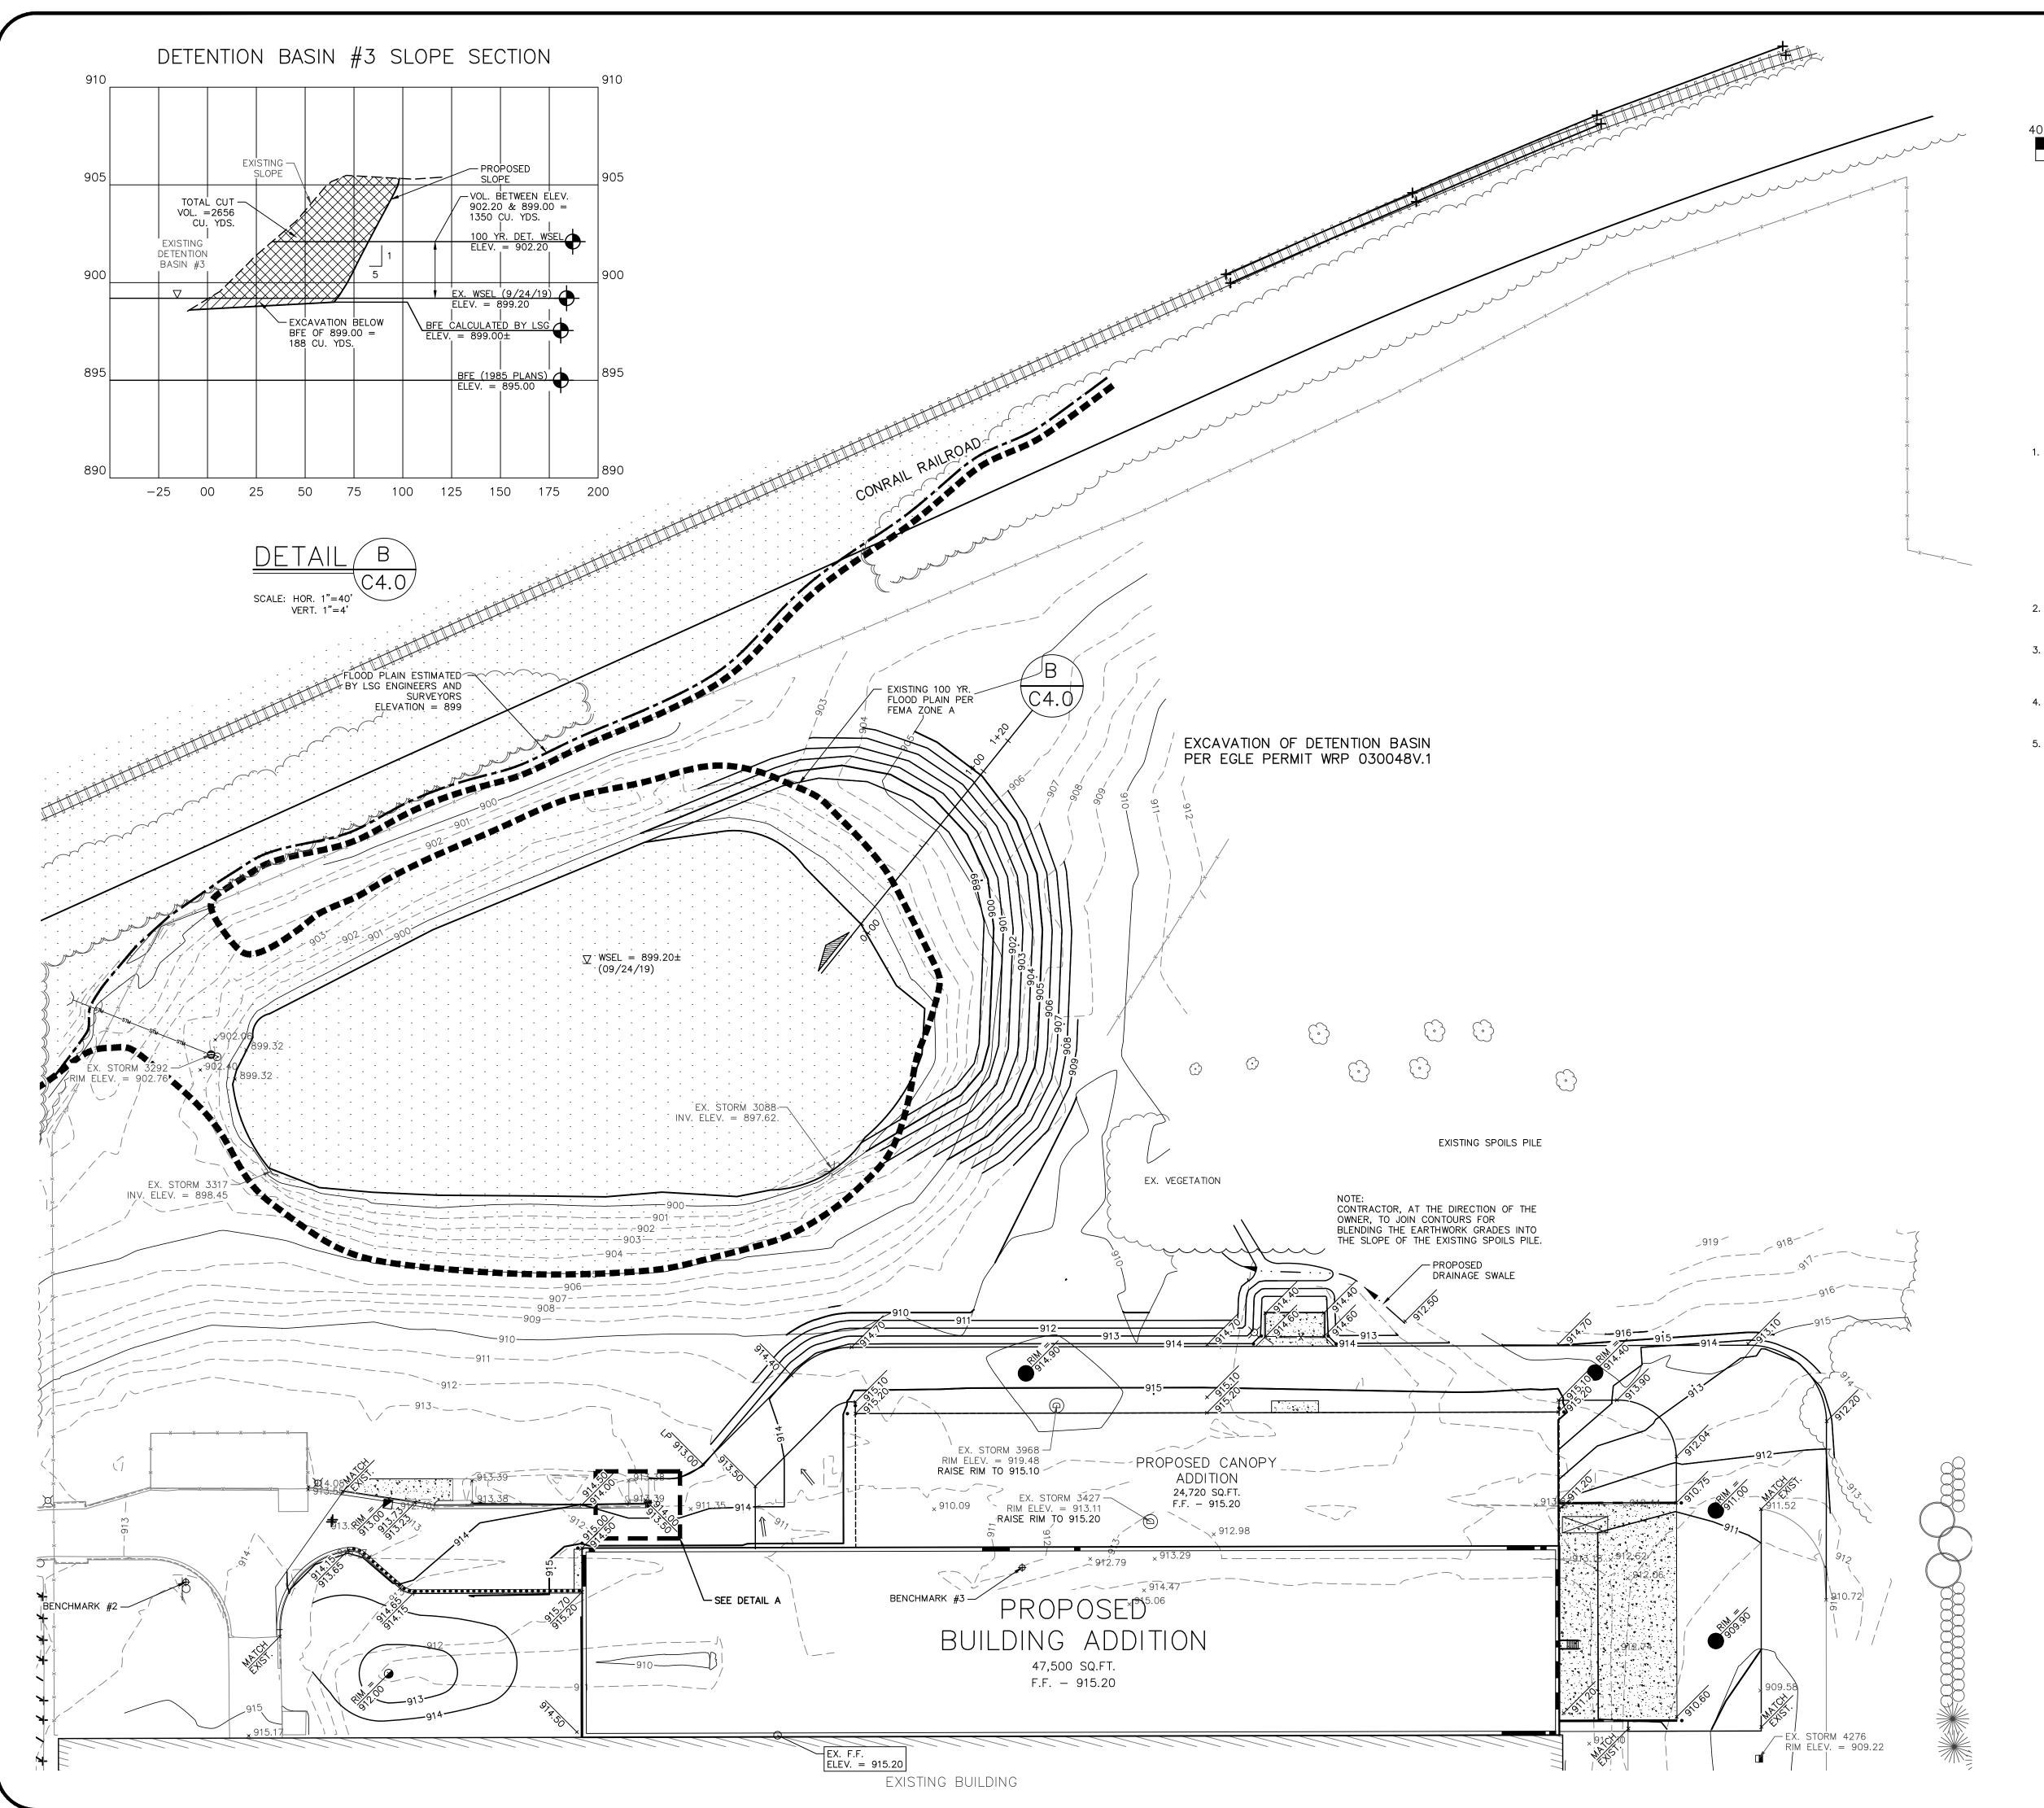


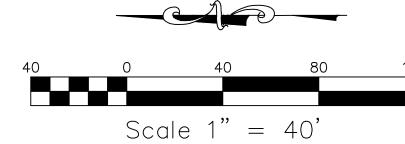

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Gestamp
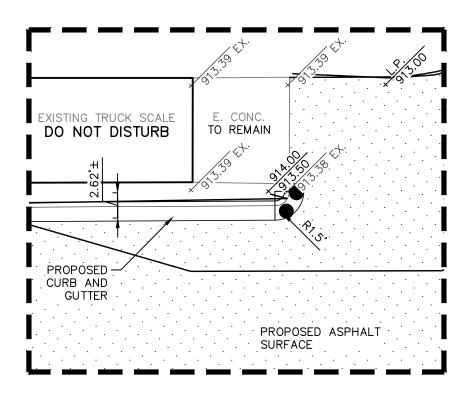
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WIELAND

4162 ENGLISH OAK DRIVE
LANSING, MICHIGAN 48911
PHONE # (517) 372-8650

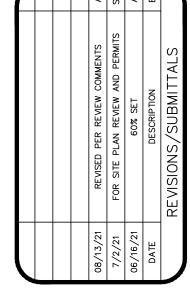GESTAMP 2021 EXPANSION
200 EAST KIPP ROAD
MASON, MI 48854



Call before you dig.

FILE _____C4-0.DWG

DESIGNED BY ___ADB

DRAWN BY ____AJI

CHECKED BY ___ADB

DATE ____MAY 24, 2021


SCALE


HOR. ___1"=40'

VERT. ___N/A


PROJECT NO.

2679

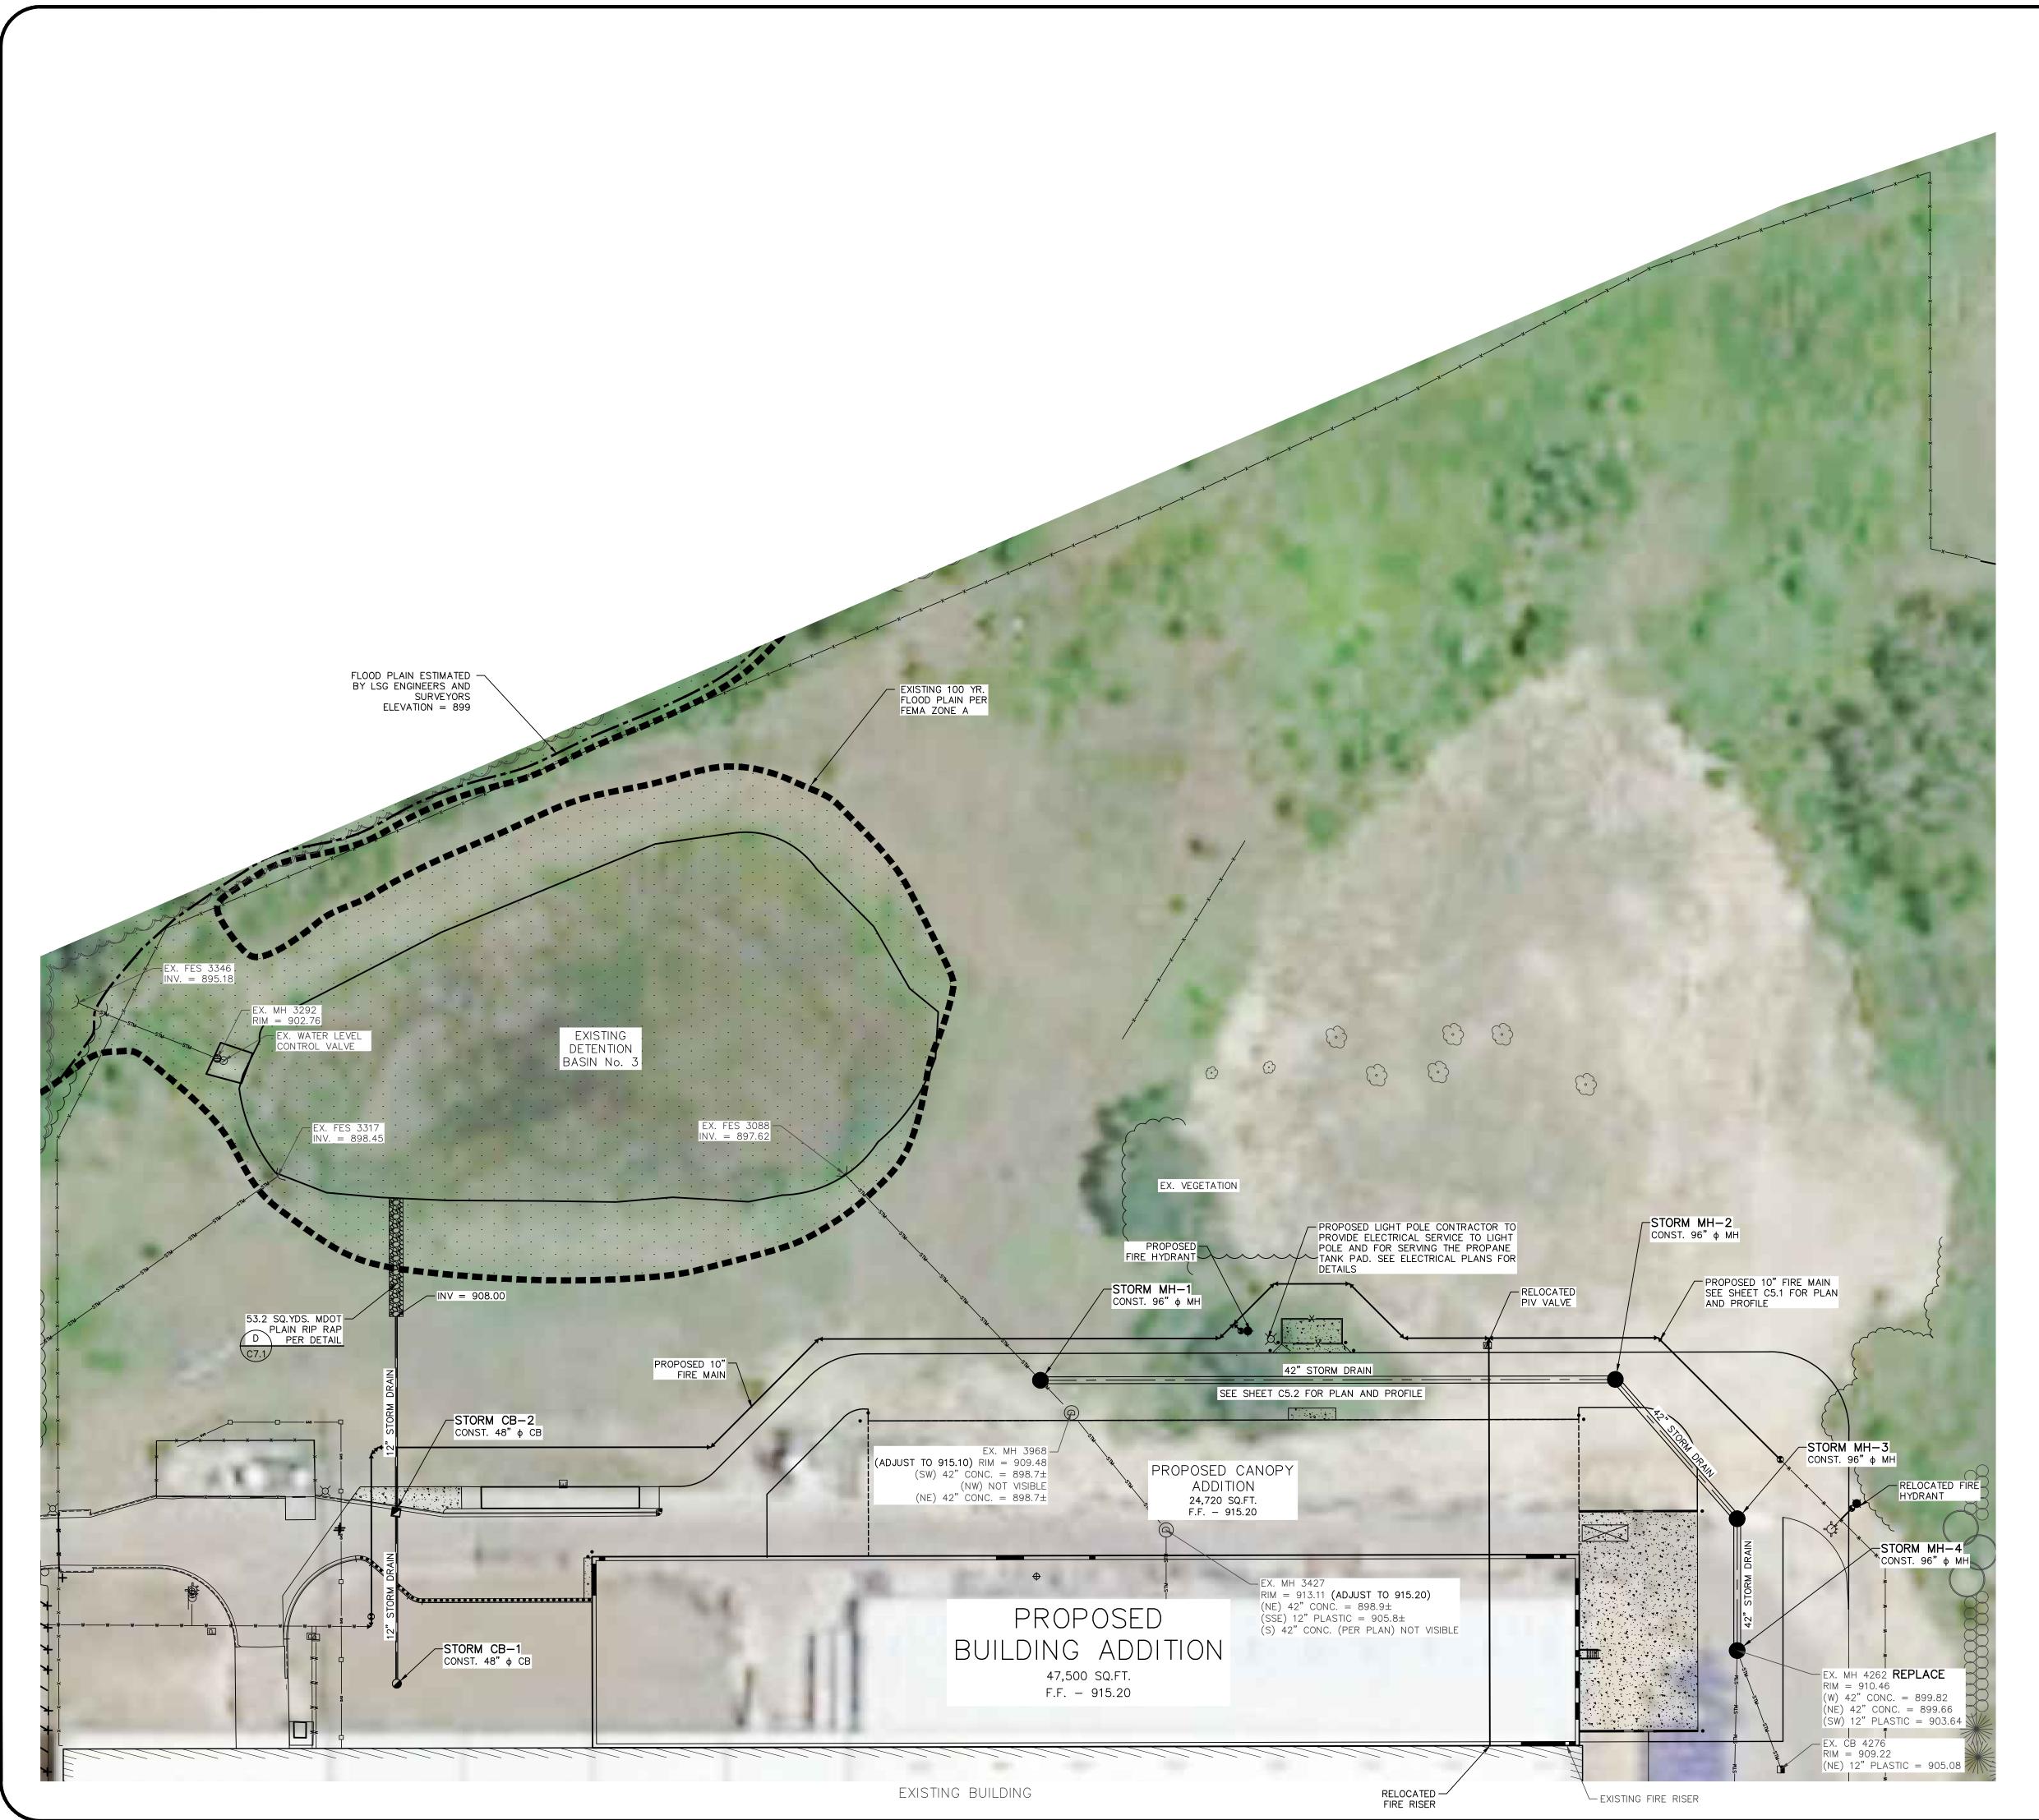

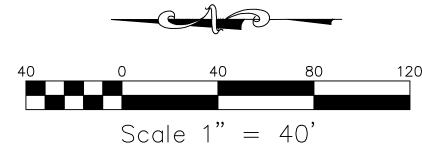


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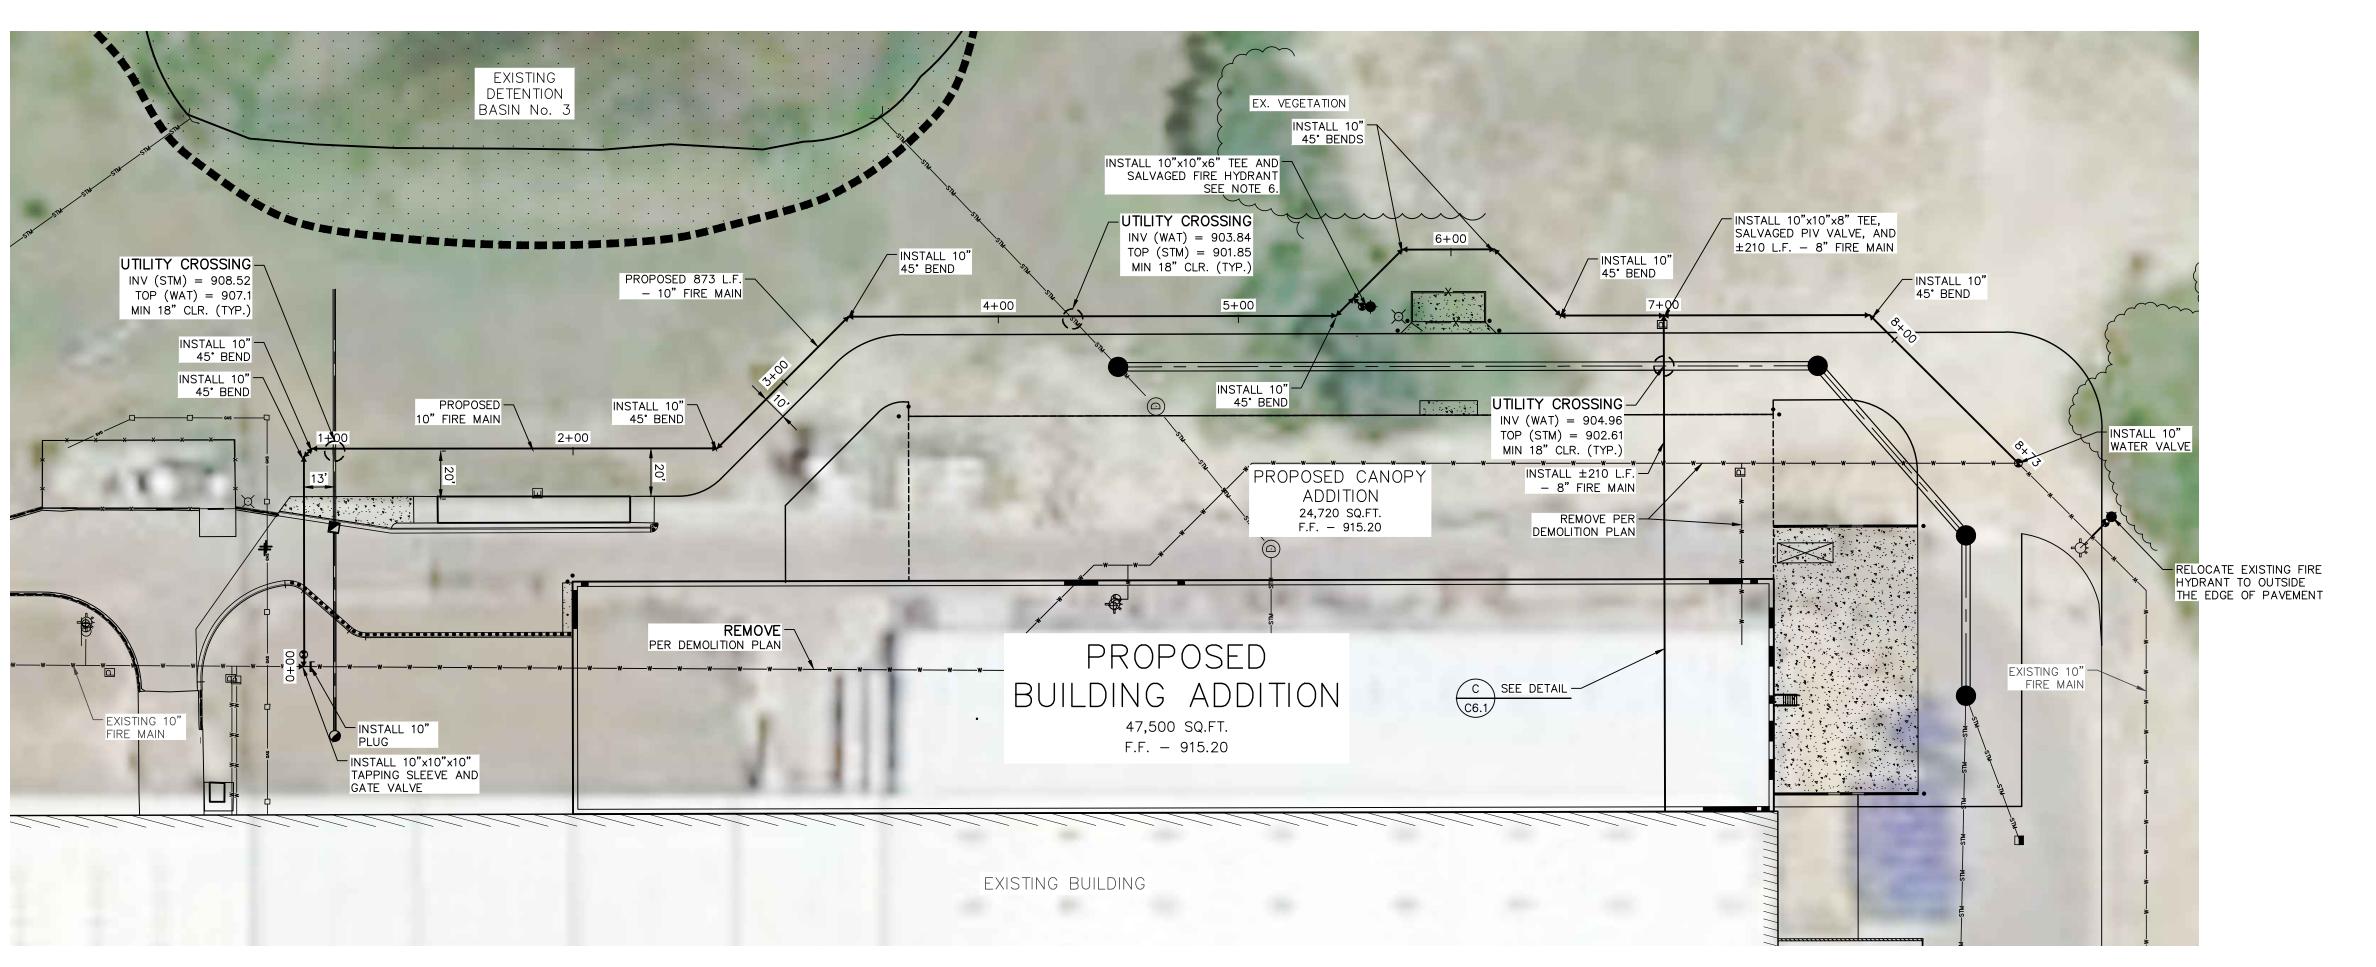


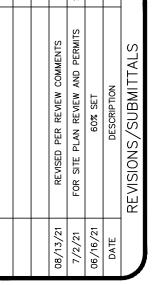
4162 ENGLISH OAK DRIVE LANSING, MICHIGAN 48911 PHONE # (517) 372–8650



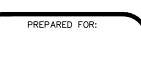


C5.0



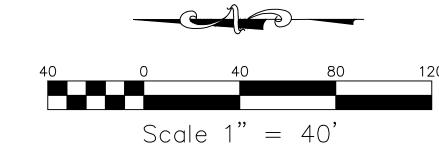

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- 6. NOTE: SALVAGED FIRE HYDRANT SHALL BE AN EJ MODEL 5BR WITH (2) 5-INCH STORZ CONNECTIONS & PAINTED YELLOW. IF NOT, THE HYDRANT SHALL BE REPLACED TO MEET THESE REQUIREMENTS PER THE CITY OF MASON STANDARDS.
- 7. NOTE: VALVES SHALL BE EJ FLOW MASTER RESILIANT SEAT GATE VALVES PER CITY OF MASON STANDARDS.

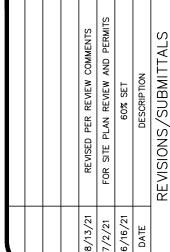



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PREPARED FOR:


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AND PROF FOR FOR GESTAMP 2021

AMASON, MI



_EXISTING 10"___ FIRE MAIN


9+00

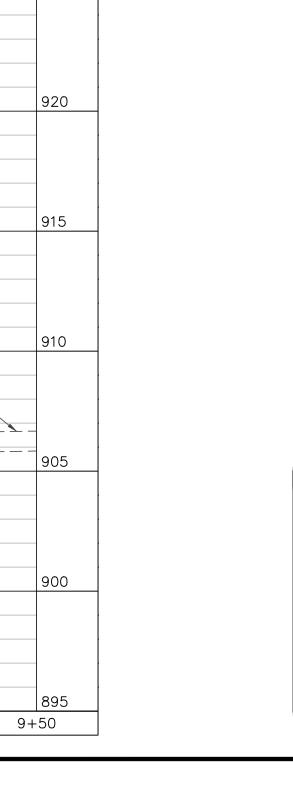
EXISTING GRADE

7+00

8+00



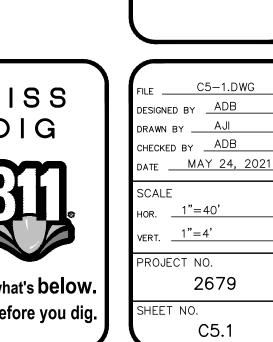

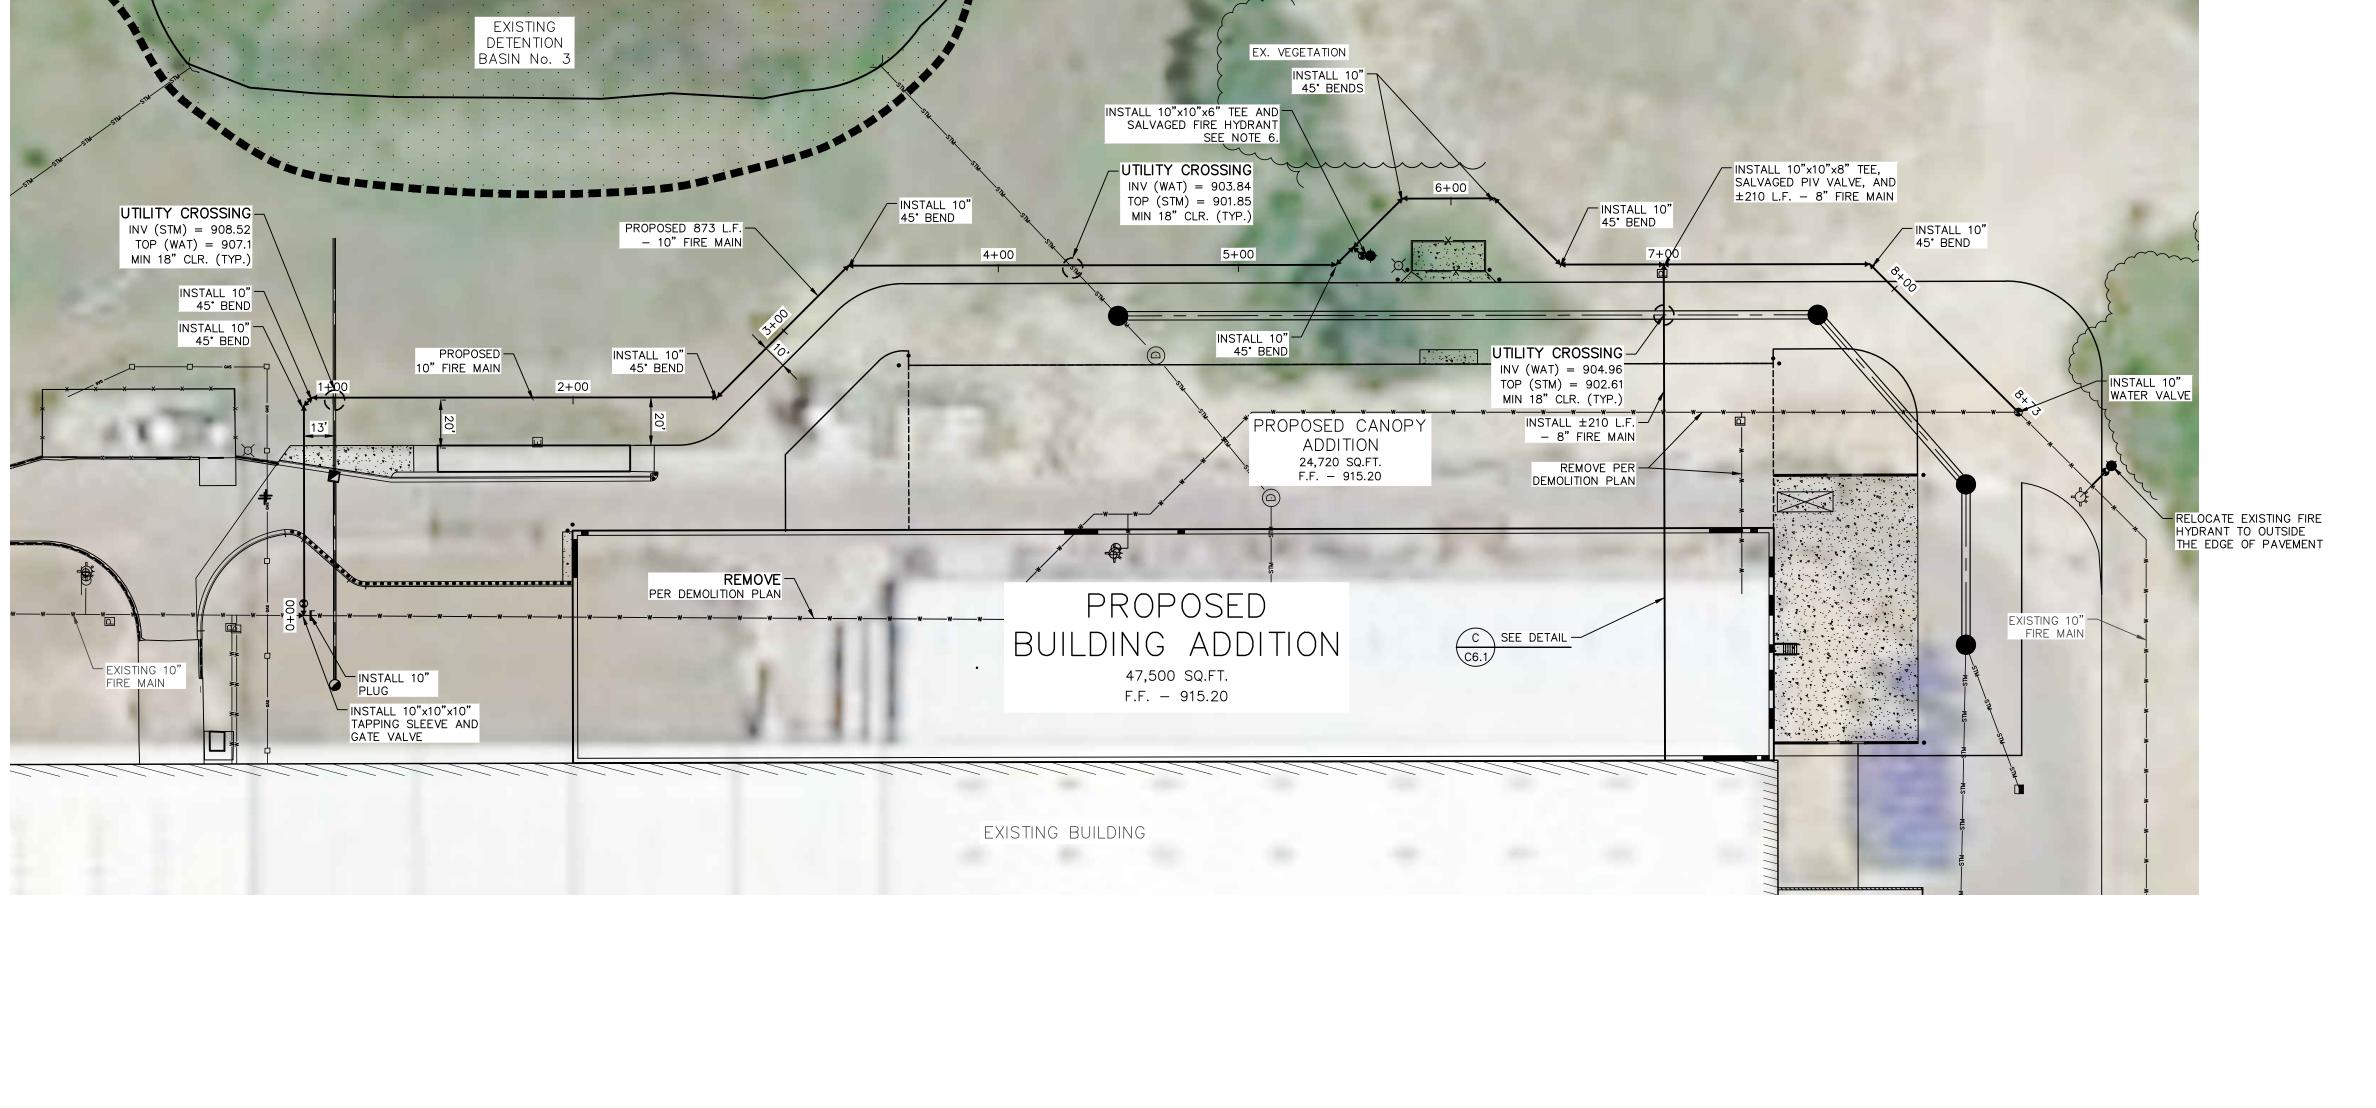

930

915

EXISTING 10"_ FIRE MAIN

-0+50

0+00

100% SAND — BACKFILL

EXISTING — GRADE

2+00


3+00


4+00

5+00

6+00

1+00

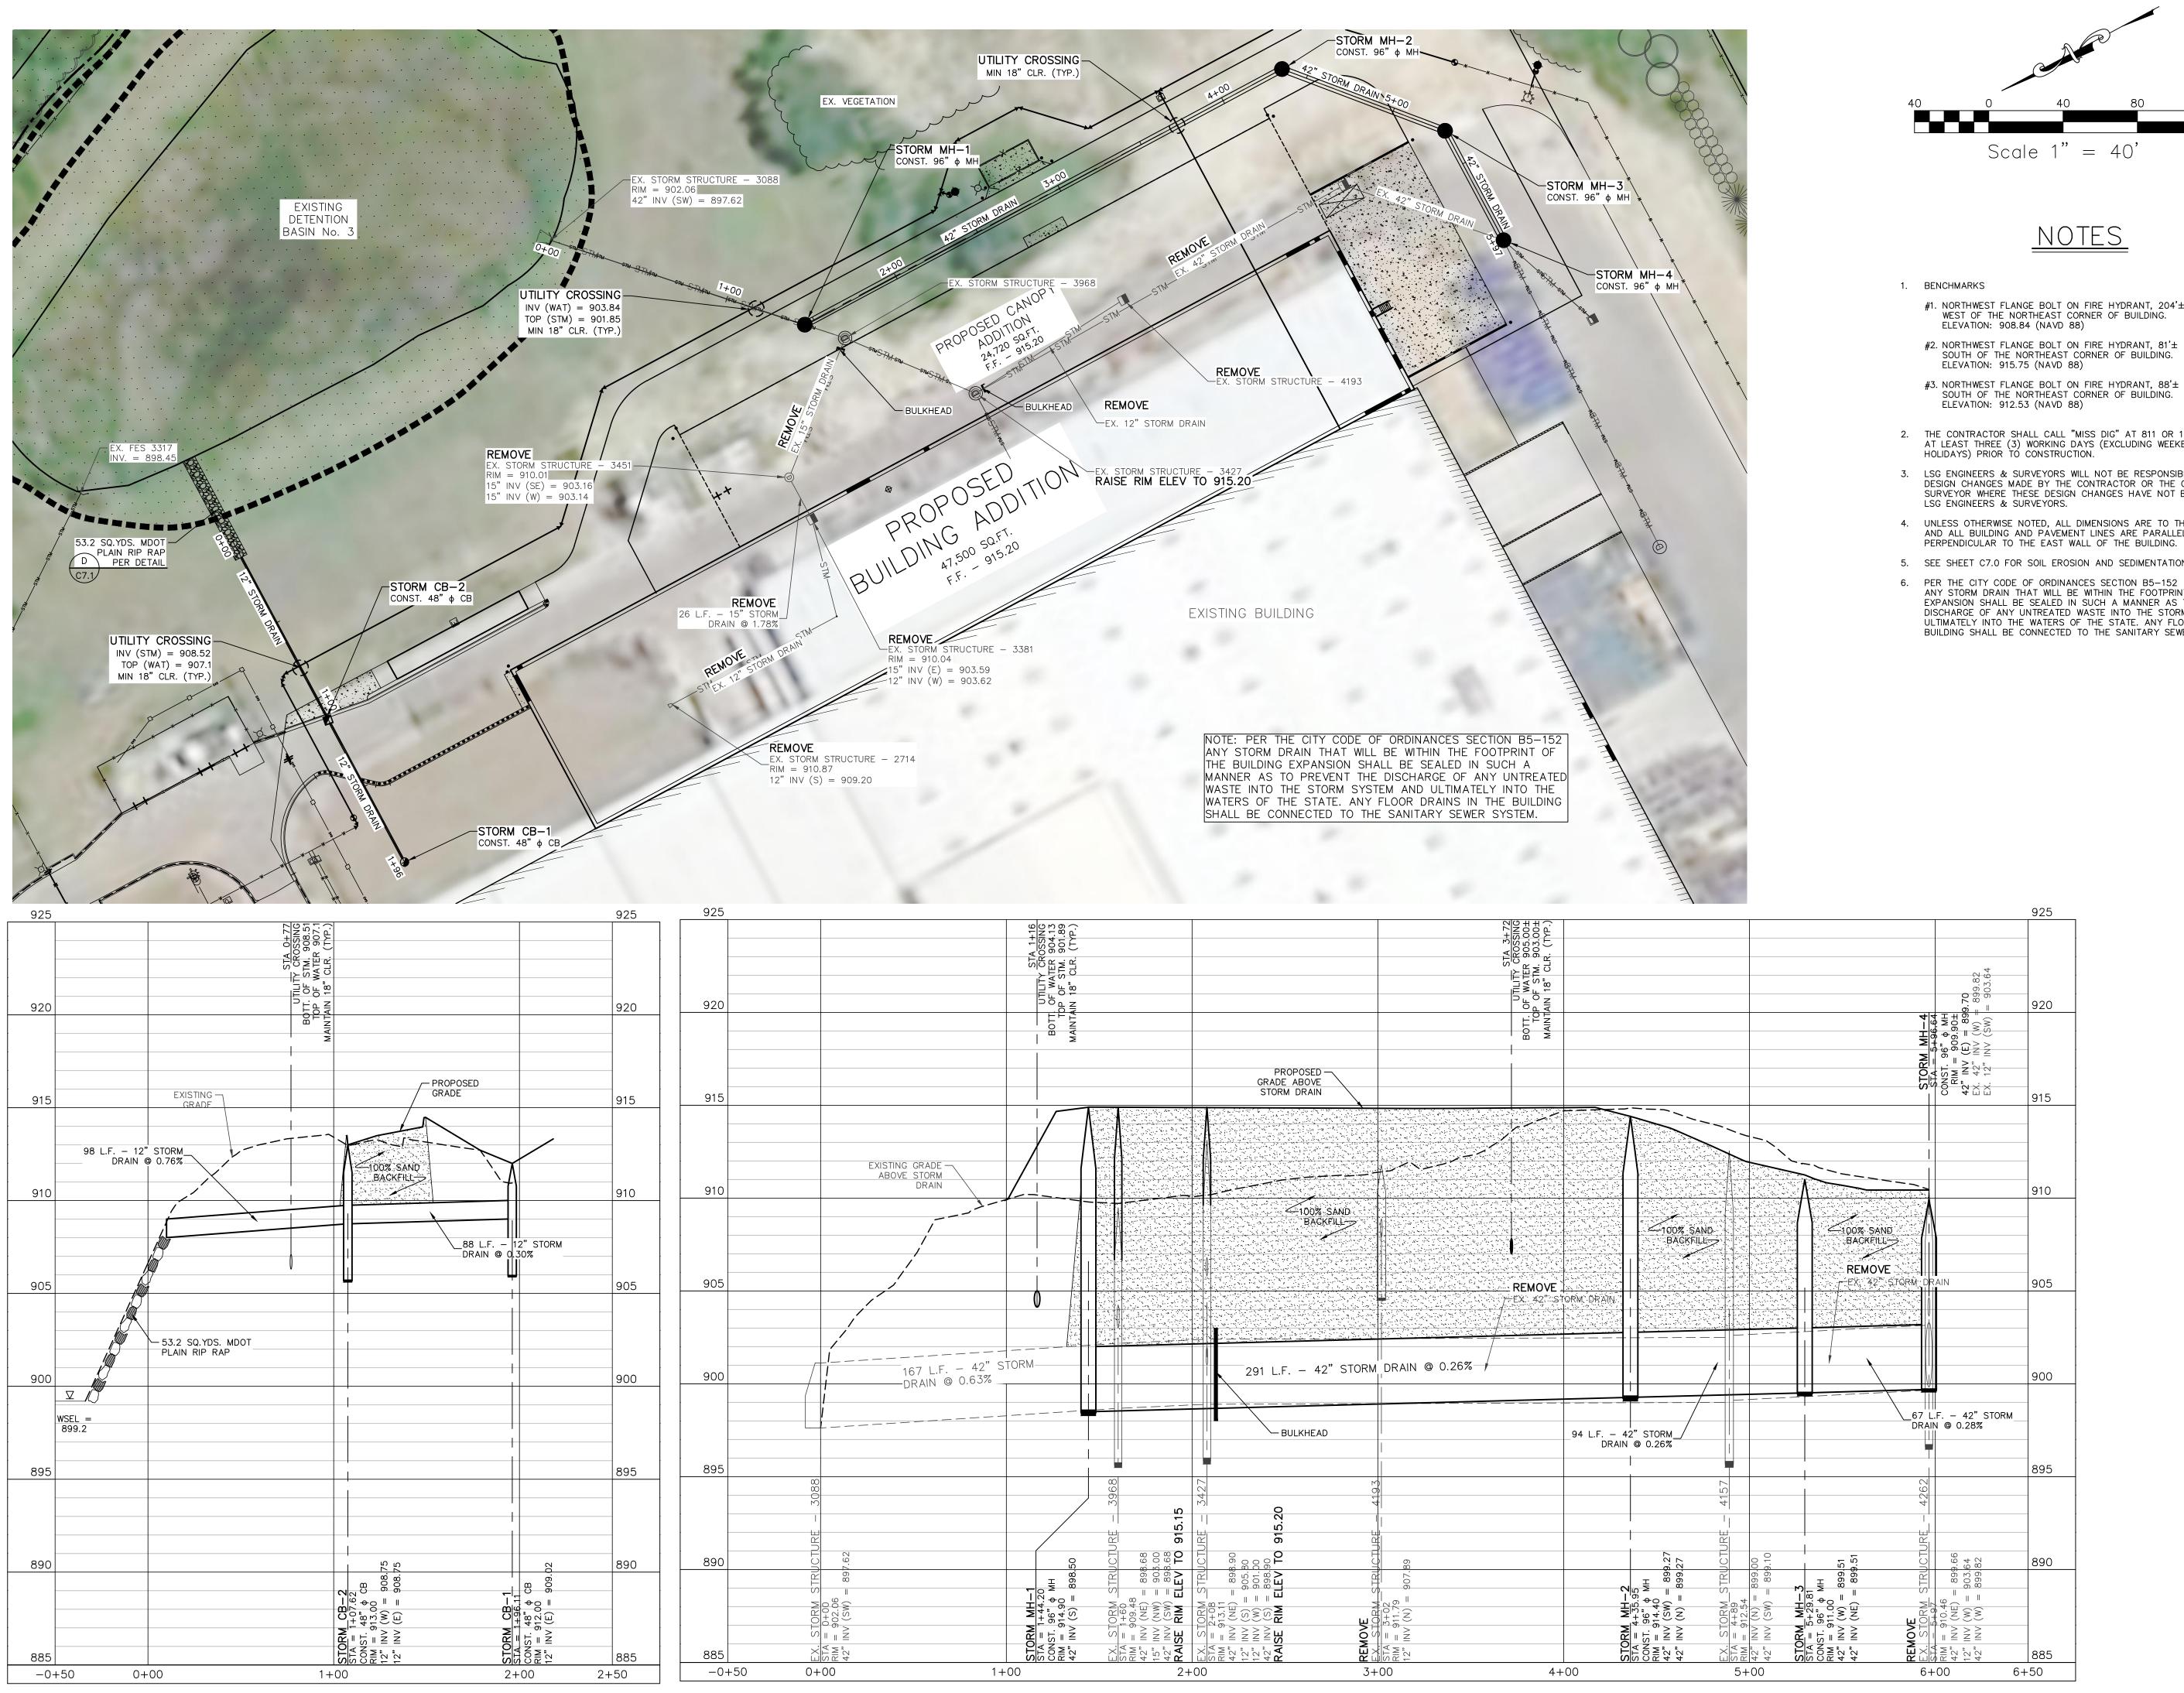

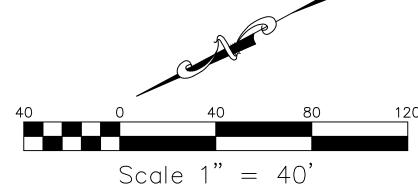

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- ANY STORM DRAIN THAT WILL BE WITHIN THE FOOTPRINT OF THE BUILDING EXPANSION SHALL BE SEALED IN SUCH A MANNER AS TO PREVENT THE DISCHARGE OF ANY UNTREATED WASTE INTO THE STORM SYSTEM AND ULTIMATELY INTO THE WATERS OF THE STATE. ANY FLOOR DRAINS IN THE BUILDING SHALL BE CONNECTED TO THE SANITARY SEWER SYSTEM.

	REVISED PER REVIEW COMMENTS	FOR SITE PLAN REVIEW AND PERMITS	13S %09	DESCRIPTION	REVISIONS/SUBMITTALS
	08/13/21	7/2/21	06/16/21	DATE	



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DRAINAGE




S /a	FILE C5-2.D DESIGNED BY ADB DRAWN BY AJI CHECKED BY ADB DATE MAY 24,
	SCALE HOR1"=40' VERT1"=4'
_	PROJECT NO.


., 2021


2679 C5.2

- 1. HEIGHT SHALL BE AS REQUIRED BY STANDARD 6'0" WIRE FABRIC.
- 2. FABRIC SHALL BE #9 GAUGE, CHAIN LINK OPEN HEARTH STEEL WIRE HOT-DIPPED GALVANIZED AFTER WEAVING WITH MINIMUM COATING OF 2.0 OUNCE OF ZINC PER SQUARE FOOT OR ALUMINUM COATING WITH 0.40 OUNCES PER SQUARE FOOT, WOVEN IN 2" DIAMOND MESH.
- 3. CORNER, TERMINAL, GATE AND PULL POSTS SHALL BE 3.5"x3.5" ROLL FORMED STEEL SECTION, WEIGHT 4.8 LBS. PER FOOT.
- 4. INTERMEDIATE POSTS SHALL BE 2.25"x1.70" ROLL FORMED STEEL "C" SECTION, WEIGHT 2.64 LBS. PER FOOT.
- 5. TOP, INTERMEDIATE AND BOTTOM RAILS SHALL BE 1.625"x1.25" ROLL FORMED STEEL "C" SECTION, WEIGHT 1.37 LBS. PER FOOT.
- 6. CONCRETE FOR SETTING POSTS SHALL BE PORTLAND CEMENT COMPLYING WITH ASTM C-150, AGGREGATES COMPLYING WITH ASTM C-33, AND CLEAN WATER. MIX MATERIALS TO OBTAIN CONCRETE WITH A MINIMUM 28-DAY COMPRESSIVE STRENGTH OF 2500 PSI.
- 7. STRETCHER BAR BANDS, TIE WIRES, HOG RINGS, COUPLINGS, NUTS, STRETCHER BARS, BOLTS AND MISCELLANEOUS FASTENING DEVICES SHALL BE MANUFACTURER'S STANDARD FOR HEAVY CONSTRUCTION FENCE.
- 8. SWING GATES SHALL CONSIST OF THE FOLLOWING COMPONENTS:
- A. 2" O.D. STEEL PIPE 2.72 LBS. PER FOOT, HOT-DIPPED GALVANIZED. EACH FRAME TO BE EQUIPPED WITH 3/8" DIAMETER ADJUSTABLE TRUSS RODS.
- B. HINGES SHALL BE HOT-DIPPED GALVANIZED PRESSED STEEL ON MALLEABLE IRON TO SUIT GATE SIZE, NON-LIFT-OFF TYPE. HINGES SHALL BE OFFSET TO PERMIT 180 DEGREE OPENING. PROVIDE ONE (1) PAIR OF HINGES PER LEAF.
- C. LATCH SHALL BE FORKED TYPE TO PERMIT OPERATION FROM EITHER SIDE WITH PROVISIONS TO LOCK BOTH LEAVES WITH PADLOCK.

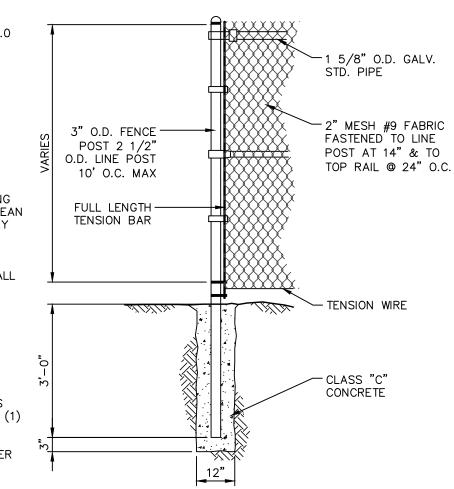



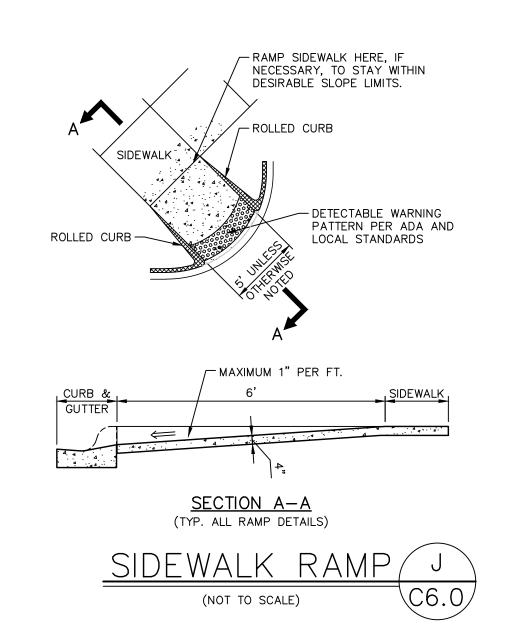

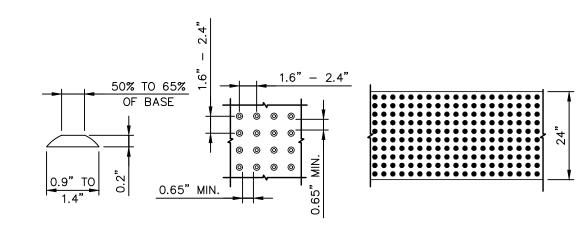

DOME SECTION


DOME SPACING


NOTE:

DETECTABLE WARNINGS SHALL EXTEND THE FULL WIDTH OF THE CURB RAMP. THEY SHALL BE LOCATED SO THAT THE EDGE NEAREST THE CURB LINE IS 6" TO 8" FROM THE CURB LINE.

DOME ALIGNMENT

DETECTABLE WARNING DETAIL,

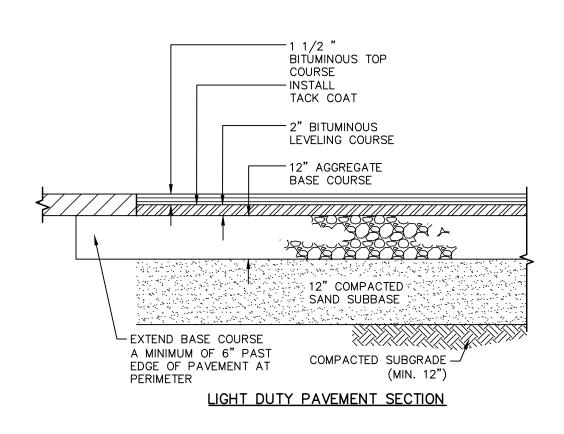


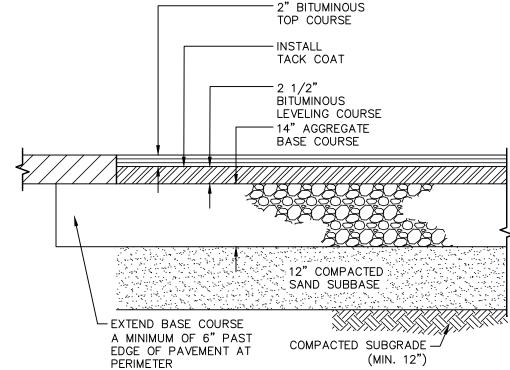

HEAVY DUTY PAVEMENT SECTION

BIT. TOP COURSE NO. 36A TOP BIT. LEVELING COURSE NO. 13A LEVELING AGG. BASE COURSE 21AA ALL MATERIAL DESIGNATIONS REFER TO M.D.O.T. STANDARD SPECIFICATIONS FOR

CONSTRUCTION, CURRENT EDITION SITE PAVEMENT SECTIONS (A \C6.0/

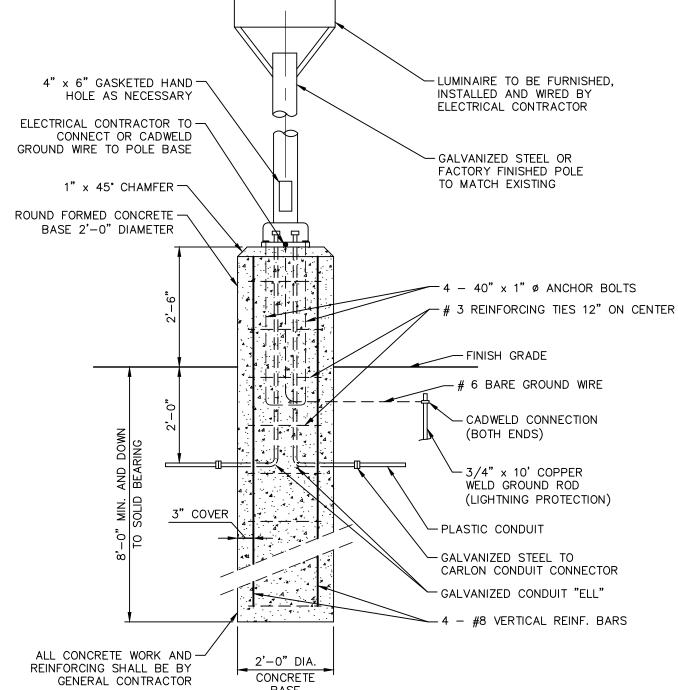


NOTES: 1. LIGHTING POLE TO MATCH EXISTING.

PARKING LOT LIGHTING


W/ CONCRETE BASE (H)

SLAB FOR PROPANE STORAGE TANK AREA SHALL BE 6" THICK.

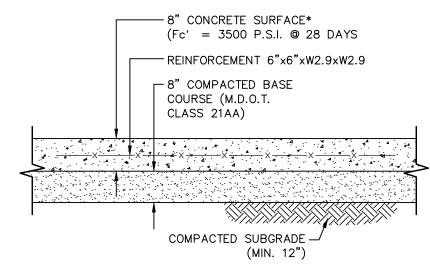


<u>SECTION</u>



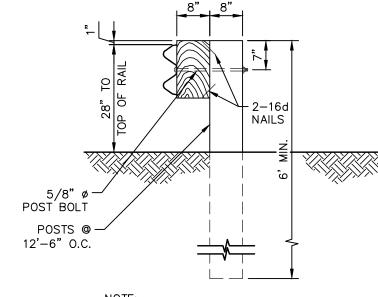

NOTE: SAWED TREATED TIMBER POSTS 6"x8"x6' AND SAWED TREATED TIMBER OFFSET BLOCKS 6"x8"x14" SHALL BE USED.

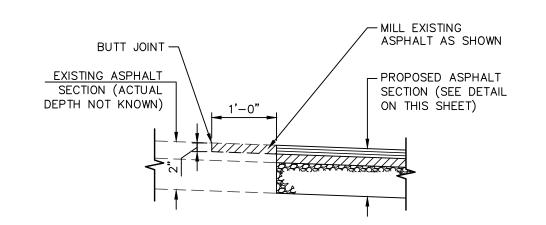



CONTRACTION AND EXPANSION JOINT NOTES:

- 1. PLACE 1" FIBER JOINT FILLER AT 40' MAXIMUM INTERVALS.
- 2. PLACE 1" FIBER JOINT FILLER AT SPRING POINTS OF CURB RETURNS. (AND INTERSECTING STREETS)

FINISH GRADE 1" BELOW TOP -OF CURB IN ALL LAWN AREAS TOP OF SOD TO BE FLUSH WITH

TOP OF CURB AS SHOWN.

REBÄR

CONT.

6" LAYER —

TOPSOIL

- PLACE 1" FIBER JOINT FILLER IN ADJACENT CONTRACTION JOINTS EACH SIDE OF CATCH BASINS.
- 4. PLACE CONTRACTION JOINTS AT 40' MAXIMUM INTERVALS. (NO SAW CUT JOINTS ALLOWED)

-UNDERCUTS TO BE

BACKFILLED WITH

CRUSHED STONE

MODIFIED CURB -

& GUTTER


(SEE NOTE)

MODIFIED CURB AND GUTTER SHALL BE THE SAME DETAIL BUT


THE GUTTER SHALL SLOPE AWAY FROM THE CURB FACE @ 1"/FT.


STANDARD


CURB & GUTTER DETAIL

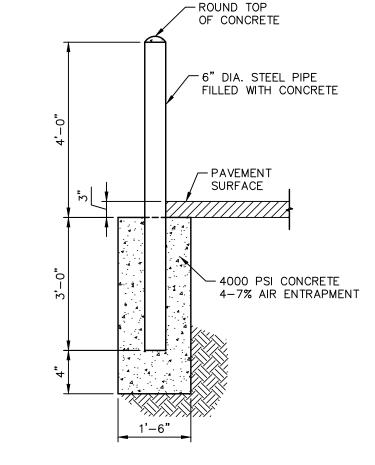

PIPE BOLLARD DETAIL

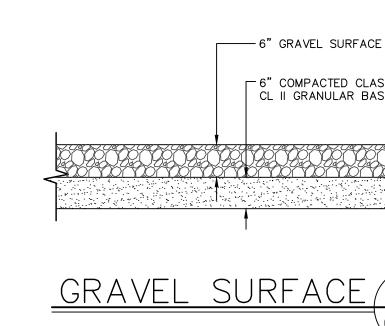

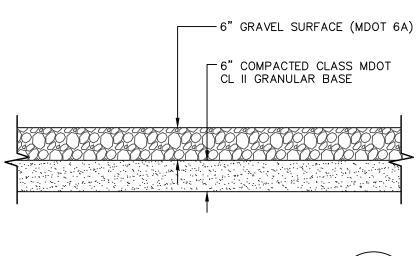

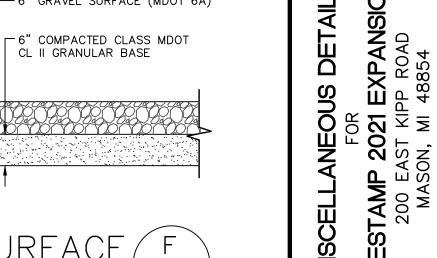



Call before you dig.

SCALE Know what's **below**.

DESIGNED BY ADB DRAWN BY ____AJI_ CHECKED BY ADB DATE MAY 24, 2021 HOR. <u>N/A</u>

VERT. N/A PROJECT NO. 2679 SHEET NO.

C6.0

Engineers

& Surveyors

3135 PINE TREE ROAD

SUITE D

LANSING, MI 48911

PH. (517) 393-2902 FAX (517) 393-2608 www.lsg-es.com


PREPARED FOR:

Gestamp

200 EAST KIPP ROAD MASON, MICHIGAN 48854

PHONE # (517) 244-8800

4162 ENGLISH OAK DRIVE LANSING, MICHIGAN 48911 PHONE # (517) 372–8650

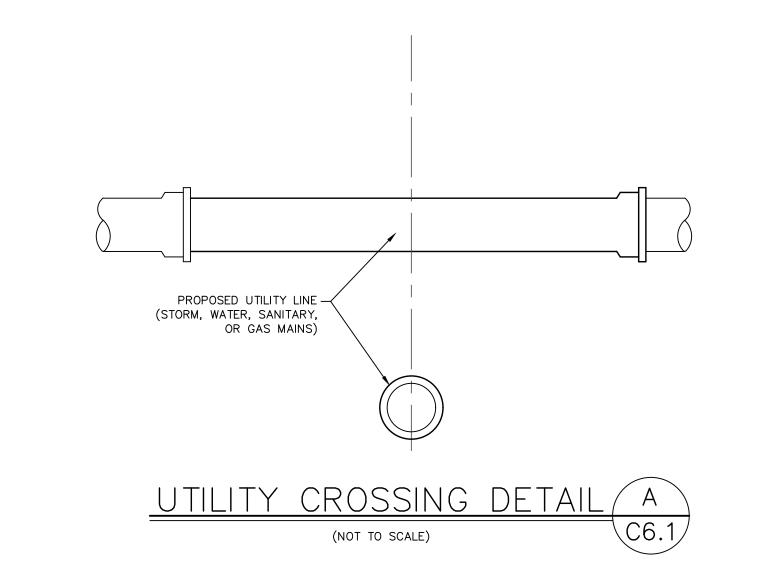

_COORDINATE W/ FIRE PROTECTION CONTRACTOR

-BLIND FLANGE -FINAL CONNECTION BY FIRE PROTECTION CONTRACTOR

PLAIN & FLANGED END DUCTILE IRON PIPE

─3/4" BITUMINOUS COATED TIE RODS

- MECHANICAL OR PUSH-ON JOINTS

THRUST BLOCK

WALL CONSTRUCTION—

FOUNDATION


SEE STRUCT. DWG. —


FINISH GRADE

AUTOMATIC SPRINKLER RISER CONNECTION (

8" LEAD INTO BUILDING

∕10" FP MAIN

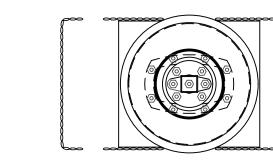

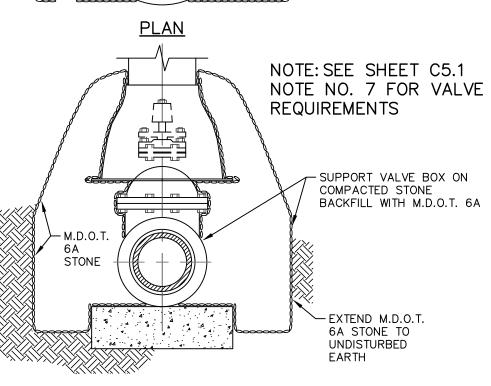

<u>SECTION</u>

DETAIL OF SETTING OF VALVE BOXES/ C6.1(NOT TO SCALE)

PIPE TEE, 90° 45° 22 1/2° 11 1/4° DEAD BENDS BENDS ENDS ENDS (ONE SIZE (TWO SIZE REDUCTION)* REDUCTION)* --52 49 12 30 12 6 3 75 40 81 16 8 96 19 9 94 5 139 54 22 11 42 92 27 | 13 | 117 169 75 31 15 7 197 59 132

IF REQUIRED PIPE DIAMETER IS NOT LISTED IN THIS TABLE, THE NEXT LARGEST PIPE DIAMETER SHALL BE USED.

THIS TABLE IS BASED ON A TEST PRESSURE OF 180 PSI (OPERATING PRESSURE PLUS WATER HAMMER). FOR OTHER TEST PRESSURES, ALL VALUES TO BE INCREASED OR DECREASED PROPORTIONALLY.

THE VALUES PROVIDED OF RESTRAINT LENGTH ARE IN EACH DIRECTION FROM THE POINT OF DEFLECTION OR TERMINATION EXCEPT FOR TEES, AT WHICH ONLY THE BRANCH IN THE DIRECTION OF THE STEM.

IF TIE RODS ARE USED, USE FOUR MINIMUM AND ADD 1/8 INCH TO BAR DIAMETER AS CORROSION ALLOWANCE.

* SIZE REDUCTION IS BASED UPON PIPE DIAMETER SHOWN IN THIS TABLE:


INTERNAL PRESSURE: PIPE DEPTH: BEDDING CLASS: SOIL TYPE: SAFETY FACTOR:

BASED UPON:

TYPE 4 GOOD SAND 2

PIPE RESTRAINT SCHEDULE (



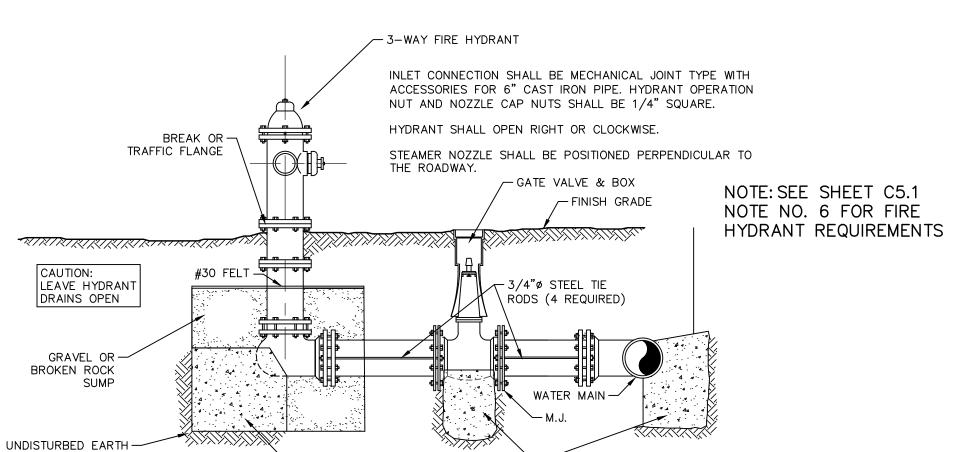

TYPICAL FIRE HYDRANT ASSEMBLY DETAIL (

 \searrow 2500 P.S.I. CONC. THRUST BLOCKING \searrow



DRAWN BY ____AJI__ SCALE HOR. N/A VERT. N/A PROJECT NO. 2679

Engineers & Surveyors

3135 PINE TREE ROAD SUITE D LANSING, MI 48911 PH. (517) 393-2902 FAX (517) 393-2608 www.lsg-es.com

PREPARED FOR: Gestamp (200 EAST KIPP ROAD MASON, MICHIGAN 48854 PHONE # (517) 244-8800




4162 ENGLISH OAK DRIVE LANSING, MICHIGAN 48911 PHONE # (517) 372–8650

FOR FOR GESTAMP 2021 EXPANSION 200 EAST KIPP ROAD MASON, MI 48854


DESIGNED BY ADB снескед ву <u>ADB</u> DATE MAY 24, 2021

Call before you dig. SHEET NO. C6.1

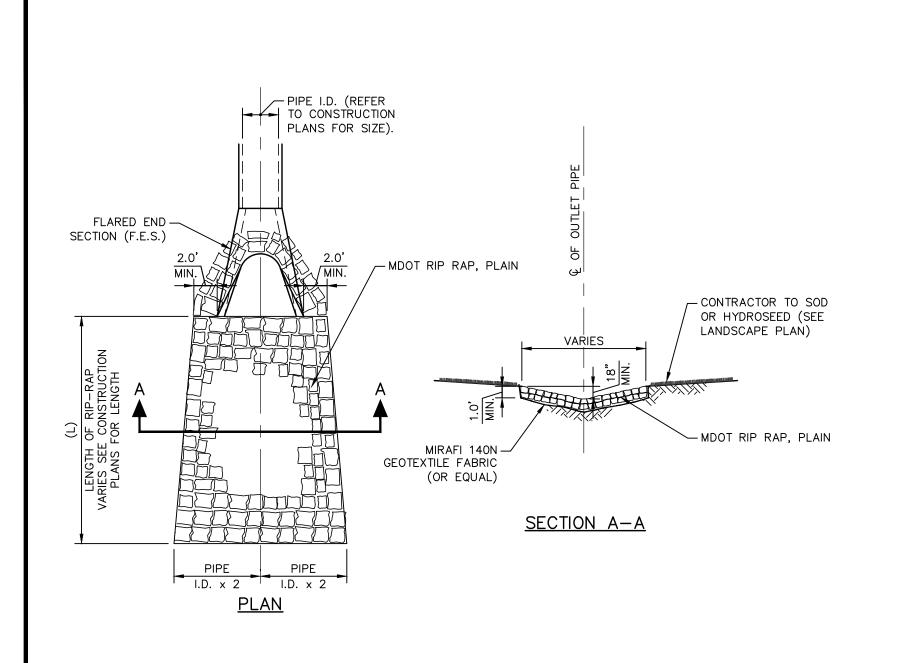


RIP-RAP DETAIL

(NOT TO SCALE)

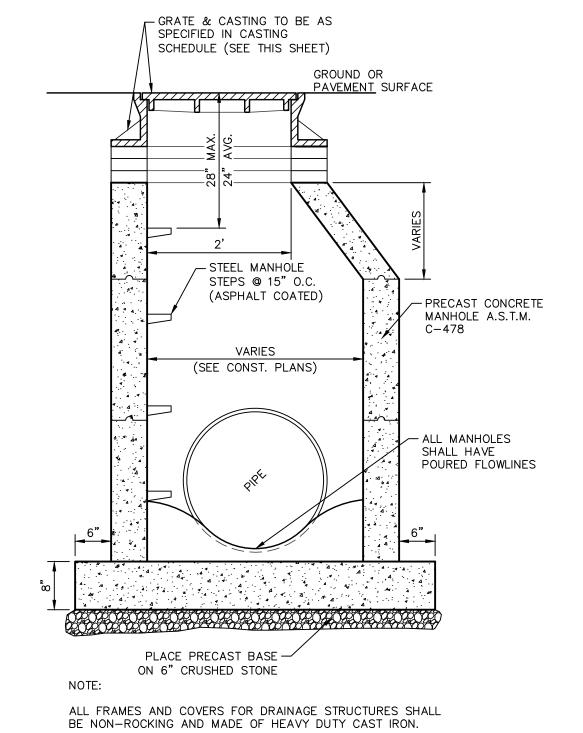



MANHOLE DETAIL

(NOT TO SCALE)

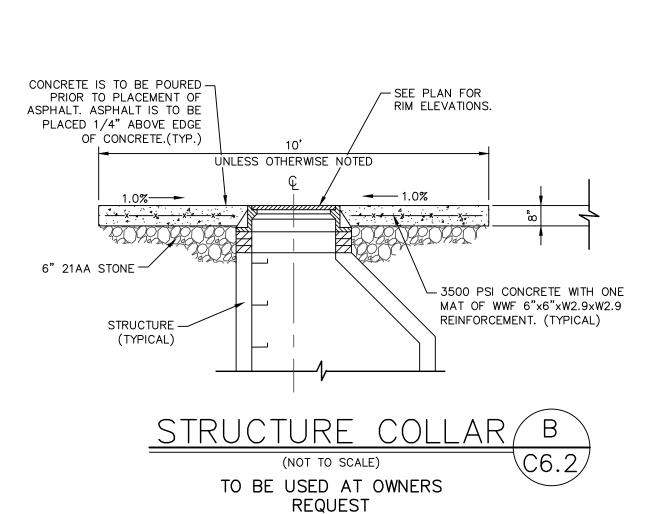

	MANHOLE/C	ATCH BASI	N
	CASTING	SCHEDULE	
DESIGNATION	E.J.I.W. #1040 W/ TYPE A COVER (OR EQUAL)	E.J.I.W. #7010 W/ TYPE M4 GRATE (OR EQUAL)	E.J.I.W. #7000 W/ TYPE M3 GRATE (OR EQUAL) M-2 BACK; T1 GRATE
CB 1			
CB 2			
MH 1			
3968			
3427			
MH 2			
MH 3			
MH 4			

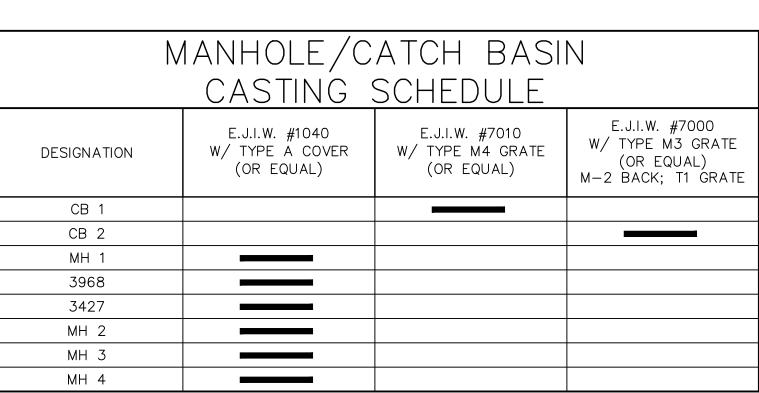


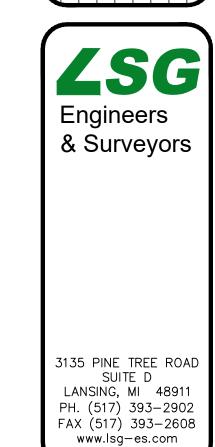






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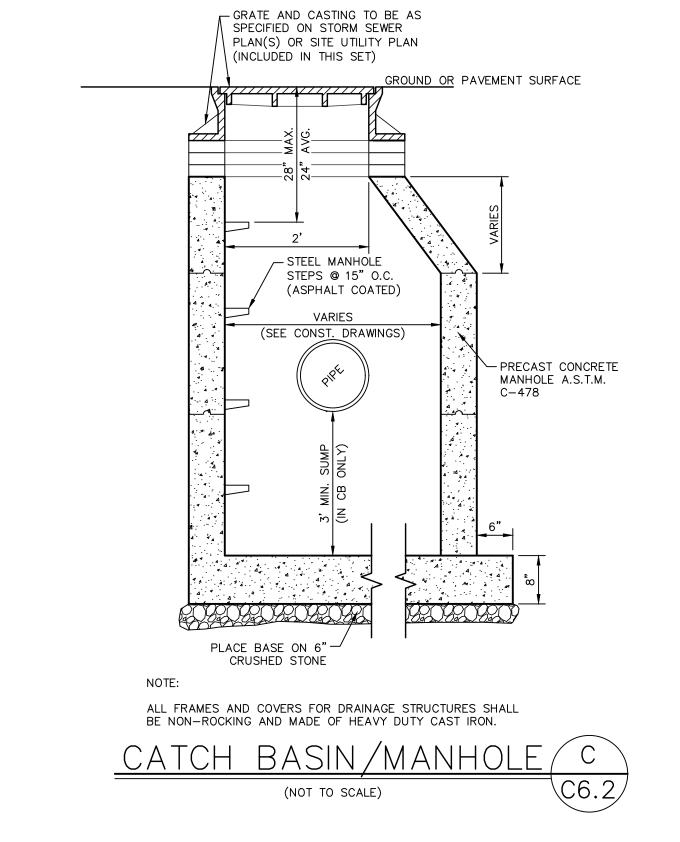
TYPICAL TRENCH DETAIL UNDER ROADBED OR WITHIN INFLUENCE OF ROADBED

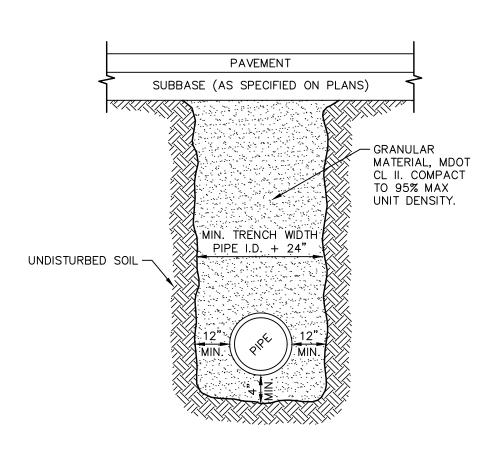



TYPICAL TRENCH DETAIL NOT UNDER ROADBED OR WITHIN INFLUENCE OF ROADBED C6.2

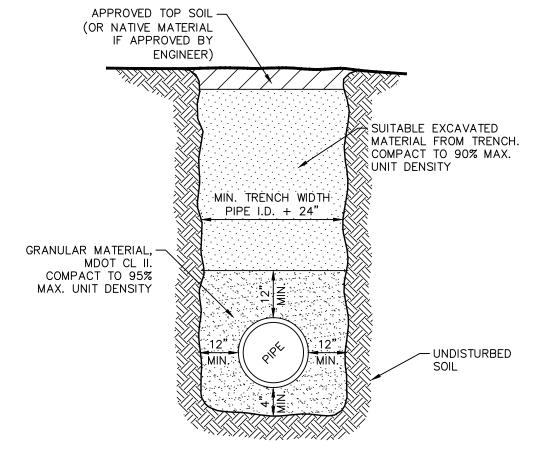

S	FILEC6-2.DWG DESIGNED BYADB DRAWN BYAJI CHECKED BYADB DATEMAY 24, 2021
0	SCALE HOR. N/A
3	vert. N/A
elow.	PROJECT NO. 2679
ou dig.	SHEET NO.



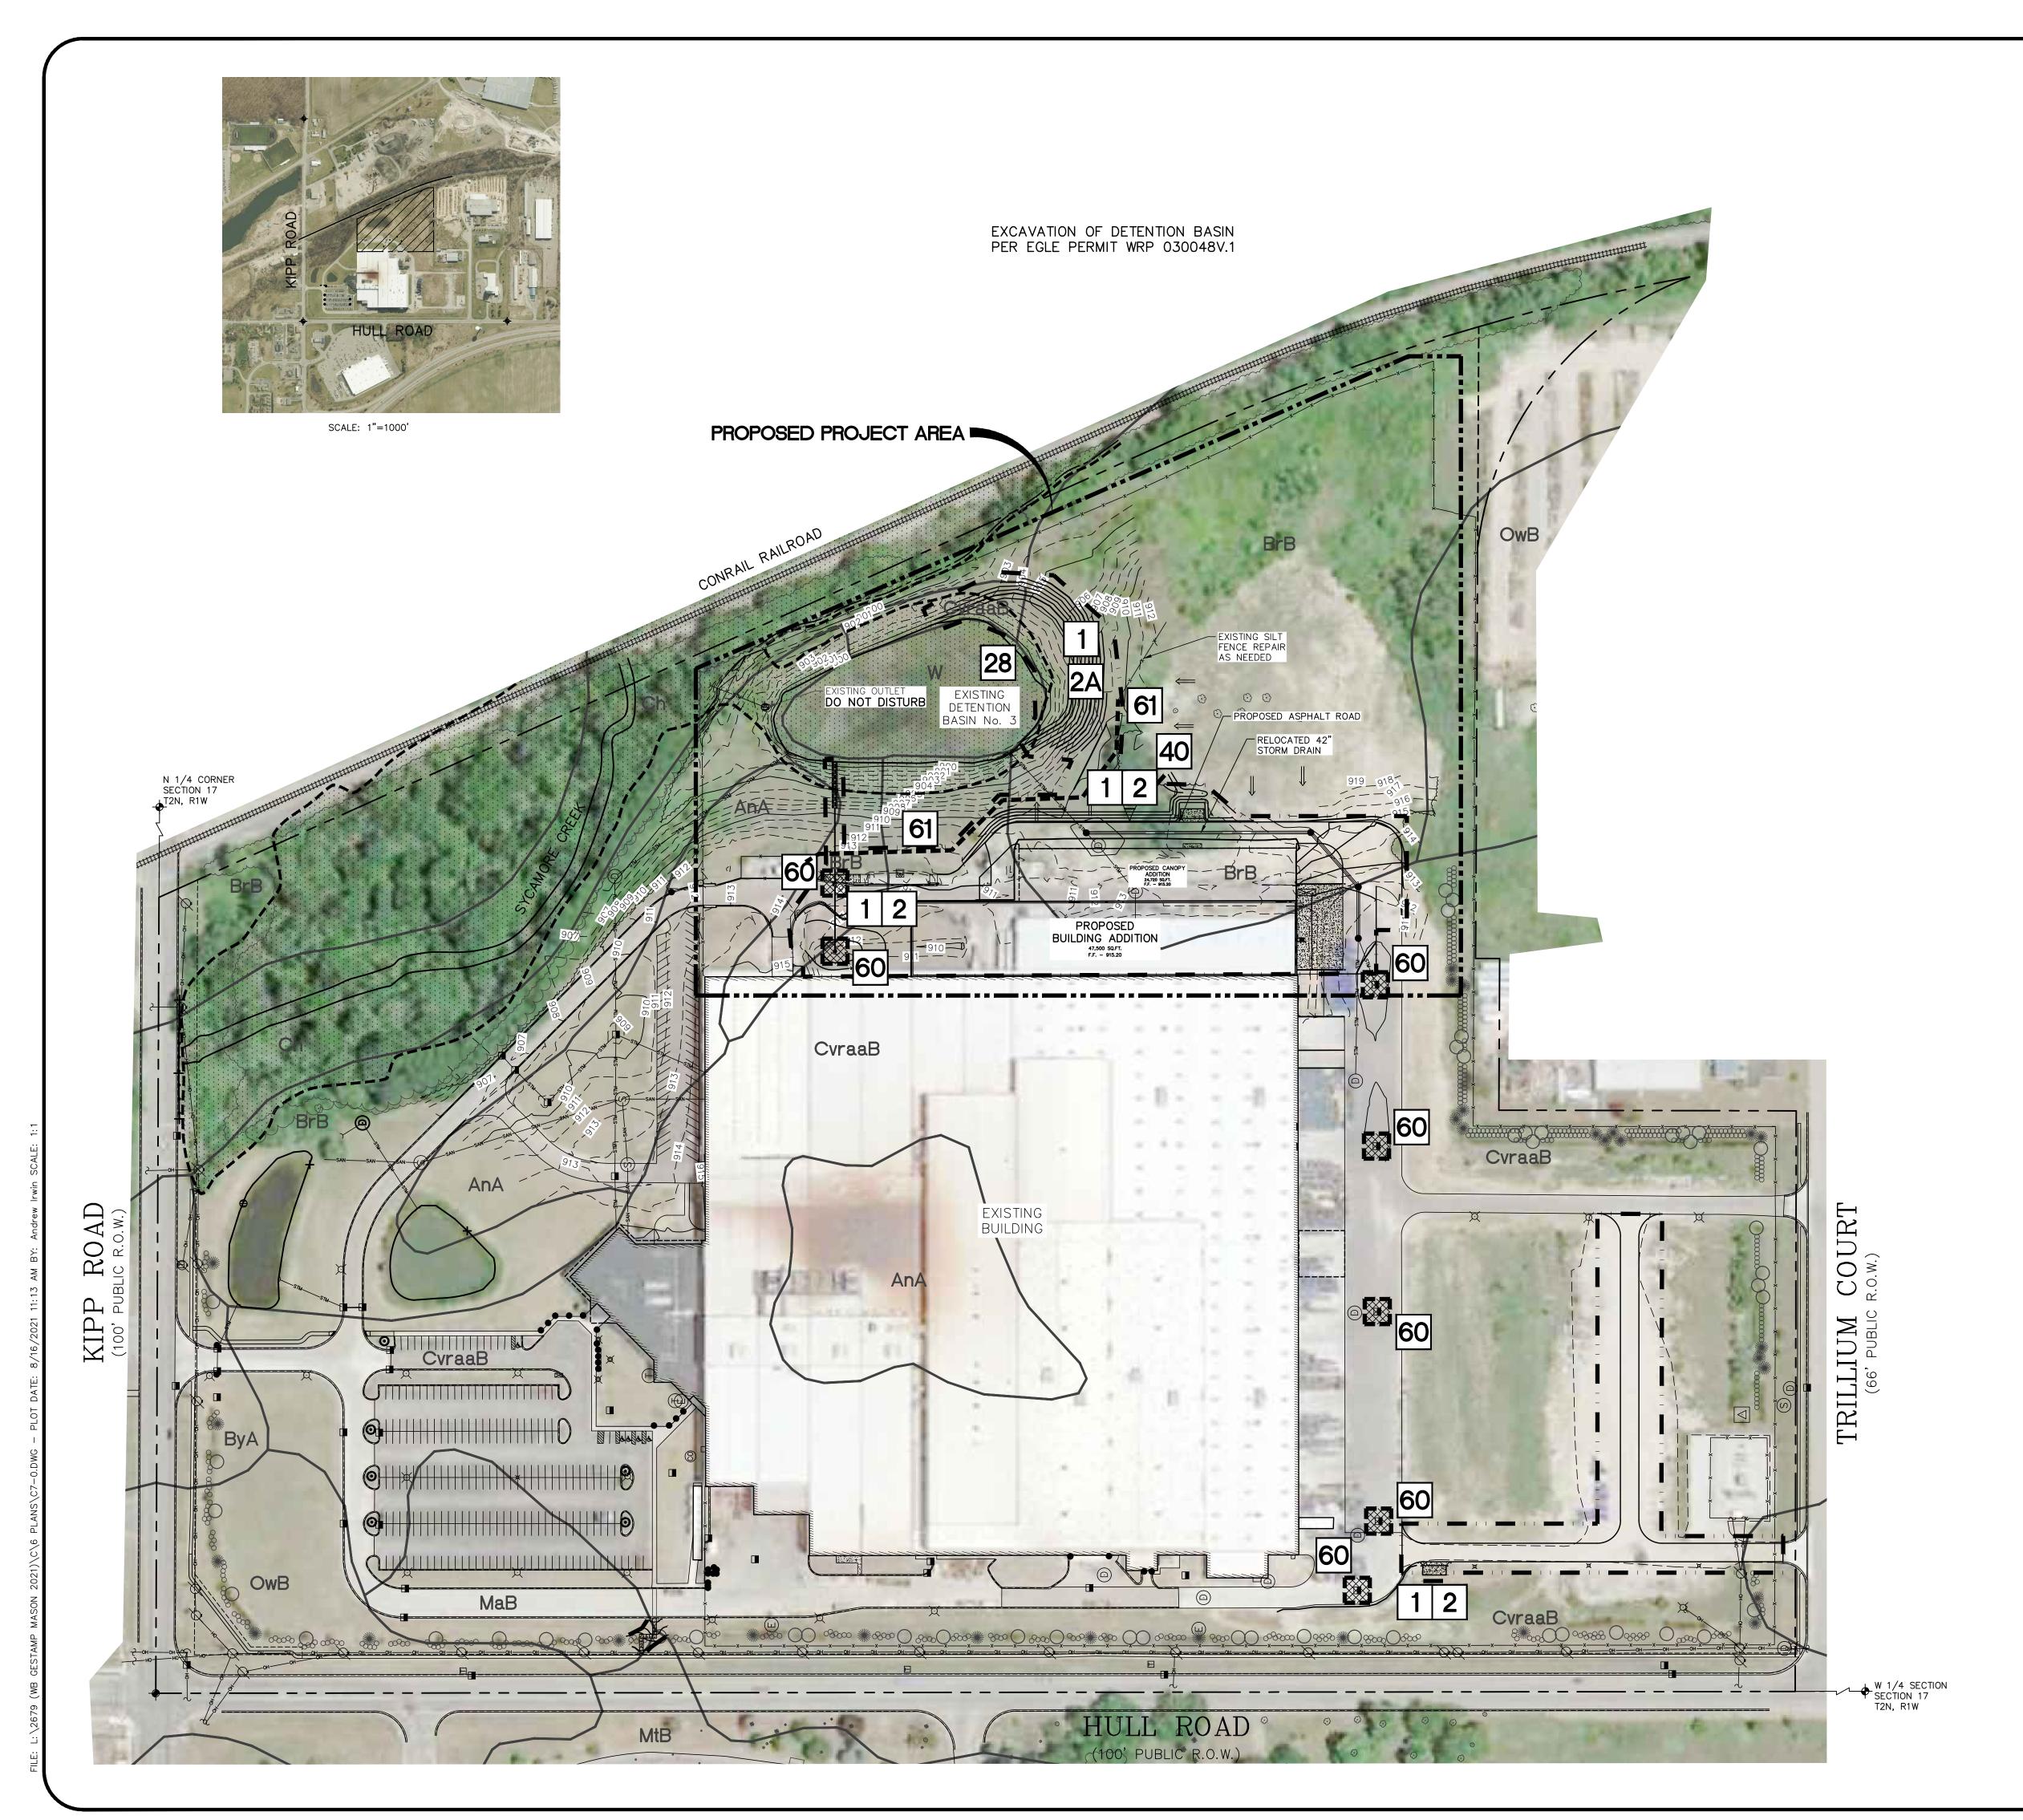

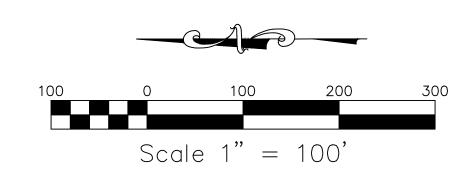

1. BENCHMARKS

#1. NORTHWEST FLANGE BOLT ON FIRE HYDRANT, 204'± NORTH AND 93'± WEST OF THE NORTHEAST CORNER OF BUILDING. ELEVATION: 908.84 (NAVD 88)

#2. NORTHWEST FLANGE BOLT ON FIRE HYDRANT, 81'± WEST AND 66'± SOUTH OF THE NORTHEAST CORNER OF BUILDING. ELEVATION: 915.75 (NAVD 88)

#3. NORTHWEST FLANGE BOLT ON FIRE HYDRANT, 88'± WEST AND 494'± SOUTH OF THE NORTHEAST CORNER OF BUILDING. ELEVATION: 912.53 (NAVD 88)

THE CONTRACTOR SHALL CALL "MISS DIG" AT 811 OR 1-800-482-7171
 AT LEAST THREE (3) WORKING DAYS (EXCLUDING WEEKENDS AND
 HOLIDAYS) PRIOR TO CONSTRUCTION.

J. LSG ENGINEERS & SURVEYORS WILL NOT BE RESPONSIBLE FOR FIELD DESIGN CHANGES MADE BY THE CONTRACTOR OR THE CONTRACTOR'S SURVEYOR WHERE THESE DESIGN CHANGES HAVE NOT BEEN APPROVED BY LSG ENGINEERS & SURVEYORS.

4. UNLESS OTHERWISE NOTED, ALL DIMENSIONS ARE TO THE FACE OF CURB AND ALL BUILDING AND PAVEMENT LINES ARE PARALLEL AND/OR PERPENDICULAR TO THE EAST WALL OF THE BUILDING.

LEGEND

INLET PROTECTION AT CB

26

REFERS TO THE APPROPRIATE S.E.S.C. KEYING SYSTEM DETAIL (SEE SHEET C7.1)

SILT FENCE AND LIMITS OF EARTH DISTURBANCE

NRCS SOIL BOUNDARY

LIMITS OF EARTH DISTURBANCE (NO SILT FENCE) 6.1 ACRES

SCS SOIL TYPES

AUBBEENAUBBEE-CAPAC SANDY LOAMS
(0 TO 3 PERCENT SLOPES)

BrB

BOYER SANDY LOAM

(0 TO 6 PERCENT SLOPES)

Ch

COHOCTAH SILT LOAM

CVraaB CONOVER LOAM (0 TO 4 PERCENT SLOPES)

OWOSSO-MARLETTE SANDY LOAMS
(2 TO 6 PERCENT SLOPES)

MANUAL KEYING SYSTEM

1					
	3. EROSION CONTROL MEASURES				
	KEY	SESC MEASURE			
Р	1	Seeding			
T	2	Mulch			
Т	2A	Mulch Blankets			
Т	6	Soil Binding Polymers			
T	28	Wattles			
	4. EROSION AND SEDIMENT CONTROL MEASURES				
Р	40	Check Dam			
Р	46	Stone Filter Berm			
	5. SEDIMENT CONTROL MEASURES				
T	60	Storm Drain Inlet Protection			
T	61	Silt Fence			
T	66	Stabilized Construction Area			



LSGEngineers
& Surveyors

3135 PINE TREE ROAD SUITE D LANSING, MI 48911 PH. (517) 393-2902 FAX (517) 393-2608 www.lsg-es.com

PREPARED FOR:

200 EAST KIPP ROAD
MASON, MICHIGAN 48854
PHONE # (517) 244-8800


WIFI.AND

WIELAND

4162 ENGLISH OAK DRIVE
LANSING, MICHIGAN 48911
PHONE # (517) 372-8650

FOR GESTAMP 2021 EXPANSION 200 EAST KIPP ROAD MASON, MI 48854

MISS DIG What's below. Call before you dig.

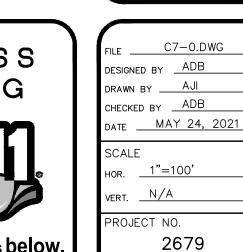

C7.0

DIVERSION RIDGE REQUIRED 2.0% OR GREATER WHERE GRADE EXCEEDS 2.0% EXISTING PAVED ROADWAY FILTER FABRIC SEDIMENT BARRIER -USE SANDBAGS, STRAW BALES OR OTHER APPROVED METHODS (STRAW BALE TYPE SPILLWAY SHOWN) TO CHANNELIZE RUNOFF TO BASIN AS REQUIRED. SUPPLY WATER TO -WASH WHEELS IF NECESSARY. AGGREGATE MINIMUM 6" THICK ─ DIVERSION RIDGE <u>PLAN</u>

> 1. THE ENTRANCE SHALL BE MAINTAINED IN A CONDITION THAT WILL PREVENT TRACKING OR FLOWING OF SEDIMENT ONTO PUBLIC RIGHTS-OF-WAY. THIS MAY REQUIRE TOP DRESSING, REPAIR AND/OR CLEANOUT OF ANY MEASURES USED TO TRAP SEDIMENT.

NOTES:

2. WHEN NECESSARY, WHEELS SHALL BE CLEANED PRIOR TO ENTRANCE ONTO PUBLIC RIGHT-OF-WAY.

3. WHEN WASHING IS REQUIRED, IT SHALL BE DONE ON AN AREA STABILIZED WITH CRUSHED STONE THAT DRAINS INTO AN APPROVED SEDIMENT TRAP OR SEDIMENT BASIN.

TEMPORARY GRAVEL

CONSTRUCTION ENTRANCE/EXIT/A 1994 JOHN McCULLAH


61. SILT FENCE MAINTENANCE INSPECT THE SILT FENCE ROUTINELY TO ASSURE IT HAS NOT BEEN


KNOCKED DOWN AND FOLLOWING A PRECIPITATION EVENT THAT RESULTS IN RUNOFF. REMOVE ALL SEDIMENT WHEN IT REACHES 50 PERCENT OF ITS CAPACITY AND MAKE REPAIRS PROMPTLY.

 MAINTAIN THE SILT FENCE UNTIL THE DISTURBED AREA IS COMPLETELY STABILIZED WITH AN EFFECTIVE VEGETATIVE COVER.

REMOVE ACCUMULATED SEDIMENT AND SILT FENCE AND VEGETATE THE

DISTURBED AREAS. SILT FENCE MAY BE REUSED.

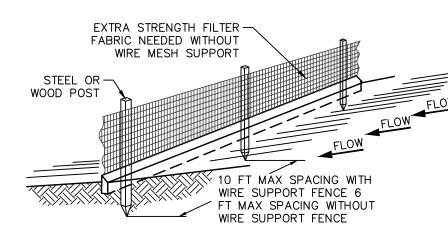

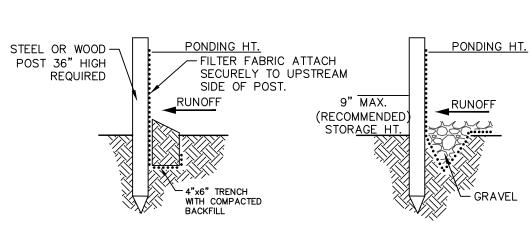

STANDARD DETAIL TRENCH WITH NATIVE BACKFILL ALTERNATE DETAIL TRENCH WITH GRAVEL

Engineers

& Surveyors

3135 PINE TREE ROAD SUITE D

LANSING, MI 48911

PH. (517) 393-2902

FAX (517) 393-2608

www.lsg-es.com

PREPARED FOR:

Gestamp (

200 EAST KIPP ROAD MASON, MICHIGAN 48854 PHONE # (517) 244-8800


4162 ENGLISH OAK DRIVE LANSING, MICHIGAN 48911 PHONE # (517) 372–8650


1. INSPECT AND REPAIR FENCE AFTER EACH STORM EVENT AND REMOVE SEDIMENT WHEN NECESSARY.

2. REMOVED SEDIMENT SHALL BE DEPOSITED TO AN AREA THAT WILL NOT CONTRIBUTE SEDIMENT OFF—SITE AND CAN BE PERMANENTLY STABILIZED.

3. SILT FENCE SHALL BE PLACED ON SLOPE CONTOURS TO MAXIMIZE PONDING EFFICIENCY.

C 1994 JOHN McCULLAH

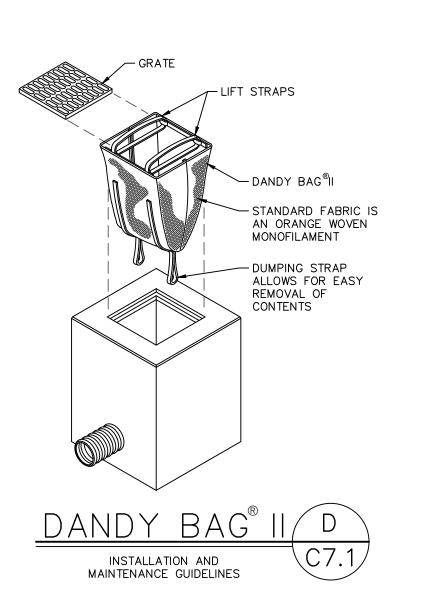

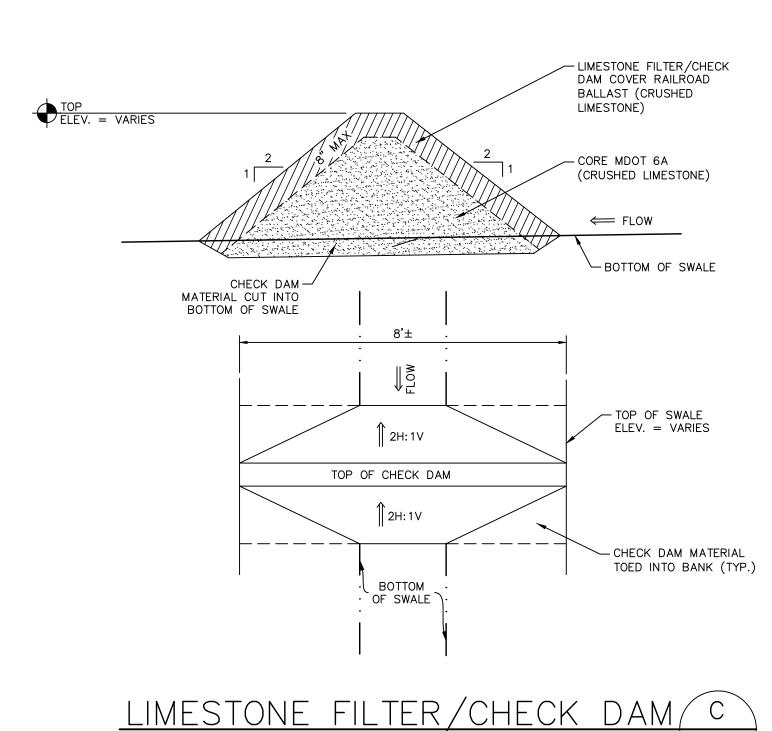

MISS Know what's below.

Call before you dig.

DESIGNED BY ADB DRAWN BY ____AJI CHECKED BY ADB DATE MAY 24, 2021 HOR. N/A VERT. N/A PROJECT NO.

ON AND

2679

C7.1

STANDARD EROSION AND

SEDIMENTATION CONTROL PLAN NOTES

- 1. BENCHMARKS
- #1. Northwest flange bolt on fire hydrant, 204'± North and 93'± West of the Northeast corner of building Elevation: 908.84 (NAVD 88)
- #2. Northwest flange bolt on fire hydrant, 81'± West and 66'± South of the Northeast corner of building. Elevation: 915.75 (NAVD 88)
- #3. Northwest flange bolt on fire hydrant, 88'± West and 494'± South of the Northeast corner of building Elevation: 912.53 (NAVD 88)
- 2. ALL WORK SHALL BE IN ACCORDANCE WITH EGLE (FORMERLY MDEQ) WRD PERMIT NUMBER (_X_) PERTAINING TO INLAND LAKES AND STREAMS, WETLAND PROTECTION AND FLOODPLAIN/WATER RESOURCES PROTECTION.
- 3. A SOIL EROSION CONTROL PERMIT SHALL BE OBTAINED FROM THE INGHAM COUNTY DRAIN COMMISSIONER PRIOR TO COMMENCING ANY GRADING ON
- 4. A NOTICE OF COVERAGE SHALL BE OBTAINED FROM THE EGLE PRIOR TO COMMENCING ANY GRADING ON SITE.
- 5. A FLOODPLAIN PERMIT SHALL BE OBTAINED FROM THE EGLE PRIOR TO COMMENCING ANY GRADING WITHIN THE 100 YEAR FLOODPLAIN.
- 6. CONTRACTOR IS TO CONTACT INGHAM COUNTY DRAIN COMMISSIONER AND LEROY TOWNSHIP AT LEAST THREE (3) DAYS PRIOR TO THE START OF
- 7. THE SITE IS MADE UP OF COHOCTAH SILT LOAM, LENAWEE SILTY CLAY LOAM, RIDDLES-HILLSDALE SANDY LOAMS AND SPINKS LOAMY SAND SOILS.
- 8. FOR LAND AREAS POSSESSING SLOPES EXCEEDING 15% THE CONTRACTOR
 - A. PROTECT AND STABILIZE AREAS THAT HAVE A HIGH POTENTIAL
 - B. ASSURE STRUCTURAL SAFETY AND MINIMIZE HARM TO THE ENVIRONMENT ASSOCIATED WITH THE DEVELOPMENT.
 - C. MINIMIZE GRADING THROUGHOUT THE SITE.
 - D. PROTECT AND PRESERVE ANY VALUABLE NATURAL WILDLIFE AND/OR PLANT HABITATS WHICH COINCIDES WITH THE STEEP-SLOPE AREAS OF THE SITE.
 - E. PROTECT WATER QUALITY ON AND AROUND THE SITE FROM THE ADVERSE EFFECTS OF THE PROPOSED USE.
 - F. PROTECT ANY STEEP SLOPES ON ADJOINING PROPERTIES.
- 10. ALL SLOPES GREATER THAN 6:1 SHALL BE SEEDED AND STABILIZED IMMEDIATELY AFTER GRADE IS ESTABLISHED.
- 11. CONTRACTOR IS RESPONSIBLE FOR INSTALLING AND MAINTAINING ALL SOIL EROSION CONTROL MEASURES ON A DAILY BASIS. DURING CONSTRUCTION OWNER SHALL MAINTAIN ALL PERMANENT S.E.C. MEASURES AFTER CONSTRUCTION IS COMPLETE.
- 12. ALL TEMPORARY S.E.C. MEASURES SHALL BE MAINTAINED UNTIL PERMANENT MEASURES ARE IN PLACE AND THE AREA IS STABILIZED. AT THIS TIME CONTRACTOR IS RESPONSIBLE FOR REMOVAL AND PROPER DISPOSAL OF THESE S.E.C. MEASURES.
- 13. ANY DISTURBED AREA ON WHICH ACTIVITY HAS CEASED AND WHICH WILL REMAIN EXPOSED FOR MORE THAN 20 DAYS MUST BE STABILIZED IMMEDIATELY. DURING NON-GERMINATING PERIODS, MUI CH MUST BE APPLIED AT THE RECOMMENDED RATES. DISTURBED AREAS WHICH ARE NOT AT FINISHED GRADE AND WHICH WILL BE REDISTURBED WITHIN 1 YEAR MAY BE STABILIZED IN ACCORDANCE WITH TEMPORARY SEEDING SPECIFICATIONS. DISTURBED AREAS WHICH ARE EITHER AT FINISHED GRADE OR WILL NOT BE FURBED WITHIN 1 YEAR MUST BE STABILIZED IN ACCORDANCE WITH PERMANENT SEEDING SPECIFICATIONS.

DSTURBANCE/MEASURE

1 INSTALL TEMPORARY SOIL EROSION AND SEDIMENTATION CONTROL MEASURES.

INITIAL EARTH MOVING TO CONSTRUCT RING ROAD AND

INSTALL PERMANENT SESC MEASURES, SEEDING, MULCH.

'CONSTRUCT BUILDING FOUNDATIONS AND SLABS.

SITE RESTORATION AND FINAL PERMANENT SESC

UTILITY RELOCATION. EXCAVATE DETENTION BASIN.

2 CLEARING AND GRUBBING.

5 RELOCATE UTILITIES.

6 CONSTRUCT RING ROAD.

9 ERECT BUILDING.

MEASURES.

10 INSTALL LANDSCAPE.

3 STRIP AND STOCKPILE TOPSOIL.

- 14. ONLY LIMITED DISTURBANCE WILL BE PERMITTED TO PROVIDE ACCESS TO THE SITE FOR GRADING AND TO CONSTRUCT SEDIMENT BASINS, SEDIMENT TRAPS, DIVERSION TERRACES, INTERCEPTOR CHANNELS, AND/OR CHANNELS OF CONVEYANCE AS APPROPRIATE.
- 15. ANY AREA SUSCEPTIBLE TO WIND EROSION, INCLUDING HAUL ROUTES AND STAGING AREAS SHALL BE SPRAYED TO MINIMIZE WIND-BORN PARTICLES.
- 16. THE PUBLIC ROAD SHALL BE INSPECTED AND SWEPT AS NEEDED ON A DAILY BASIS.
- 17. EROSION AND SEDIMENTATION CONTROLS MUST BE CONSTRUCTED, STABILIZED, AND FUNCTIONAL BEFORE SITE DISTURBANCE WITH THE TRIBUTARY AREAS OF THOSE CONTROLS.
- 18. AFTER FINAL SITE STABILIZATION HAS BEEN ACHIEVED, TEMPORARY EROSION AND SEDIMENTATION CONTROLS MUST BE REMOVED. AREAS DISTURBED DURING REMOVAL OF THE CONTROLS MUST BE STABILIZED
- 19. SILT FABRIC FENCE MUST BE INSTALLED AT LEVEL GRADE. BOTH ENDS OF EACH FENCE SECTION MUST EXTEND AT LEAST 10 FEET UPSLOPE AT 45 DEGREES TO THE MAIN FENCE ALIGNMENT.
- 20. SEDIMENT MUST BE REMOVED WHEN ACCUMULATIONS REACH 1/2 THE ABOVE GROUND HEIGHT OF THE SILT FENCE.
- 21. ANY SILT FENCE SECTION WHICH HAS BEEN UNDERMINED OR TOPPED MUST BE IMMEDIATELY REPLACED WITH A CHECK DAM.
- 22. STOCKPILE HEIGHTS MUST NOT EXCEED 35 FEET. STOCKPILE SLOPES MUST BE 2:1 OR FLATTER.
- 23. ANY DISTURBED AREA ON WHICH ACTIVITY HAS CEASED AND WHICH WILL REMAIN EXPOSED FOR MORE THAN 20 DAYS MUST BE STABILIZED IMMEDIATELY.
- 24. DIVERSIONS, CHANNELS, SEDIMENTATION BASINS, SEDIMENT TRAPS, AND STOCKPILES MUST BE STABILIZED IMMEDIATELY.
- 25. POLYACRYLAMIDES (SILT-STOP) SHALL BE USED ON THE SLOPED AREA OF THE CUT SITE TO MINIMIZE ERÓSION PRIOR TO ESTABLISHMENT OF PERMANENT SEEDING.
- 26. HAY OR STRAW MULCH MUST BE APPLIED AT RATES OF AT LEAST 3 TONS/ACRE.
- 27. THE AREAS SHOWN TO BE EMERGENT WETLAND SEEDING SHALL BE MULCHED ON THE SLOPED AREAS ONLY.
- 28. UNTIL THE SITE IS STABILIZED, ALL EROSION AND SEDIMENTATION MUST BE MAINTAINED PROPERLY. MAINTENANCE MUST INCLUDE INSPECTIONS OF ALL EROSION AND SEDIMENTATION CONTROL AFTER EACH RUNOFF EVENT AND ON A DAILY BASIS. ALL PREVENTATIVE AND REMEDIAL MAINTENANCE WORK, INCLUDING CLEAN OUT, REPAIR, REPLACEMENT, REGRADING, RESEEDING, REMULCHING, AND RENETTING, MUST BE PERFORMED IMMEDIATELY.
- 29. ENTIRE FILL AREA IS AN ACTIVE AGRICULTURAL PRODUCTION FIELD AND THEREFORE WILL NOT BE SEEDED WITH GRASS MIXES AFTER GRADING. THE AREA WILL BE SEEDED BY THE FARMER DURING SPRING PLANTING.

COMPLETE

START

EACH WORK AREA SHALL BE FULLY RESTORED AND READY FOR PERMANENT SESC MEASURES BEFORE CONTRACTOR CAN COMMENCE WORK AT OTHER AREAS. PERMANENT SESC MEASURES SHALL BE COMPLETED WITHIN 5 CALENDAR DAYS. CONTRACTOR SHALL PROVIDE A DETAILED CONSTRUCTION SEQUENCE BASED ON CONTRACT DATES. THE CONSTRUCTION

SEQUENCE SCHEDULE SHALL BE INCORPORATED INTO PLANS ISSUED FOR CONSTRUCTION.

30. DEWATERING IS NOT ANTICIPATED. IF DEWATERING IS REQUIRED DURING CONSTRUCTION, A DEWATERING PLAN WILL BE REQUIRED TO BE SUBMITTED AND APPROVED PRIOR TO THE COMMENCEMENT OF DEWATERING.

AUG. 31 - SEPT. 3 - SEPT. 10 - SEPT. 17

| SEPT. 10 | SEPT. 24

2021

2021

SEPT. 3

2021

SOIL EROSION CONTROL SCHEDULE

THIS NARRATIVE IS TO ACCOMPANY THE EROSION AND SEDIMENTATION CONTROL PLAN FOR THE GESTAMP MASON 2021 EXPANSION PREPARED BY LSG ENGINEERS & SURVEYORS OF LANSING, MICHIGAN, AND SHALL BE CONSIDERED A PART OF THE EROSION AND SEDIMENTATION CONTROL PLAN.

- THE PROJECT SITE IS LOCATED IN SECTION 16, T2N, R1W, VEVAY TOWNSHIP, INGHAM COUNTY, MICHIGAN,
- I. GENERAL STATEMENT OF THE PROJECT
- A. THE PROPOSED IMPROVEMENTS WITHIN THE SITE INCLUDE THE CONSTRUCTION OF COMPENSATION CUT AREA AND FILL AREA.
- B. THE AREAS OF PROPOSED EARTH DISTURBANCE ARE SHOWN ON THE SOIL EROSION CONTROL PLAN.
- C. THE STORM WATER MANAGEMENT FACILITIES ARE REQUIRED.
- D. THE STORM WATER CALCULATIONS FOR THE SITE ARE REQUIRED. ACCELERATED EROSION AND SEDIMENTATION SHALL BE LIMITED BY THE STABILIZATION OF DISTURBED AREAS AS SOON AS POSSIBLE. IN ADDITION, LIMITS OF EARTHMOVING HAVE BEEN IDENTIFIED FOR EACH PHASE OF THE SOIL EROSION CONTROL PLAN. THE CONTRACTOR SHALL NOTE THE SCHEDULE FOR EARTHMOVING AND INTERIM STABILIZATION AND THE RESTRICTIONS IMPOSED ON STARTING THE NEXT PHASE.
- F. ALL DISTURBED AREAS INTENDED TO BE LAWN OR GRASS AREAS SHALL, IMMEDIATELY AFTER FINAL GRADING, BE SEEDED PER THE PERMANENT STABILIZATION MIX AND MAINTAINED.
- G. THE AREA SHOWN TO BE SEEDED WITH EMERGENT WETLAND SEEDING SHALL BE SOWN AFTER THE SLOPED AREAS ABOVE THEM ARE SEEDED AND MULCHED.
- H. CONSTRUCTION ON THIS PROJECT SHOULD BEGIN IN FALL 2021. II. TOPOGRAPHIC FEATURES OF THE PROJECT AREA

OBSERVATION AND ARE SHOWN ON THE PLAN.

- THE LOCATION OF THE SITE, CONTOURS, PROPERTY LINES, ACREAGE AND ALL OTHER PHYSICAL FEATURES WERE LOCATED BY THE USE OF GROUND
- III. TYPES, DEPTH, SLOPE AND AREAL EXTENT OF SOILS.
- THE ENTIRE SITE IS MADE UP OF COHOCTAH SILT LOAM, LENAWEE SILTY CLAY LOAM, RIDDLES-HILLSDALE SANDY LOAMS AND SPINKS LOAMY SAND
- IV. PROPOSED ALTERATION TO THE AREA
- ALL PROPOSED ALTERATIONS ARE SHOWN ON THE PLAN. PROPOSED GRADES HAVE BEEN SELECTED KEEPING IN MIND THE EXISTING DRAINAGE PATTERNS. THE GRADING PLAN WILL INDICATE THE FINAL GRADES OF THE
- V. AMOUNT OF RUNOFF FROM THE PROJECT AREA AND THE JPSTREAM WATERSHED

□CT. 1 -

N0V, 5

2021

NDV, 5 -

MAY 1

2021/2022

APR. 1 -

MAY 15

2022

- THE AMOUNTS OF RUNOFF FROM THE PROJECT AREA OR FROM THE UPSTREAM WATERSHED WILL BE KEPT TO A MINIMUM BY THE USE OF SOIL EROSION CONTROL MEASURES.
- VI. STAGING OF EARTHMOVING ACTIVITIES SEE TABLE BELOW:

□CT. 1

□CT, 1

2021

□CT, 15

2021

- VII. TEMPORARY CONTROL MEASURES AND FACILITIES FOR USE DURING EARTHMOVING TOPSOIL STOCKPILES: STOCKPILES SHALL BE USED TO CONTAIN ALL STRIPPED TOPSOIL IN A
- FORTH IN THE INTERIM STABILIZATION GUIDELINES. B. STABILIZED CONSTRUCTION ENTRANCES: THIS ENTRANCE PROTECTION FACILITY SHALL BE USED TO KEEP

LIMITED AREA IN ORDER TO KEEP THE DISTURBED AREA TO A MINIMUM.

BE STABILIZED WITH A TEMPORARY COVER CROP OF GRASS AS SET

- STORMWATER FROM FLOWING UNCHECKED FOR THE SITE AND TO COLLECT SEDIMENT OFF THE CONSTRUCTION VEHICLES.
- SILT FENCES SHALL BE LOCATED AS SHOWN ON THE PLAN TO SLOW RUNOFF FROM DRAINAGE WAYS AND EXPOSED BANKS AND TO PREVENT SEDIMENT FROM FLOWING ONTO ADJACENT PROPERTIES.
- TEMPORARY SEEDING: SEE TEMPORARY SEEDING AS NOTED ON THE PLANS.
- TO TEMPORARILY PROTECT VEGETATION DURING EARLY STAGES OF GROWTH OR PERMANENTLY TO REDUCE FLOW VELOCITIES.
- THE CUT AREA WILL ACT AS A TEMPORARY SEDIMENTATION BASIN UNTIL THE SITE IS STABILIZED.
- ENTIRE FILL AREA IS AN ACTIVE AGRICULTURAL PRODUCTION FIELD AND THEREFORE WILL NOT BE SEEDED WITH GRASS MIXES AFTER GRADING. THE AREA WILL BE SEEDED BY THE FARMER DURING SPRING PLANTING.
- H. APPLY DUST CONTROL AS NEEDED TO PREVENT WIND EROSION ALONG HAUL
- APPLY POLYACRYLAMIDES ON THE SLOPES OF THE CUT AREAS TO MINIMIZE EROSION. SWEEP PUBLIC ROADS AS NEEDED TO PREVENT TRACKING OF SOIL OFF
- VIII. PERMANENT CONTROL MEASURES AND FACILITIES FOR LONG ERM PROTECTION
- PERMANENT STABILIZATION OR PERMANENT SEEDING: SEE PERMANENT STABILIZATION AS NOTED ON PLANS.
- HAY OR STRAW MULCH SHALL BE APPLIED TO SEEDING AREAS TO HELP ESTABLISH A PERMANENT GRASS COVER AND TO PREVENT EROSION. IT SHALL BE APPLIED AT THE RATE OF 3 TONS PER ACRE.
- EROSION CONTROL BLANKETS OR FABRIC: IN AREAS WHERE THE SLOPE EXCEEDS 3H:1V, NORTH AMERICAN GREEN S75 SOIL EROSION CONTROL BLANKET SHALL BE INSTALLED TO PREVENT EROSION.
- IN AREAS WHERE STABILIZATION IS FOUND TO BE DIFFICULT, THE DEVELOPER MAY INSTALL SOD. SOD MATERIAL, PLACEMENT AND STAKING SHALL CONFORM TO THE GUIDELINE SPECIFICATIONS FOR SODDING BY THE AMERICAN SOD PRODUCERS ASSOCIATION.
- E. PERMANENT STABILIZATION ENERGY DISSIPATERS OR ROCK RIP RAP SLOPE SEE PERMANENT STABILIZATION AS NOTED IN THE PLANS. ROCK RIP RAP SLOPE PROTECTION INVOLVES THE PLACEMENT OF ROCK RIP RAP ON GEOTECHNICAL FABRIC.
- F. ENTIRE FILL AREA IS AN ACTIVE AGRICULTURAL PRODUCTION FIELD AND THEREFORE WILL NOT BE SEEDED WITH GRASS MIXES AFTER GRADING. THE AREA WILL BE SEEDED BY THE FARMER DURING SPRING PLANTING.
- IX. TEMPORARY MAINTENANCE PROGRAM FOR THE CONTRO ACILITIES INCLUDING DISPOSAL OF MATERIALS REMOVED FROM THE CONTROL FACILITIES
- A. ALL SEDIMENT AND EROSION CONTROL FACILITIES SHALL BE CHECKED FOR DAMAGE AFTER EACH STORM. ALL FACILITIES THAT ARE DAMAGED, CLOGGED OR CAN NO LONGER PERFORM THE FILTRATION OR SEDIMENTATION OF SUSPENDED SOILS SHALL BE REPLACED.
- ANY SEEDED AREAS THAT BECOME ERODED SHALL HAVE THE TOPSOIL REPLACED, THE GRASS SEED RESOWN AND MULCH REAPPLIED, OR AT THE DIRECTION OF THE OWNER, SOD MAY BE INSTALLED.
- X. PERMANENT MAINTENANCE PROGRAM FOR THE CONTROL
- AFTER THE SITE IS PERMANENTLY STABILIZED ALL SEDIMENT AND EROSION CONTROL FACILITIES AT THE CUT SITE SHALL BE CHECKED MONTHLY DURING THE REMAINDER OF THE GROWING SEASON. ALL FACILITIES THAT ARE DAMAGED. CLOGGED OR CAN NO LONGER PERFORM THE FILTRATION OR SEDIMENTATION OF SUSPENDED SOILS SHALL BE REPAIRED OR REPLACED.
- B. ANY PERMANENT SEEDED AREAS THAT BECOME ERODED SHALL HAVE THE TOPSOIL REPLACED, THE GRASS SEED REGROWN AND MULCH REAPPLIED.
- XI. EQUITABLE OWNER / DEVELOPER / RESPONSIBLE PARTY
- **DURING CONSTRUCTION:**
- TO BE DETERMINED.
- AFTER SITE STABILIZATION / PROJECT COMPLETION: BLAKE SIMON WEILAND
- PROPERTY OWNER 4162 ENGLISH OAK DRIVE
- LANSING, MICHIGAN 48911 PHONE: (517) 372-8650

INGHAM COUNTY DRAIN COMMISSIONER

STANDARD NOTES

- APPROVAL OF THIS PERMIT DOES NOT AUTHORIZE ANY EARTH DISTURBANCE ACTIVITY IN STATE REGULATED WETLANDS, FLOODPLAINS, OR INLAND STREAMS EXCEPT AS APPROVED AND STOCKPILES THAT WILL EXIST BETWEEN 20 DAYS AND 12 MONTHS SHALL AUTHORIZED BY ISSUED MDEQ PERMIT WRP 030048v.1.
 - AN INGHAM COUNTY INSPECTOR IS TO VERIFY PROPER INSTALLATION OF THE SESC MEASURES FOR EACH PHASE PRIOR TO COMMENCEMENT OF THE EARTH DISTURBANCE IN EACH PHASE AS AUTHORIZED HEREIN (CONTACT JASON LYNN. 719.4901, TO ARRANGE FOR THIS INSPECTION).
 - THE PERMIT SHALL BE POSTED AT THE CONSTRUCTION ENTRANCE TO THE SITE, VISIBLE FROM A PUBLIC ROAD, UNTIL THE LAND IS PERMANENTLY STABILIZED AND THE INGHAM COUNTY DRAIN COMMISSIONER'S OFFICE CLOSES THE PERMIT. LAMINATING THE PERMIT WILL HELP IT TO WITHSTAND THE WEATHER.
 - 4. CONTACT INFORMATION FOR ALL ON-SITE CONTRACTORS WHO WILL BE DISTURBING THE EARTH, INCLUDING ON-SITE CONTACT PERSON, OFFICE, MOBILE PHONE NUMBER, EMAIL ADDRESS, AND BUSINESS ADDRESS, SHALL BE PROVIDED TO THE INGHAM COUNTY DRAIN COMMISSIONER'S OFFICE, ATTENTION JASON LYNN, PRIOR TO THAT COMPANY'S COMMENCEMENT OF ANY EARTH DISTURBANCE AUTHORIZED BY THIS PERMIT.
 - UNTIL THE SITE IS PERMANENTLY STABILIZED AND THE PERMIT IS CLOSED. THE INGHAM COUNTY DRAIN COMMISSIONER'S OFFICE SHALL BE COPIED THE NPDES WEEKLY LOG REPORTS REFERENCED IN THE SOIL EROSION NOTES, BY THE SECOND AND FOURTH FRIDAY EACH MONTH. REPORTS SHOULD BE SENT TO THE ATTENTION OF JASON LYNN AND REFERENCE SEP XX-XXXX. PLEASE ALSO SUBMIT A COPY OF THE NOTICE OF COVERAGE FOR THE SITE PRIOR TO COMMENCEMENT OF EARTH DISTURBANCE AUTHORIZED HEREIN.
 - THE FOLLOWING GENERAL CONDITIONS APPLY TO THE EARTH CHANGE AUTHORIZED BY THIS PERMIT:
 - 6.1. DESIGN, CONSTRUCT AND COMPLETE THE EARTH CHANGE IN A MANNER THAT LIMITS THE EXPOSED AREA OF DISTURBED LAND FOR THE SHORTEST PERIOD OF TIME;
 - 6.2. REMOVE SEDIMENT CAUSED BY ACCELERATED SOIL EROSION FROM RUNOFF WATER BEFORE IT LEAVES THE SITE OF THE EARTH CHANGE:
 - 6.3. TEMPORARY OR PERMANENT CONTROL MEASURES SHALL BE DESIGNED AND INSTALLED TO CONVEY WATER AROUND. THROUGH OR FROM THE EARTH CHANGE AT NON-EROSIVE
 - 6.4. INSTALL TEMPORARY SOIL EROSION AND SEDIMENTATION CONTROL MEASURES BEFORE OR UPON COMMENCEMENT OF THE EARTH CHANGE ACTIVITY AND MAINTAIN THESE MEASURES ON A DAILY BASIS. REMOVE TEMPORARY SOIL EROSION AND SEDIMENTATION CONTROL MEASURES AFTER PERMANENT SOIL EROSION CONTROL MEASURES ARE IN PLACE AND STABILIZED; AND,
 - 6.5. COMPLETE PERMANENT SOIL EROSION CONTROL MEASURES FOR THE EARTH CHANGE WITHIN FIVE CALENDAR DAYS

INTERIM STABILIZATION

AFTER FINAL GRADING OR UPON COMPLETION OF THE FINAL EARTH CHANGE. IF IT IS NOT POSSIBLE TO PERMANENTLY STABILIZE THE EARTH CHANGE. THEN MAINTAIN TEMPORARY SOIL EROSION AND SEDIMENTATION CONTROL MEASURES UNTIL PERMANENT SOIL EROSION CONTROL MEASURES ARE IN PLACE AND THE AREA STABILIZED.

- 7. THE LANDOWNER (PERMITTEE), CONTRACTOR(S) AND ANY AGENT INVOLVED IN OBTAINING OR EXERCISING AND PERFORMING THE EARTH DISTURBANCE WORK AUTHORIZED BY THIS PERMIT, ARE ALL HELD RESPONSIBLE TO ENSURE THAT THE WORK IS PERFORMED IN ACCORDANCE WITH ALL APPROVED PLANS, SPECIFICATIONS AND CONDITIONS CONTAINED AND PERMITTED HEREIN. PRIOR TO INITIATING EARTH DISTURBANCE AUTHORIZED HEREIN. THE PERMITTEE IS REQUIRED TO PROVIDE A COPY OF THE PERMIT AND APPROVED SESC PLAN TO ANY CONTRACTOR(S) AND AGENTS INVOLVED WITH EARTH DISTURBANCE WORK. THE CONTRACTOR(S) AND AGENTS ARE REQUIRED TO PROVIDE A COPY OF THE PERMIT AND APPROVED SESC PLAN TO ALL SUBCONTRACTORS INVOLVED WITH EARTH DISTURBANCE WORK.
- 8. IF PROPERTY SUBJECT TO THIS SOIL EROSION AND SEDIMENTATION CONTROL PERMIT IS TRANSFERRED, THE PERMIT, INCLUDING ALL PERMIT OBLIGATIONS AND CONDITIONS, ARE TRANSFERRED WITH THE PROPERTY ALONG WITH THE RESPONSIBILITY FOR ANY VIOLATIONS OF THE PERMIT THAT EXIST ON THE DATE OF THE TRANSFER OF THE PROPERTY. A PARCEL OF THE PROPERTY, BUT NOT THE ENTIRE PROPERTY IS TRANSFERRED. THE PERMIT OBLIGATIONS AND CONDITIONS WITH RESPECT TO THAT PARCEL ARE TRANSFERRED, BUT NOT THE PERMIT, ALONG WITH THE RESPONSIBILITY FOR ANY VIOLATIONS OF THE PERMIT WITH RESPECT TO THAT PARCEL THAT EXIST ON THE DATE OF THE TRANSFER OF THE PARCEL NOTICE OF PROPERTY OR PARCEL TRANSFERS SHALL BE SUBMITTED TO THE INGHAM COUNTY DRAIN COMMISSIONER'S OFFICE PRIOR TO TRANSFER AND SHALL OTHERWISE BE IN COMPLIANCE WITH MCL 324.9112. MAINTENANCE RESPONSIBILITIES SHALL BECOME PART OF ANY SALES AGREEMENTS FOR THE LAND ON WHICH THE PERMANENT SESC MEASURES ARE LOCATED.
- THE PERMIT WILL NOT BE CLOSED UNTIL ALL EARTH DISTURBANCE IS STABILIZED AND THE TEMPORARY MEASURES HAVE BEEN REMOVED.





Engineers & Surveyors

3135 PINE TREE ROAD SUITE D LANSING, MI 48911 PH. (517) 393-2902 FAX (517) 393-2608 www.lsg-es.com

₄estamp 200 EAST KIPP ROAD MASON, MICHIGAN 48854

PHONE # (517) 244-8800

PREPARED FOR



LANSING, MICHIGAN 48911 PHONE # (517) 372-8650

20 IST N.S.T


STABILIZATION INFORMATION


<u>SEED</u>	<u>TYPES</u>	% BY WEIGHT	<u>RATES</u>	<u>DATES</u>
FORMULA E	ANNUAL RYEGRASS	100%	10.0 LBS/1000 SY	MARCH 15 TO OCT 15
LIME	PULVERIZED AG. LIMESTONE		800 LBS/ACRE	
FERTILIZER	10-20-20		140 LBS/ACRE	
MULCH	HAY OR STRAW		3 TONS/ACRE FOR AREAS EXPOSED MORE THAN 20 DAYS	
PERMANENT (PERMANENT	STABILIZATION SEEDING)			
SEED	<u>TYPES</u>	% BY WEIGHT	<u>RATES</u>	DATES
FORMULA B	PERENNIAL RYE GRASS	20%	4.0 LBS/1000 SY	MARCH 15 TO JUNE 1
	CREEPING RED FESCUE	30%	6.0 LBS/1000 SY	AUGUST 1 TO OCT 15
OR	KENTUCKY BLUE GRASS	50%	11.0 LBS/1000 SY	
OI (
FORMULA D	TALL FESCUE	70%	15.0 LBS/1000 SY	MARCH 15 TO JUNE 1
	CREEPING RED FESCUE	30%	6.0 LBS/1000 SY	AUGUST 1 TO OCT 15
LIME	PULVERIZED AG. LIME STONE		800 LBS./ACRE	
FERTILIZER	10-20-20		140 LBS/ACRE	
MULCH	HAY OR STRAW		3 TONS/ACRE FOR AREAS EXPOSED MORE THAN 20 DAYS	
	STABILIZATION RAP SLOPE PROTECTION)			

MISS Know what's **below**.


DESIGNED BY ADB DRAWN BY ____AJI CHECKED BY ADB DATE <u>MAY 24, 2021</u> SCALE HOR. <u>N/A</u> /ERT. <u>N/A</u> PROJECT NO.


2679 Call before you dig. SHEET NO. C7.2

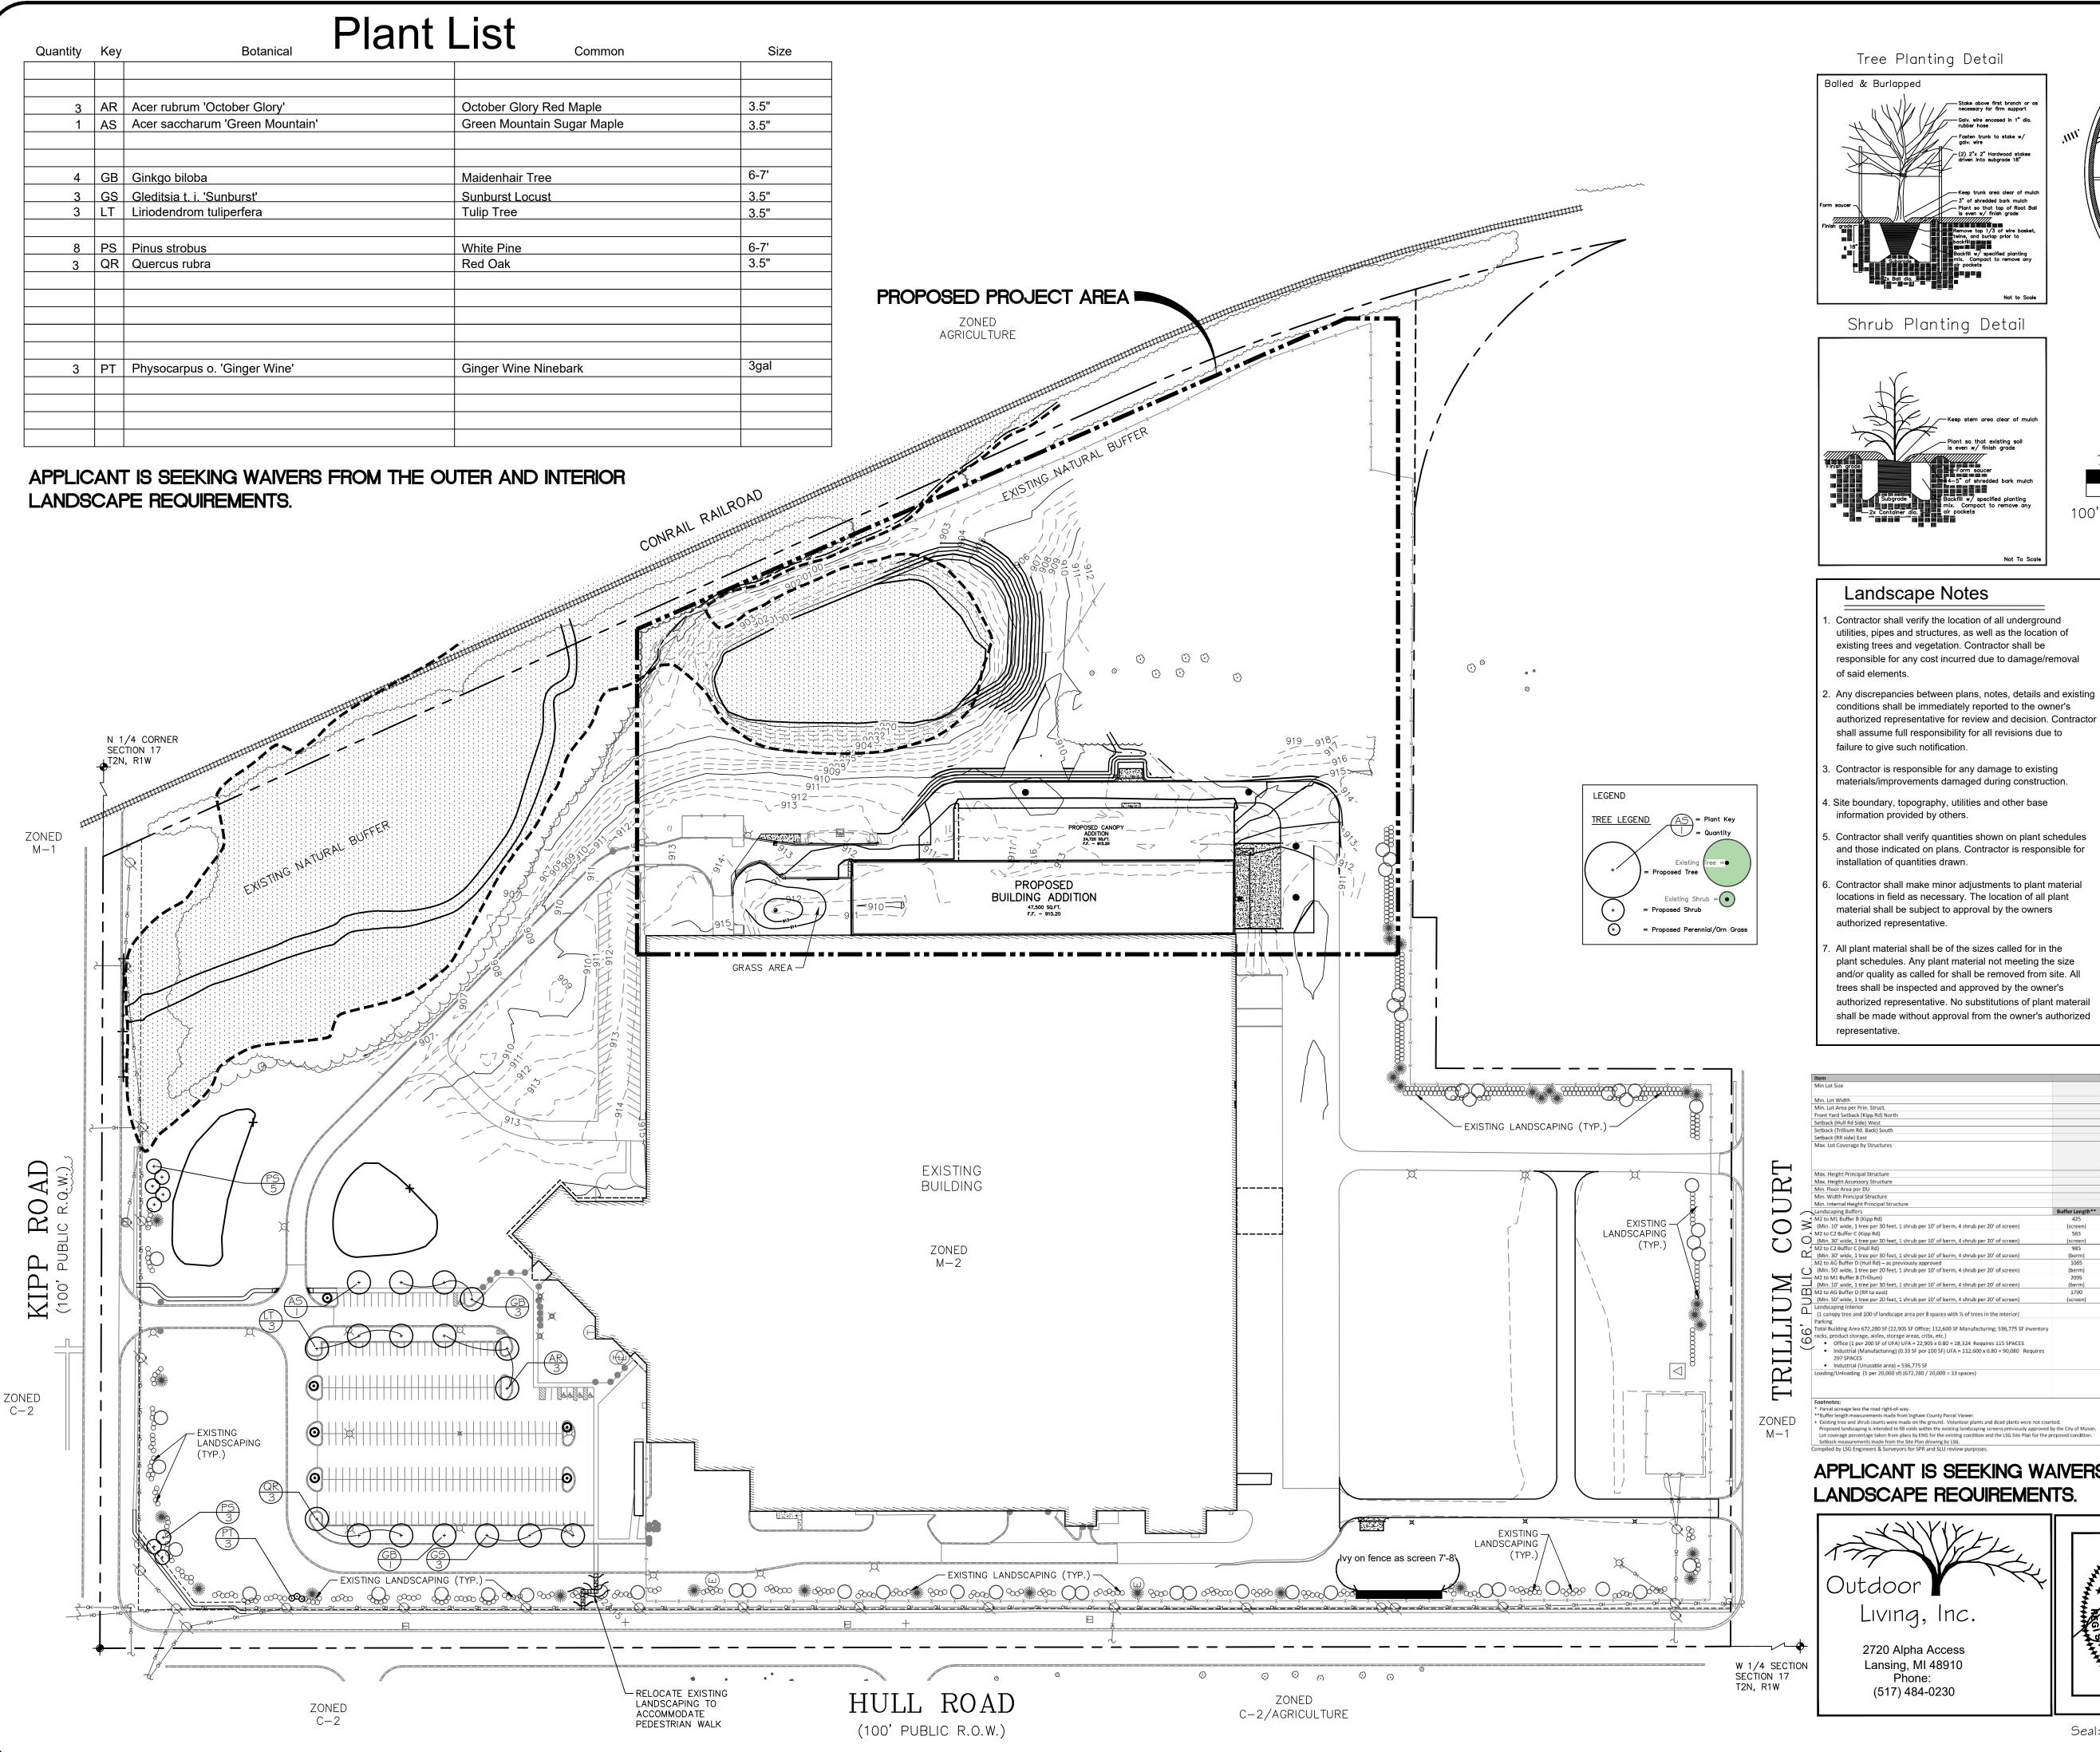

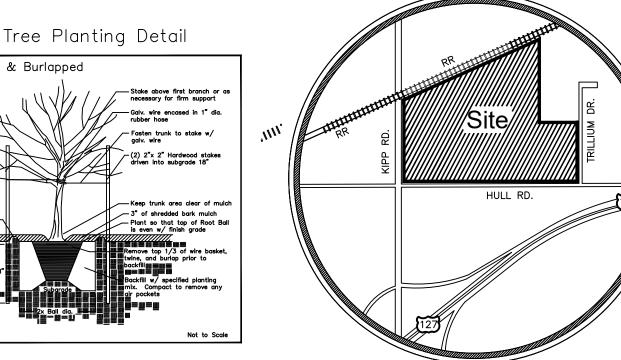



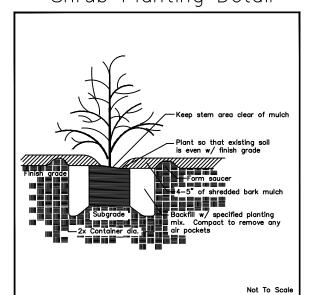

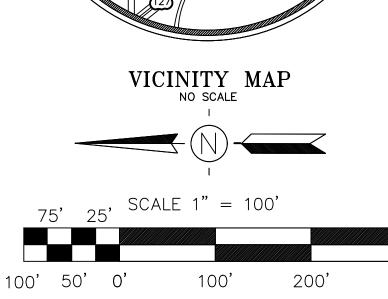

Landscape Notes

- . Contractor shall verify the location of all underground utilities, pipes and structures, as well as the location of existing trees and vegetation. Contractor shall be responsible for any cost incurred due to damage/removal of said elements.
- . Any discrepancies between plans, notes, details and existing conditions shall be immediately reported to the owner's authorized representative for review and decision. Contractor shall assume full responsibility for all revisions due to failure to give such notification.
- . Contractor is responsible for any damage to existing materials/improvements damaged during construction.
- . Site boundary, topography, utilities and other base information provided by others.
- Contractor shall verify quantities shown on plant schedules and those indicated on plans. Contractor is responsible for installation of quantities drawn.
- Contractor shall make minor adjustments to plant material locations in field as necessary. The location of all plant material shall be subject to approval by the owners
- . All plant material shall be of the sizes called for in the plant schedules. Any plant material not meeting the size and/or quality as called for shall be removed from site. All trees shall be inspected and approved by the owner's authorized representative. No substitutions of plant materail shall be made without approval from the owner's authorized

- . All planting beds to be Contractor shall insure resistant to the herbicid application follows the manufacturer's specifications and is applied in accordance with sound horticultural practices.
- 9. Contractor shall determine appropriate planting mixes (based on soils/subsurface conditions) and review altern-
- 0. All plant beds and maintenance edges around structure will be mulched with washed Michigan Stone (2"dia) over commercial weed barrier. All plants will have a small ring of shredded hardwood bark mulch 3"-4" deep over the root system as specified.
- 1. If lawn is to be sodded, us a locally grown Kentucky Bluegrass variety that is free of weeds.
- 12. Seed lawn areas with the following mixture: 10% Perennial Rye Grass
- Apply seed at the rate of 7-8lbs/1000sqft
- 13. Commercial Grade Plastic Edge will be Edg-King from Oly-Ola, Inc., (or better)
- be placed in a planting bed at least 8'-wide, shall be at least 2'-high at the initial planting, be expected to grow to a height of at least 3' in the front yard, 5' in the side yard and 8' in the rear yard, within two (2) years of planting.

	SUITE D
	LANSING, MI 48911
e treated with pre-emergent herbicide. e that proposed plant material is ide properties and that herbicide	PH. (517) 393-2902 FAX (517) 393-2608 www.lsg-es.com
manufacturar's appointantions and is	

Engineers

& Surveyors


3135 PINE TREE ROAD


PREPARED FOR:

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200 EAST KIPP ROAD MASON, MICHIGAN 48854 PHONE # (517) 244-8800

4162 ENGLISH OAK DRIVE LANSING, MICHIGAN 48911 PHONE # (517) 372–8650



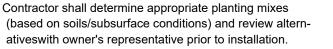

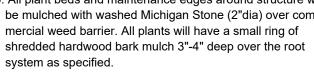25% Sybsport Kentucky Bluegrass 25% Nassam Kentucky Bluegrass 25% Sybsport Kentucky Bluegrass


14. Plant material installed for a perimeter landscape screen shall

		Required	Existing	Proposed
,		60,000 sf	59.40 Ac*	59.40 Ac*
			(2,587,450± sf)	(2,587,450± sf)
		200	1,033±	1,033±
			N/A	N/A
		60	486	486
		20	98	98
		20	262	231
		20	385	385
		50%	24.1%	26.0%
		A	(Bldg 624,780 sf)	(Bldg 672,280 sf)
		A	(includes existing 24,720 sf storage canopy	(includes 47,500 sf proposed building addition and
		A	which is proposed to be removed)	proposed 24,720 sf storage canopy)
		45	42	42
		45	N/A	N/A
			N/A	N.A
			N/A	N/A
ture		·	N/A	N/A
	Buffer Length**			
	425	15 trees	Natural buffer across the floodplain of Sycamore	Natural buffer across the floodplain of Sycamore
1 shrub per 10' of berm, 4 shrub per 20' of screen)	(screen)	43 shrubs	Creek	Creek
	565	19 trees	8 trees+	8 Exist + 8 Prop = 16
1 shrub per 10' of berm, 4 shrub per 20' of screen)	(screen)	113 shrubs	92 shrubs+	92 Existing
	985	33 trees	16 trees+	16 Existing
, 1 shrub per 10' of berm, 4 shrub per 20' of screen)	(berm)	99 shrubs	134 shrubs+	134 Exist + 3 Prop = 137
eviously approved	1065	54 trees	15 trees+	15 Exist
1 shrub per 10' of berm, 4 shrub per 20' of screen)	(berm)	107 shrubs	106 shrubs+	106 Exist
	2095	70 trees	40 trees+	40 Exist
, 1 shrub per 10' of berm, 4 shrub per 20' of screen)	(berm)	210 shrubs	226 shrubs+	226 Exist
	1790	90 trees	Natural buffer of undeveloped land, the railroad	Natural buffer of undeveloped land, the railroad
, 1 shrub per 10' of berm, 4 shrub per 20' of screen)	(screen)	358 shrubs	and Sycamore Creek between the land uses	and Sycamore Creek between the land uses
The state of the beautiful		41 trees	5 trees+	5 Exist + 17 Prop = 22
pe area per 8 spaces with ½ of trees in the interior)	+	4137 sf	15,140 sf	15,140 sf
,905 SF Office; 112,600 SF Manufacturing; 536,775 SF inventory age areas, cribs, etc.) N) UFA = 22,905 x 0.80 = 18,324 Requires 115 SPACES (0.33 SF per 100 SF) UFA = 112,600 x 0.80 = 90,080 Requires		115 + 297 = 412 spaces	331 spaces	331 + 92 banked = 423 spaces
= 536,775 SF				
rf) (672,280 / 20,000 = 33 spaces)		33 spaces	20 loading doors/docks + 8 additional loading areas in and along the south and east sides of the building Total Existing 28	20 loading doors/docks + 8 additional loading areas (2 of the 8 additional will be replaced with new docks on the existing building) + 4 new doc and 1 new loading door Total Proposed 33

APPLICANT IS SEEKING WAIVERS FROM THE OUTER AND INTERIOR LANDSCAPE REQUIREMENTS.



2720 Alpha Access Lansing, MI 48910 Phone: (517) 484-0230

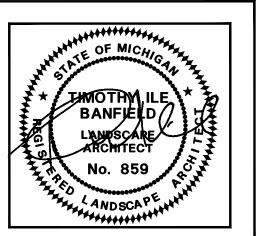

Seal: Timothy I. Banfield PLA ASLA LIC #3901000859

MISS DESIGNED BY ADB DRAWN BY ____AJI__ SCALE Know what's below. Call before you dig. SHEET NO.

CHECKED BY ADB DATE <u>MAY 24, 2021</u> HOR. ___1"=100' VERT. 1"=100' PROJECT NO. 2679

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