City of Yelm Public Hearing before the Hearing Examiner May 23, 2024 at 9AM

Title: Country I		1eadows Estate Phase	e 1	File number: 202	3.0163
Project		The applicant proposes a two-phase development with Phase 1 creating 59 single family			
Description:		residential lots.			
Develop	er:	Evan Mann for Coppe	er Ridge LLC, PO Bo	x 73790, Puyallup, WA 9	8373
Parcel n	umber:	227304103000	Parcel size:	9.84 acres; approx. 428	3,630 sq ft
Zoning:		R-6, Moderate densit	y residential		

Background

The proposed Country Meadows site is approximately 9.84 acres on Parcel 22730410300. The site is vacant land and was recently annexed into the city of Yelm and is zoned R-6, Moderate-Density residential. The proposal will include 59 single-family, detached residences in Phase 1. The development will include infrastructure improvements, including stormwater management facilities, utilities, sewer, recreational open space, and public roads.

This project is intended to be independent of any future phases of development. The Phase 1 improvements provide connectivity to two separate locations of an existing arterial road (Vancil Road SE). The plat will provide a road stub to a proposed future development known as Country Meadows Estates Phase 2. This road stub will provide connectivity to that project after Phase 1 is completed. A TIA has been submitted with this application that provides traffic volumes for the Phase 1 development. Per the traffic engineer, the TIA does not cover future phases of development because that provides a more conservative traffic analysis.



Country Meadows Estates Phase 1 has a connection to sewer and water out to Vancil Road SE. The sewer and water are looped through the plat from Vancil Road SE south along Road B and then west back out to Vancil Road SE. Water is stubbed to the future development Phase 2 as a future connection.

Stormwater runoff from this plat is managed independently of future phases of development. The plat will include its own underground infiltration and treatment system, specifically sized to manage stormwater from the public right-of-way and open space tracts. Stormwater runoff from the individual lots will be collected and infiltrated on lot in individual drywells or infiltration systems. Final design will be in accordance with the most recent Washington State Department of Ecology Stormwater Management Manual for Western Washington (SWMMWW).

CONSTRUCTION SCHEDULE

Construction of Phase 1 is expected to begin in the fall of 2024. The second phase of development, which is being submitted under separate application, is anticipated to begin construction in the spring of 2025. If the Phase 2 development is delayed, Phase 1 will be completed with connectivity to this offsite parcel to allow expansion of the residential neighborhood in the future, per City of Yelm standards. The developer is aware that the hearing examiner's approval of the Preliminary Plat is good for five years and will require a public hearing, decision of approval, and construction plan approvals.

The proposed preliminary plat and project description are attached as Exhibit A.

Notice of Application

This project was declared a complete application on November 1, 2023.

Published in the Nisqually Valley News on November 9, 2023.

Mailed to property owners within 300 feet on November 16, 2023.

The comment period ended on December 1, 2023. All public comments are attached as Exhibit B.

Environmental Review

Supporting documents submitted with the SEPA checklist are as follows:

- Stormwater Report by AHBL
- GeoTech Report by Earth Solutions NW
- Traffic Impact Analysis by Heath and Associates
- Morris Road Mazama Pocket Gopher and Regulated Prairie Absence Report by Land Services

The SEPA checklist was distributed to affected agencies November 9, 2023, via email.

An DNS for this project was issued on March 7, 2024. Exhibit C contains the distribution list, SEPA checklist, supporting documents, comments from affected agencies, and the final determination.

Notice of Public Hearing

Notice of this public hearing was published in the Nisqually Valley News on May 9, 2023.

Notice of the public hearing was mailed to all property owners within 300 feet of the site on May 9, 2023. As of the date of this report, no public comments have been received.

Code Review

YMC 18.32.020 Permitted uses.

The following uses are allowed within the moderate-density residential zoning district, subject to the project approvals and design standards of the Unified Development Code:

- A. Single-family residential units;
- B. Duplexes;
- C. Multifamily dwellings;
- D. Townhouses;
- E. Manufactured housing communities;
- F. Planned residential development;
- G. Secondary dwelling units;
- H. Residential care facilities;
- I. Home occupations;
- J. Family home child care providers;
- K. Attached and co-located wireless facilities:
- L. Essential public facilities.

Staff finds that the proposal for 59 single family homes is permitted.

YMC 18.59.030 Multiple building and large lot development.

For developments with multiple buildings or large lots, mitigate impacts with the following:

- A. Provide for connecting streets and public transportation.
- B. Connect all on-site activities to adjacent pedestrian routes and street rights-of-way.
- C. Design buildings to complement adjacent activities and visual character.
- D. Incorporate open space and landscaping as a unifying element.
- E. Incorporate screening, environmental mitigation, utilities and drainage as positive design elements.

Staff finds that all public transportation and pedestrian routes are connected in a way consistent with the City's street plans. Staff further finds that this development is bordered by single family homes to the east and north and as such will complement the adjacent activities. Landscaping, utilities and screening will be addressed through the civil process.

YMC 18.14.050 Preliminary subdivisions.

- 1. When Required. A preliminary subdivision is required for the division of land into 25 or more lots for the purpose of sale, lease, or transfer of ownership, or for the division of land into 10 or more lots when a public hearing on an administrative subdivision is requested pursuant to RCW 58.17.095(1).
- 2. Decision Making Authority. The hearing examiner shall process preliminary subdivisions as provided in Chapter 18.10 YMC.
- 3. Criteria for Approval. A preliminary subdivision shall be approved if:
 - 1. Appropriate provisions are made for the public health, safety and general welfare and for such open spaces, drainage ways, streets or roads, alleys, other public ways, transit stops, potable water supplies, sanitary wastes, parks and recreation, playgrounds, schools and school grounds, sidewalks and other features assuring safe walking conditions for students who only walk to and from school;
 - 2. The public use and interest will be served by the platting of such subdivision and any dedication:
 - 3. The proposed subdivision is in conformity with applicable zoning and other development regulations;
 - 4. Public facilities impacted by the proposed subdivision will be adequate and available to serve the subdivision concurrently with the development or a plan to finance needed public facilities in time to assure retention of an adequate level of service;

- 5. The project is within an approved sewer service area with capacity to serve all lots within the subdivision.
- 4. Term. Approval of a preliminary subdivision shall be for five years from the date of approval.

Staff finds that all appropriate provisions are made for public health, safety and general welfare as noted in YMC 18.14.050(C)(1). Staff further finds that the public use and interest will be served by this subdivision and it is consistent with all applicable zoning and development regulations. Public facilities impacted by this proposal are adequate and available and the approved sewer service area has capacity to serve the development.

Staff recommendation

Staff recommends preliminary approval of Country Meadows Estate Phase 1 be approved with the following conditions:

- 1. All plans must be updated and resubmitted, addressing comments on the marked up plans attached. Exhibit D.
- 2. Please provide fire flow, lighting plan, monument plans and the detail, retaining wall calculation and details, and Signature Approval Block (leave room the electronic signature block (4" wide x 2" high) All Sheets) by the time of submitting for the Civil Plan Review.
- 3. The side walk on the cul-de-sac should be continued to the middle of it'
- 4. Please provide the information for existing/abandon well and septic.
- 5. Landscaping:
 - a. Please provide a note and detail (City of Yelm Development Guidelines Chapter 2 Transportation Details DWG. NO. 2-19) for all the trees that planted within 6' of the curb or sidewalk must have a root barrier (by the time of submitting for the Civil Plan Review).
 - b. YMC 18.55.020 Types of landscaping.
 - i. "f. Planting theme shall be a ratio of three street trees to one accent tree."
 - c. Please provide a list of existing trees including the ones that will be removed from the site and the ones that will be retained.
 - d. Please include the scientific name.
- 6. Justify how track A, B, and D meet the open space requirements. If they do not meet this requirement, the plans must be updated to meet the City's open space requirement.
- 7. Please make sure all the submittals are the most current ones and consistent with each other (for example see landscaping plans page L1 and C6.1), and if you are submitting a landscaping plan along with the preliminary plans, you don't need to provide a separate document.
- 8. The proposed water main along Road C needs to be extended through Tract C and tie into the main on Vancil Rd.
- 9. Preliminary approval for this project is for only five (5) years from the date of the decision. Knowledge of this deadline is the sole responsibility of the applicant, and notifications of deadlines may not be issued prior to the deadline.

Exhibit A: Preliminary Plat and project description

Exhibit B: Public comments

Exhibit C: SEPA distribution list, SEPA checklist, supporting documents, comments from affected


agencies, and the final determination.

Exhibit D: Marked up civil plans.



COUNTRY MEADOWS ESTATES PHASE 1 PRELIMINARY PLAT

A PORTION OF THE NE 1/4 OF THE SE 1/4 OF SEC. 30, TWN. 17 N., RGE. 02 E., W.M., CITY OF YELM, THURSTON COUNTY, WASHINGTON.

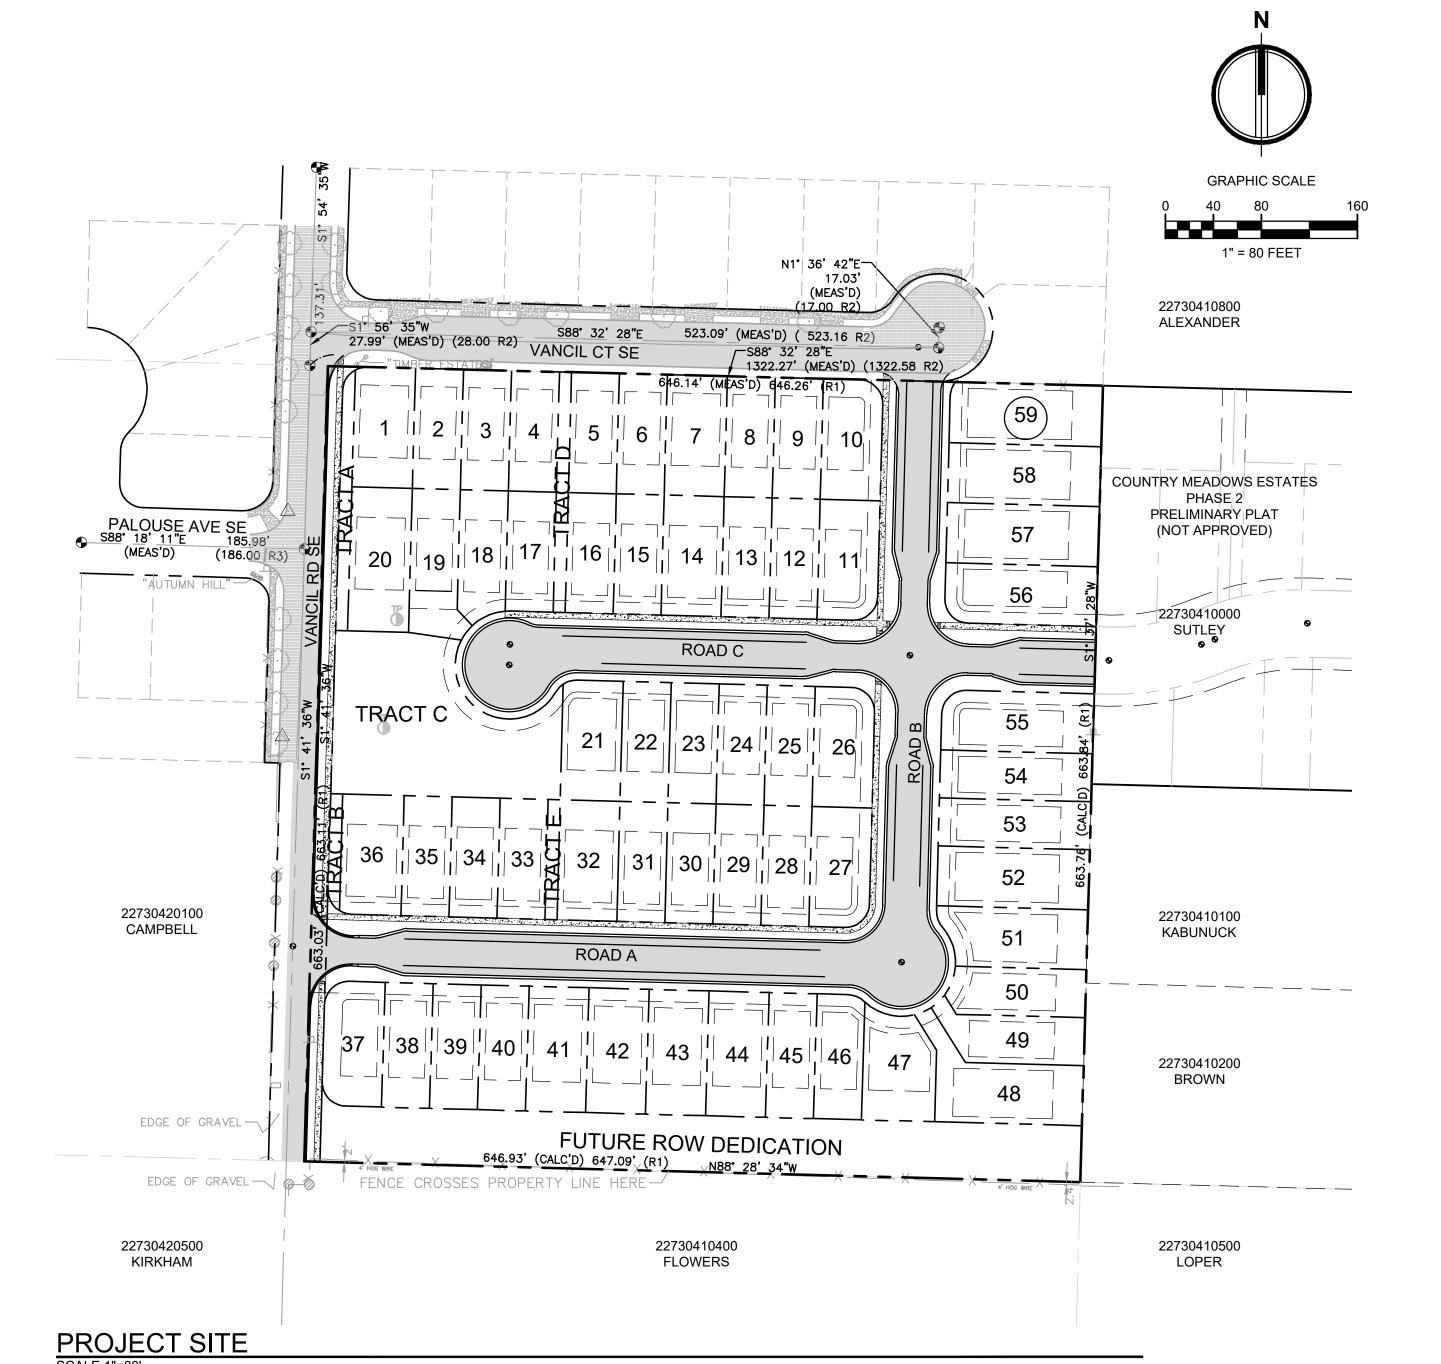

TRENCH NOTE

HEALTH ACT, CHAPTER 49.17 RCW.

TO THE PROJECT SITE.

WETLAND DELINEATION

IF WORKERS ENTER ANY TRENCH OR OTHER EXCAVATION FOUR OR MORE

CONTRACTOR ALONE SHALL BE RESPONSIBLE FOR WORKER SAFETY AND

AHBL ASSUMES NO RESPONSIBILITY. ALL TRENCH SAFETY SYSTEMS SHALL

MEET THE REQUIREMENTS OF THE WASHINGTON INDUSTRIAL SAFETY AND

NO WETLANDS HAVE BEEN DELINEATED ON-SITE OR IMMEDIATELY ADJACENT

FEET IN DEPTH THAT DOES NOT MEET THE OPEN PIT REQUIREMENTS OF

WSDOT SECTION 2-09.3(3)B, IT SHALL BE SHORED AND CRIBBED. THE

DEVELOPER

COPPER RIDGE, LLC P.O.BOX 73790 PUYALLUP, WA 98403 CONTACT: EVAN MANN

CIVIL ENGINEER

AHBL ENGINEERS, PLANNERS, & SURVEYORS 2215 NORTH 30TH STREET, SUITE 300 TACOMA, WA 98403 PH. (253) 383-2422 FAX (253) 383-2572 CONTACT: MATT WEBER, P.E.

SURVEYOR

AHBL ENGINEERS, PLANNERS. & SURVEYORS 2215 NORTH 30TH STREET, SUITE 300 TACOMA, WA 98403 PH. (253) 383-2422 CONTACT: DAVE FOLLANSBEE, PLS.

LEGAL DESCRIPTION

THE NORTHWEST QUARTER OF THE NORTHEAST QUARTER OF THE SOUTHEAST QUARTER OF SECTION 30, TOWNSHIP 17 NORTH, RANGE 2 EAST, W.M.;

EXCEPTING THEREFROM THE WEST 15 FEET FOR COUNTY ROAD KNOWN AS VANCIL ROAD, THURSTON COUNTY, WASHINGTON.

THERE IS NO MENTION OR DEPICTION OF SAID DITCH ON SAID

VERTICAL DATUM

NAVD 1988 VERTICAL DATUM ON ORTHOMETRICALLY CORRECTED GPS OBSERVATIONS USING WSRN AND GEOID

BASIS OF BEARING

WASHINGTON STATE PLANE SOUTH PROJECTION, BASED ON GPS OBSERVATIONS USING WSRN AND GEOID 2012A. UNITS OF MEASUREMENT ARE US SURVEY FEET.

> VANCIL RD SE YELM, WA 98597

SITE DATA

PARCEL NUMBER: 22730410300

ADDRESS:

EARTHWORK QUANTITIES

DO THEY ACCOUNT FOR ROADWAY SECTION.

NOTE:
THE ABOVE QUANTITIES ARE ESTIMATES ONLY INTENDED FOR
THE ABOVE QUANTITIES ARE ESTIMATES ONLY INTENDED FOR BID PURPOSES.

THE PERMITTING PROCESS. DO NOT USE FOR BID PURPOSES. THE QUANTITIES DO NOT HAVE STRIPPING, COMPACTION, OR

CUT OR FILL ADJUSTMENT FACTORS APPLIED TO THEM, NOR

CUT = 7,700 CU. YDS FILL = 5,700 CU. YDS

NET = 2,000 CU. YDS EXPORT

428,902 SF (9.84 AC) SITE AREA:

EXISTING ZONING: R6, RESIDENTIAL

VICINITY MAP SCALE: 1" = 1,320' (1/4 MILE)

LEGEND PROPOSED EXISTING FOUND MONUMENT AS NOTED SET NAIL AND WASHER MAIL BOX **GATE POST** TEST PIT SANITARY SEWER CLEANOUT STORM CATCH BASIN GAS VALVE **GUY ANCHOR** UTILITY POWER POLE LUMINAIRE **BLOW OFF VALVE** FIRE HYDRANT HOSE BIB IRRIGATION CONTROL VALVE WATER METER WATER MANHOLE WATER VALVE DECIDUOUS TREE U=UNKNOWN STORM LINE SEWER PAINT LINE GAS LINE ELECTRICAL LINE OVERHEAD UTILITIES FENCE **ASPHALT** CONCRETE

Sheet List Table COVER SHEET EXISTING CONDITIONS PLAT MAP ROAD A CONCEPT PLAN AND PROFILE ROAD B CONCEPT PLAN AND PROFILE ROAD C CONCEPT PLAN AND PROFILE VANCIL RD SE CONCEPT PLAN AND PROFILE CONCEPT GRADING PLAN CONCEPT STORM PLAN CONCEPT UTILITY PLAN CONCEPTUAL LANDSCAPE PLAN

Sheet Number | Sheet Title

2215 North 30th Street, Suite 300 Tacoma, WA 98403 Project Title: **COUNTRY MEADOWS ESTATES**

PHASE 1 PRELIMINARY PLAT

COPPER RIDGE LLC

P.O.BOX 73790 PUYALLUP, WA 98373

KURT WILSON / EVAN MANN

<u>Project No.</u>


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Issue Set & Date:

PRELIMINARY PLAT

9/01/2023



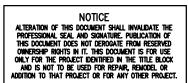

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Revisions:

Sheet Title:

COVER SHEET

<u>Drawn by:</u>

Checked by:

Sheet No.

APPLICATION #999???

1 of 11 Sheets

IMPORTED FILL MATERIAL SHALL NOT CONTAIN PETROLEUM PRODUCTS, OR

SUBSTANCES WHICH ARE HAZARDOUS, DANGEROUS, TOXIC, OR WHICH

OTHERWISE VIOLATE ANY STATE, FEDERAL, OR LOCAL LAW, ORDINANCE,

THE LOCATIONS OF EXISTING UNDERGROUND UTILITIES ARE APPROXIMATE

REPRESENTATIVE. THE CONTRACTOR SHALL DETERMINE THE EXACT

LOCATION OF ALL EXISTING UTILITIES BEFORE COMMENCING WORK AND

HAPPEN DUE TO THE CONTRACTOR'S FAILURE TO LOCATE EXACTLY AND

PRESERVE ANY AND ALL UNDERGROUND UTILITIES. AHBL ASSUMES NO

LIABILITY FOR THE LOCATION OF UNDERGROUND UTILITIES.

AGREES TO BE FULLY RESPONSIBLE FOR ANY AND ALL DAMAGES THAT

ONLY AND HAVE NOT BEEN INDEPENDENTLY VERIFIED BY THE OWNER OR ITS

FILL SPECIFICATION


UTILITY NOTE


CODE, REGULATION, RULE, ORDER, OR STANDARD.


Know what's below. Call before you dig.

COUNTRY MEADOWS ESTATES PHASE 1 PRELIMINARY PLAT

A PORTION OF THE NE 1/4 OF THE SE 1/4 OF SEC. 30, TWN. 17 N., RGE. 02 E., W.M., CITY OF YELM, THURSTON COUNTY, WASHINGTON.

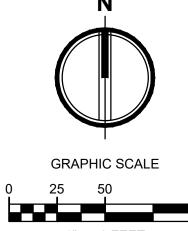

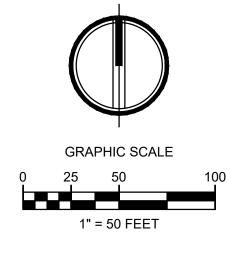

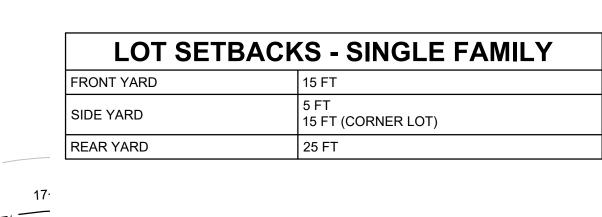

TRACT IDENTIFICATION			
ITEM	SQUARE FEET	ACRES	
TRACT 'A' - OPEN SPACE	2,124	0.05	
TRACT 'B' - OPEN SPACE	922	0.02	
TRACT 'C' - OPEN SPACE	20,466	0.47	
TRACT 'D' - OPEN SPACE	2,002	0.05	
TRACT 'E' - OPEN SPACE	1,000	0.02	
TRACT 'F' - FUTURE ROW DEDICATION	29,880	0.68	

STATISTICAL BREAKDOWN

ITEM	DESCRIPTION C	OR AREA
I I EIVI	SQUARE FEET	ACRES
SITE AREA	428,902	9.84
CRITICAL AREAS	0	0.00
PROPOSED ONSITE ROAD ROW	84,856	1.95
OPEN SPACE (5% MINIMUM = 21,445 SF)	26,514	0.60
EXISTING & PROPOSED ZONING:	R-6, RESIDENTI	AL
MAXIMUM DENSITY (6 DU/ACRE)	59.04 (USE 59)	
TOTAL NO. OF LOTS PROPOSED (SINGLE FAMILY)	59	
LARGEST LOT AREA (LOT 48)	6,923	0.16
SMALLEST LOT AREA (MULTIPLE LOTS)	4,000	0.11
AVERAGE LOT AREA	4,885	0.11
TOTAL IMPERVIOUS SURFACE (54.97%)	235,772	5.41
ROAD	58,772	1.35
ROOF AREA (2,500 SF x 59 UNITS)	147,500	3.39
DRIVEWAYS (500 SF x 59 UNITS)	29,500	0.68



2215 North 30th Street, Suite 300 Tacoma, WA 98403

Project Title: **COUNTRY**

MEADOWS ESTATES PHASE 1 PRELIMINARY PLAT

COPPER RIDGE LLC

P.O.BOX 73790 PUYALLUP, WA 98373

KURT WILSON / EVAN MANN

2230251.10


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Issue Set & Date:

PRELIMINARY PLAT

9/01/2023



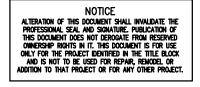

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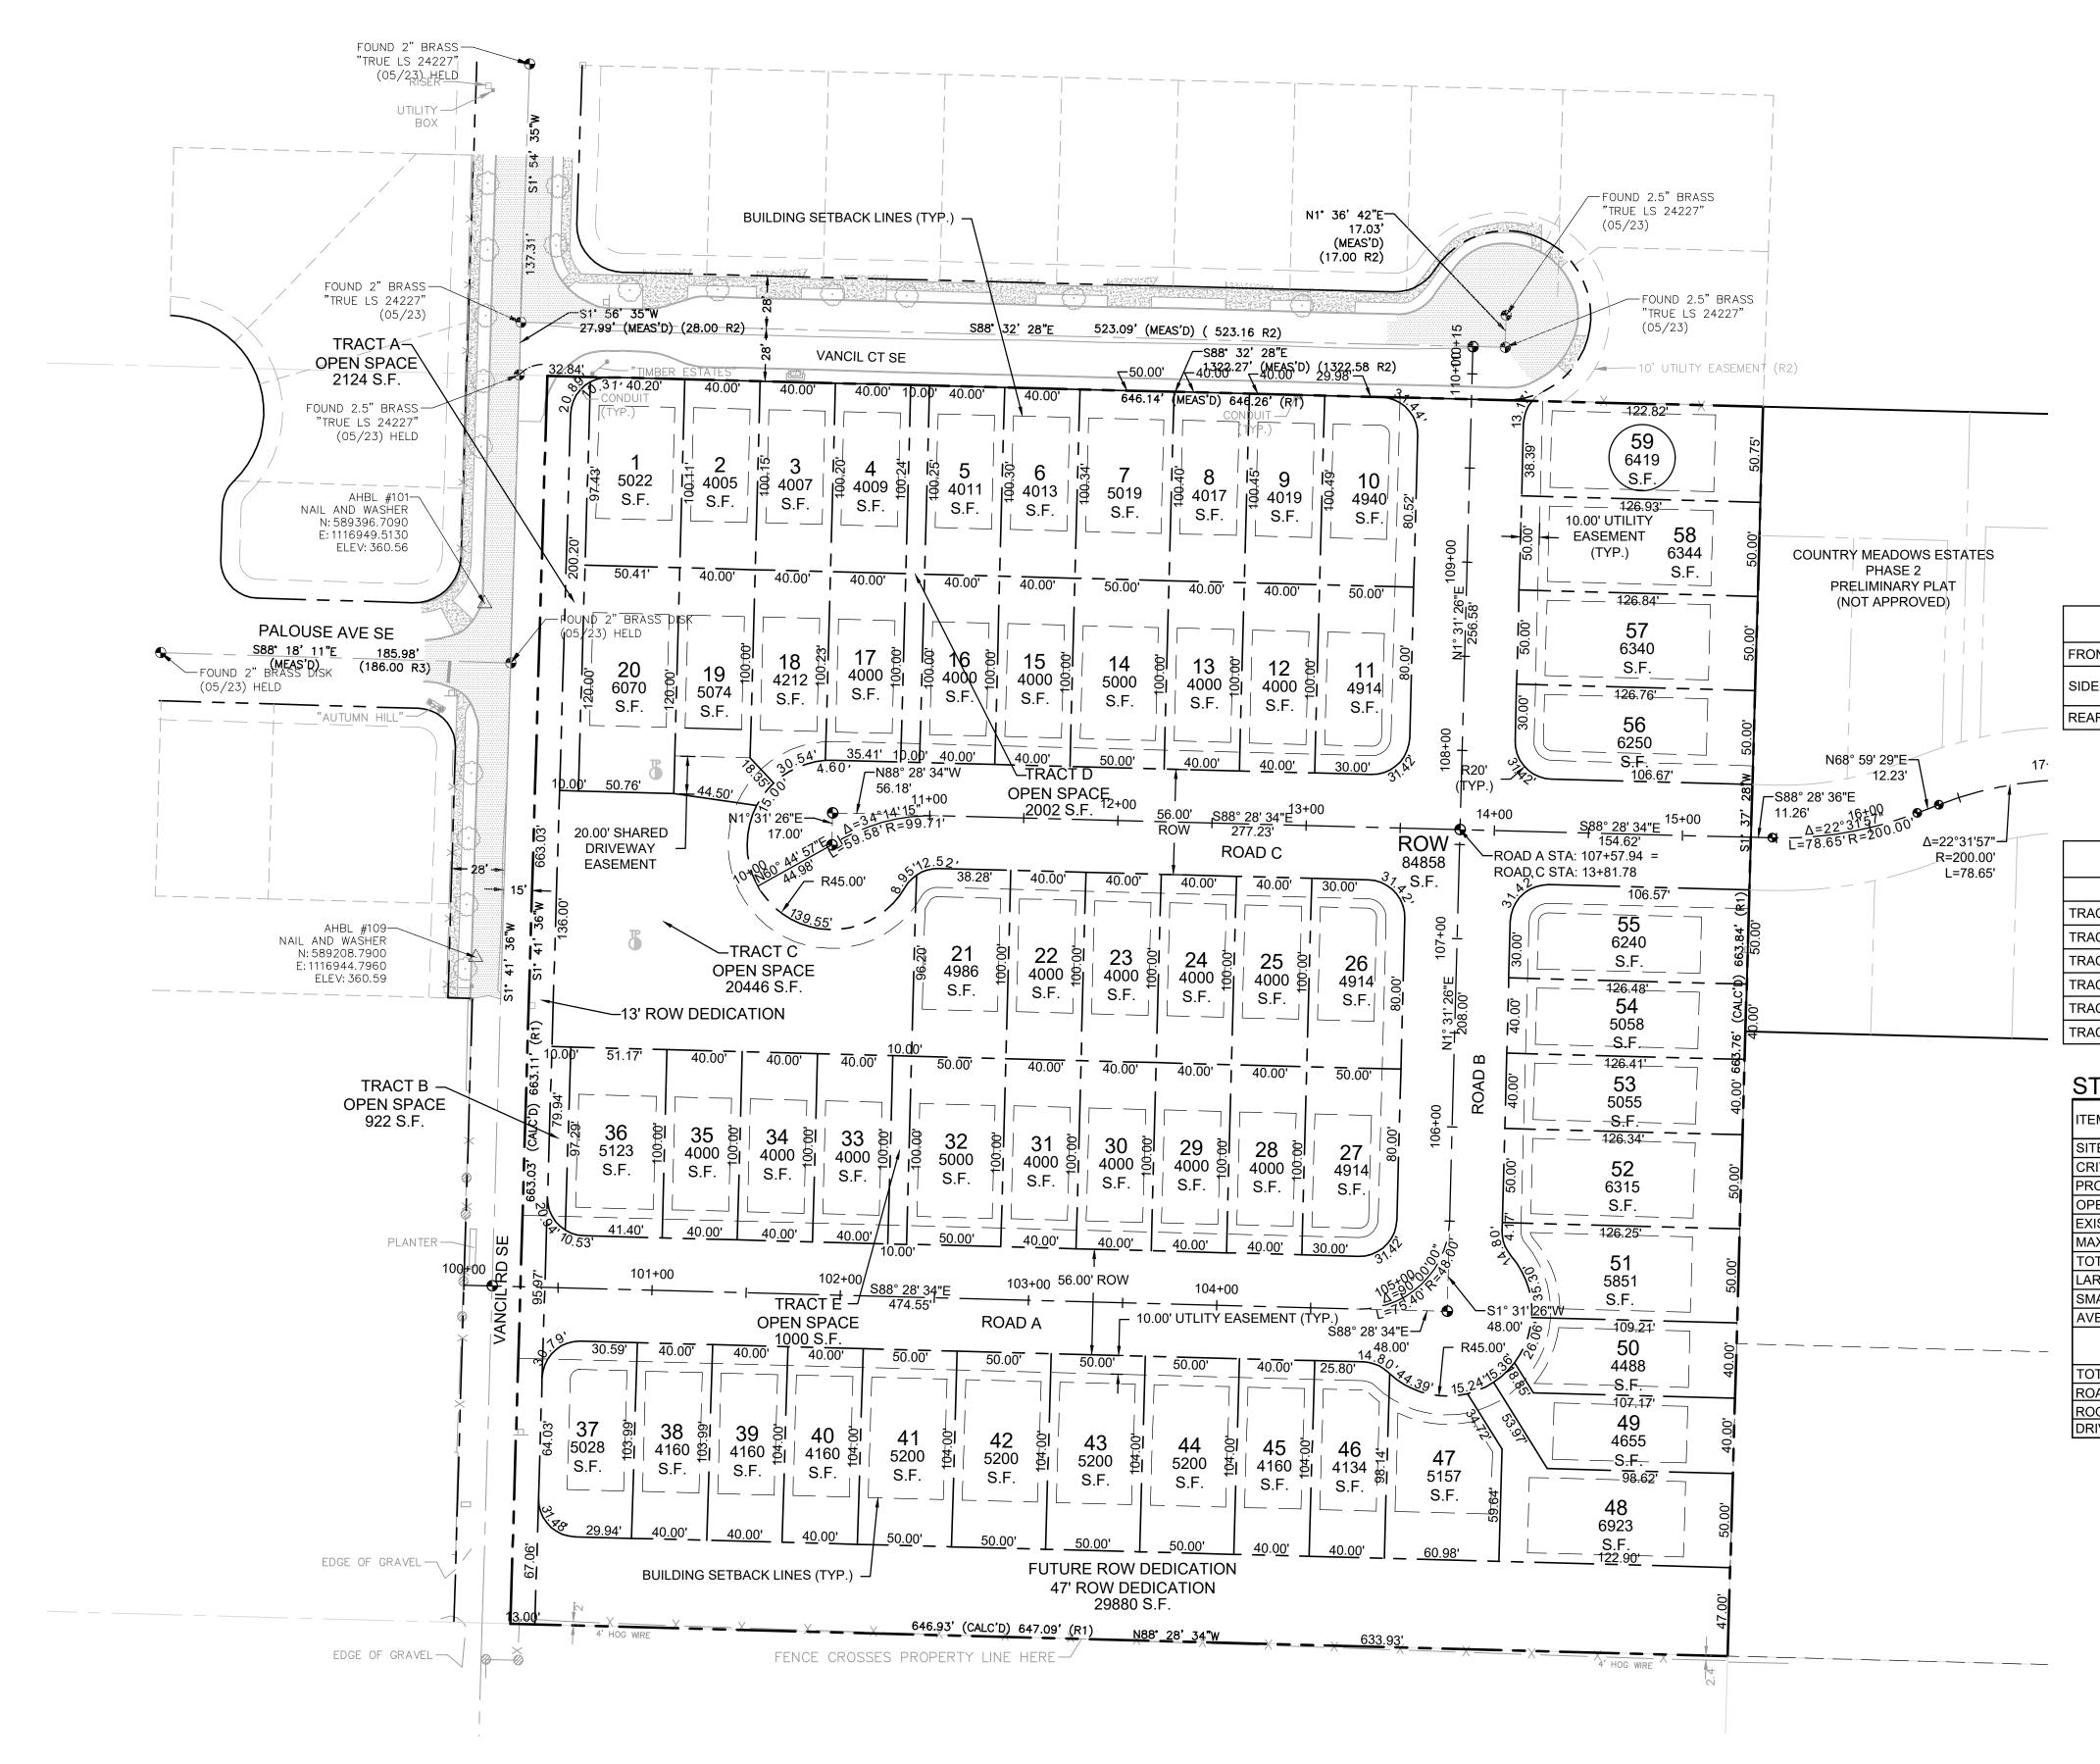
PLAT MAP

Designed by: Drawn by:

Checked by:

<u>Sheet No.</u>

3 of 11 Sheets





"TRUE LS 24227" (05/23) HELD

FOUND 2" BRASS-"TRUE LS 24227"

FOUND 2.5" BRASS

AHBL #101— NAIL AND WASHER

N: 589396.7090

E: 1116949.5130 ELEV: 360.56

"AUTUMN HILL

N: 589208.7900 E: 1116944.7960

ELEV: 360.59

PLANTER-

"TRUE LS 24227" (05/23) HELD

BOX

SEWER BOX-

VANCIL CT SE

27.99' (MEAS'D) (28.00 R2)

TRACT C

COUNTRY MEADOWS ESTATES PHASE 1 PRELIMINARY PLAT

A PORTION OF THE NE 1/4 OF THE SE 1/4 OF SEC. 30, TWN. 17 N., RGE. 02 E., W.M., CITY OF YELM, THURSTON COUNTY, WASHINGTON.

(MEAS'D) (17.00 R2)

S88' 32' 28"E 1322.27' (MEAS'D) (1322.58 R2)

25

29

FUTURE ROW DEDICATION

646.93' (CALC'D) 647.09' (R1) N88' 28' 34"W

FENCE CROSSES PROPERTY LINE HERE-

FOUND 2.5" BRASS
"TRUE LS 24227"


"TRUE LS 24227"


COUNTRY MEADOWS ESTATES

PRELIMINARY PLAT

(NOT APPROVED)

(05/23)

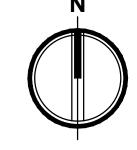

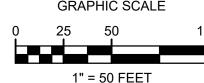

	PLANT SCHEDULE	
TREE	BOTANICAL / COMMON NAME	SIZE
	KOUSA DOGWOOD	2" CAL. MIN. 1 1/2 GAL. MIN
	PACIFIC SUNSET MAPLE	2" CAL. MIN.
X	DECIDUOUS TREE - TBD - WITH FINAL LANDSCAPE PLAN	6' HEIGHT

TOTAL EXISTING TREES: 0

TOTAL REPLACEMENT TREES NEEDED:

TOTAL REMOVED TREES: 0

TOTAL RETAINED TREES: 0

A PORTION OF THE REPLACEMENT TREES REQUIRED FOR COUNTRY MEADOW ESTATES PHASE 2 WILL BE PLANTED WITHIN COUNTRY MEADOW ESTATES PHASE 1.

STREET TREES PHASE 1:	90
STREET TREES PHASE 2:	40
ADDITIONAL TREES PHASE 1:	26
ADDITIONAL TREES PHASE 2:	48
TOTAL REPLACEMENT TREES:	204

NOTI

- THIS IS A PRELIMINARY LANDSCAPE DESIGN. SPECIES AND LOCATION OF PROPOSED TREES IS SUBJECT TO CHANGE.
- 2. FINAL LANDSCAPE, TREE RETENTION AND VEGETATION PLAN TO BE PREPARED BY A LICENSED LANDSCAPE ARCHITECT AND SUBMITTED TO THE CITY OF YELM FOR APPROVAL PRIOR TO THE ISSUANCE OF SITE DEVELOPMENT PERMIT.
- 3. PERIMETER LANDSCAPE TO BE PLANTED PER YELM CODE.
- STREET TREES SPACED 35' O.C. PLACEMENT ADJUSTED FOR DRIVEWAYS, UTILITIES, AND STREET LIGHTS, SHRUBS AND GROUNDCOVER PER YELM MUNICIPAL CODE 18.55.020 (C).
- 5. IN ACCORDANCE WITH YMC18.55.050, LANDSCAPE AREAS SHALL HAVE IRRIGATION SYSTEM OR BE WITHIN 75 FEET OF A HOSE SPIGOT. IRRIGATION SYSTEM SHALL BE DESIGN/BUILD. CONTRACTOR TO COORDINATE.

STREETSCAPE

- 1. PURPOSE: STREETSCAPE LANDSCAPING IS INTENDED TO PROVIDE VISUAL RELIEF WHERE CLEAR SIGHT IS DESIRED. THIS LANDSCAPING IS UTILIZED ALONG PEDESTRIAN CORRIDORS AND WALKS FOR SEPARATION OF PEDSTRIANS FROM STREET AND PARKING AREAS WHILE PROVIDING AN ATTRACTIVE SETTLING AND OVERSTORY CANOPY.
- WHEN REQUIRED: STREETSCAPE LANDSCAPING IS REQUIRED AS PART OF STREET FRONTAGE IMPROVEMENTS.
- 3 DESCRIPTIO
- a. THIS TYPE OF LANDSCAPING CONSISTS OF STREET TREES FOR A LARGE OVERSTORY CANOPY ALONG STREETS AND PEDESTRIAN CORRIDORS AND APPROVED VEGETATION FOR GROUNDCOVER.
- b. STREET TREES SHALL BE CHOSEN FROM A STREET TREE LIST AS ADOPTED BY THE YELM TREE ADVISORY BOARD. DECORATIVE PROTECTION MAY BE PLACED AROUND THE TREES.
- c. GROUNDCOVER SHALL BE A MINIMUM FOUR-INCH POTS SPACED 18 TO 20 INCHES ON CENTER OR ONE-GALLON POTS AT 20 INCHES ON CENTER. LOW GROWTH SHRUBS SHALL BE ONE-GALLON POTS AT THREE FEET ON CENTER. SHRUBS SHALL BE 18 TO 24 INCHES IN HEIGHT AT FIVE FEET ON CENTER OR THREE-GALLON POT AT FIVE FEET ON CENTER.
- d. EARTHEN BERMS WITH GRASS OR OTHER VEGETATIVE GROUNDCOVER AND OTHER DESIGN FEATURES MAY BE WORKED INTO LANDSCAPING PROVIDED THE RESULTANT EFFECT OF PROVIDING A PEDESTRIAN-FRIENDLY ENVIRONMENT AND VISUAL RELIEF WHERE CLEAR SITE IS REQUIRED CAN BE ACHIEVED.
- e. THE MINIMUM WIDTH FOR STREETSCAPE LANDSCAPING SHALL BE SIX FEET TO PROVIDE ROOTING AREA FOR LARGE STREET TREES AND TO PROVIDE ADEQUATE STREETSCAPE. A FOUR-FOOT WIDTH MAY BE USED THROUGH PARKING AREA PEDESTRIAN WALKS WHERE ACCENT TREES ARE USED AND LESS WIDTH IS REQUIRED.
- f. PLANTING THEME SHALL BE A RATIO OF THREE STREET TREES TO ONE ACCENT TREE.
- g. TREES SHALL BE SPACED 35 FEET ON CENTER STARTING 15 FEET FROM THE PROPERTY LINE. TREE SPACING MAY BE ADJUSTED TO ALLOW UNOBSTRUCTED SIGHT DISTANCE ON EITHER SIDE OF A DRIVEWAY AND AT STREET INTERSECTIONS. TREE SPACING MAY ALSO BE ADJUSTED WHEN IN CONFLICT WITH LUMINAIRE POLES.

APPLICATION #999???



2215 North 30th Street, Suite 300 Tacoma, WA 984

253.383.2422 TEL 253.383.2572 FAX www.ahbl.com WEB

COUNTRY
MEADOWS ESTATES
PHASE 1
PRELIMINARY PLAT

COPPER RIDGE LLC

P.O.BOX 73790 PUYALLUP, WA 98373

KURT WILSON / EVAN MANN

2230251.10

<u>Project No.</u>


Project Title:

Issue Set & Date:

PRELIMINARY PLAT

9/01/2023



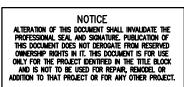

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Revisions:

CONCEPTUAL
LANDSCAPE PLAN

Designed by: Drawn by: Checked by: MW/SK

Sheet No.

C6.111 of 11 Sheets

EDGE OF GRAVEL

EDGE OF GRAVEL



October 31, 2023

City of Yelm Department of Community Development 901 Rhoton Road Yelm, WA 98597

Project: Country Meadows Estates Phase 1, AHBL No. 2230251.10

Subject: Project Narrative

Dear City of Yelm Staff:

To assist in your review, we have prepared the following project narrative for Country Meadows Estates Phase 1, a proposed 59-lot residential plat in the city of Yelm.

NAME OF PROJECT: Country Meadows Estates Phase 1

APPLICANT

Scott T. Kaul, PE, Senior Project Manager AHBL, Inc. 2215 North 30th Street, Suite 300 Tacoma, WA 98403 skaul@ahbl.com

DEVELOPER

Evan Mann Copper Ridge, LLC PO Box 73790 Puyallup, WA 98373 evan@soundbuilthomes.com

PROJECT DESCRIPTION

The proposed Country Meadows Estates Phase 1 is bounded by Vancil Road SE to the west, Vancil Court SE to the north, Future ROW to the south, and private property to the east within the city of Yelm, Thurston County. The project site is approximately 9.84 acres on Parcel 22730410300. The site is vacant land and was recently annexed into the city of Yelm and is zoned R-6, Moderate-Density residential. The proposal will include 59 single-family, detached residences in Phase 1. The development will include infrastructure improvements, including stormwater management facilities, utilities, sewer, recreational open space, and public roads.

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Civil Engineers

Structural Engineers

Landscape Architects

Community Planners

Land Surveyors

Neighbors

TACOMA

2215 North 30th Street
Suite 300
Tacoma, WA 98403-3350
253.383.2422 TEL

www.ahbl.com

City of Yelm Department of Community Development October 31, 2023 2230251.10 Page 2 of 2



Country Meadows Estates Phase 1 has a connection to sewer and water out to Vancil Road SE. The sewer and water are looped through the plat from Vancil Road SE south along Road B and then west back out to Vancil Road SE. Water is stubbed to the future development Phase 2 as a future connection.

Stormwater runoff from this plat is managed independently of future phases of development. The plat will include its own underground infiltration and treatment system, specifically sized to manage stormwater from the public right-of-way and open space tracts. Stormwater runoff from the individual lots will be collected and infiltrated on lot in individual drywells or infiltration systems. Final design will be in accordance with the most recent Washington State Department of Ecology Stormwater Management Manual for Western Washington (SWMMWW).

CONSTRUCTION SCHEDULE

Construction of Phase 1 is expected to begin in the fall of 2024. The second phase of development, which is being submitted under separate application, is anticipated to begin construction in the spring of 2025. If the Phase 2 development is delayed, Phase 1 will be completed with connectivity to this offsite parcel to allow expansion of the residential neighborhood in the future, per City of Yelm standards. The developer is aware that the hearing examiner's approval of the Preliminary Plat is good for five years and will require a public hearing, decision of approval, and construction plan approvals.

Thank you for your thorough review of the information we have provided. If you have any questions, please call me at (253) 383-2422.

Sincerely,

Scott T. Kaul, PE, LEED AP Senior Project Manager

SG/STK/lsk



Clayton Wiebe

From: Sharon Brown-Kabanuck
 brownkaban92@hotmail.com>

Sent: Friday, December 1, 2023 12:01 AM

To: Clayton Wiebe

Cc: Joann Brown; Garry Brown; Lucy Brown

Subject: [External]Corrected comments on Country Meadows Estates Phase 1 and 2

Clayton Wiebe Assistant Planner Planning and Building Department Yelm, Washington 98597 Exhibit B

Here are my comments for the hearing which I have submitted before the 5:00 PM 12/1/2023 deadline. Please acknowledge receipt by return email.

I am part owner of <u>10815 Morris RD SE</u> so both of the Country Meadows Phase 1 and 2 developments are adjacent to my property.

This land has been in my family for over 100 years and my great grandfather Leopold Hammerschimdt operated Hammerschmidt and Sons Sawmill on Hammerschmith hill in Yelm about 1915 to 1931.

My Comments for the record:

I have reviewed the traffic study which was done in support of this project. I strongly object to the findings of that report. While I am not currently living in the home at 10823, I have lived there at various times over the past 20 years and I currently have a renter living there.

Issue 1: The traffic study only addresses what someone considers peak hours of traffic in the morning and evening primarily on Highway 507 and Vancil Road and the nearby businesses. It doesn't consider weekends or other higher traffic times. This first project adds 59 new homes to the area. The Traffic Impact Assessment calculates peak traffic from 4:00 to 5:54 PM (P 24-31) which I believe results in an undervalue assessment favorable to the developer and NOT the city. The study projects only 46 AM peak hour trips and 61 PM peak hour trips on Vancil Road alone. Given the most households have multiple vehicles, that appears to be a severe underestimate of potential traffic.

Issue 2: The Traffic Impact Assessment for Country Meadows Estates Phase 2 which communicates to Morris Road was also done looking at traffic <u>from 4-6 PM</u>, with no indication of traffic patterns during school hours. The traffic study for phase 2 suggests that 35 homes may access the east west corridor created by the phase 1 plat. The traffic study also concludes that for the 29 homes in Phase 2, there would only be 31 PM peak hour trips (again favorable to the developer and NOT the city for revenue generation). Considering that most people have multiple vehicles, this estimate appears to be a complete fabrication.

Issue 3: Of particular concern is the location of Prairie Elementary School with their 442 students located at Morris Road and 110th Avenue. While the school is not located within city limits, most parents appear to drive their children to and from school rather than utilizing school buses. Traffic becomes VERY congested during the morning and afternoon drop off and pickup times to the point where it is impossible for residents of Morris Road to leave their property. Compounding the problem are late start days and early dismissal days.

Issue 4: There appear to be no current plans for widening Morris Road. I know that Thurston County had a plan for improvements to the road several years ago but those plans were dropped due to budgetary constraints. With

the addition of the Alexander property and the proposed Country Estates parcels to the city limits, my question is who will have responsibility for Morris Road? Will it become a city street or remain a county road? There are NO shoulders on that road and no one in the area allows their children to walk along that road. Even adults do not walk or bicycle along the road. The additional houses, along with the potential for additional students attending Prairie Elementary, mean more traffic than before.

Issue 5: While this isn't the city's responsibility, there is an additional concern about signage for the school. There are NO school zone signs in the vicinity of the school except for one at the top of the hill. There is nothing near the school on either Morris Road or 110th Avenue.

Issue 6: I suggest that the City Council give additional consideration to the Country Meadows Estates phases 1 and 2 proposals and I remind them that they have the power to improve movement of the day to day traffic and particularly provision of emergency access for the citizens of the city.

Issue 7: I've noticed on the Phase 1 plat map the location of lots 19, 20, 47, 48, 49, and 50 and the location on the Phase 2 plat map of lots 6, 7, 13, and 14. These 10 lots appear to have very narrow driveway access. It appears that access for emergency vehicles would be very tight. It seems that emergency access should also be a consideration.

In conclusion, from reading the Nisqually Valley News and Yelm area social media, local traffic in Yelm is one of the top issues for residents of the greater Yelm area. The city council owes it to their constituents to reexamine the proposals paying particular attention to traffic impacts and availability of emergency access.

Thank you for the opportunity to comment on these proposed subdivisions. I look forward to hearing about the public hearing on the issue. I can be reached at 253-831-2915 or at brownkaban92@hotmail.com.

Sharon BrownKabanuck Sent from my iPad

Clayton Wiebe

From: Bill's Towing <office@billstowing.net>
Sent: Thursday, November 16, 2023 10:44 AM

To: Clayton Wiebe

Subject: [External]**Warning Unsafe**Country Meadows Estates Phase 1 and 2

Hello,

I am writing today to express my concern and opposition to the Country Meadows Estates Project. I do not think the plan should be approved, at least in its present form. These are my areas of concern:

Density

The proposed project is far denser than the surrounding neighborhoods. It proposes 10 houses in the space of 7 houses on neighboring streets. Housing this dense not only diminishes neighborhood involvement, it also promotes absentee owners which dis-invest in properties letting them deteriorate and deteriorating neighborhoods breed turnover, abandoned vehicles, higher crime, and a loss in property value. On the contrary, less dense housing promotes live-in ownership which leads to more neighborhood involvement, more civic participation, more tax money in city coffers and a healthier city overall.

Traffic

I live at 16229 Birkland St SE, which is right across from a park where the neighborhood kids gather and play. Young kids are crossing Vancil Road at all hours to get to the park. These 78 additional houses will generate, at minimum, 140 additional cars which statistically make 3 trips a day, down Vancil Road which is now a comparably quiet street. Our street is heavily populated by playing children, as well as elderly seniors with an array of disabilities, including a blind man who walks multiple times a day on Vancil Rd. The road is not only somewhat underdeveloped, but it has NO SIDEWALKS for some of the distance. We also have some sight distance issues because of the hill on Vancil Rd, so an increase in traffic, especially speeding traffic on this road is exceptionally dangerous.

Shortcut Traffic

This brings me to another issue. When the Phase 2 road is connected to Morris Road, this will become a shortcut for people avoiding traffic, something we have no shortage of in Yelm. During pickup and drop-off times at Prairie Elementary on Morris Road, Morris Road becomes quite backed up and as a former Yelm police officer, I believe speeding through the new development will be a huge safety concern.

Suggestions

I believe a less dense housing plan that matches the surrounding neighborhoods would be better for our city and safer for our residents. I believe less density would keep the traffic increase at a more reasonable level. Furthermore, I believe that speed abatement devices are an absolute must for safety, and still may not deter speeders and those who seek to make the residential route a shorter or quicker alternative to the main streets.

I hope that you'll consider my comments and disallow the project as it is written.

Thank You,

--

Bill Trull Yelm Locksmith Bill's Towing & Recovery (Trusted Since 1970) 801 Yelm Ave. W Yelm, WA 98597 P 360.458.5963 F 360.458.8473

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Clayton Wiebe

From: Garry Brown <gjbrowndo@gmail.com> **Sent:** Thursday, November 30, 2023 8:31 PM

To: Clayton Wiebe

Subject: [External]Country Meadows Estates Phase 1 and Phase 2

Clayton Wiebe City of Yelm Planning and Building Department 901 NW Rhoton Road Yelm, WA 98597

Dear Mr. Wiebe,

This letter is in response to the proposed project by Country Meadows Estates involving property bordering Vancil Road and Morris Road. My wife, Lucy Patterson Brown, my sister, Joann Brown, and I own the property at 10823 Morris Road. The property was originally owned by my grandparents Ruth and Adolph Hammerschmith and was purchased by my parents, Jim and Dorothy Brown in 1953.

Traffic on Morris Road had increased logarithimically over the years especially since the construction of Prairie Elementary School and the enrollment of 442 students. The addition of 59 homes on Vancil Road and 29 homes between Vancil Road and Morris Road will dramatically increase the Morris Road traffic and raises safety concerns.

It is my opinion that the traffic survey was not conducted at peak hours when school opens and classes are released for the day and could underestimate the potential change in traffic flow by as much as one half. The survey seems to assume that there will only be one car per household when most couples will both be working. Looking at the proposed lots and roads it seems unlikely to me there will be street parking on the road connecting Vancil Road and Morris Road. Morning traffic and after school traffic even now causes congestion from 110th Avenue and the intersection with Bald Hill Road as well as at the intersection with Highway 507, Bald Hill Road, and Creek Road.

The speed limit on Morris Road is or at least was 35 mph when we were growing up however it seems that many drivers are unaware of the speed limit or simply ignore it in both directions.

My questions:

Is there a plan to widen Morris Road to four lanes or even three lanes to allow for a left turn lane to 110th?

Are there plans for sidewalks and bike lanes on Morris Road?

Are there plans for traffic circles at 110th Avenue, the road between Vancil Road and Morris Road, and Morris Road and Bald Hill Road?

Are there still plans for a major bypass road to connect Clark Road, Vancil Road, Morris Road and Bald Hill Road? If so, when might that be constructed?

Our concerns relate to student safety and traffic flow on Morris Road. Your consideration is appreciated.

Sincerely, Lucy Patterson Brown Garry Brown (509) 308-8691

Clayton Wiebe

From: Joann Brown <joann.g.brown@gmail.com>
Sent: Friday, November 24, 2023 4:45 PM

To: Clayton Wiebe; Garry Brown; Lucy Brown; Sharon Brown Kabanuck

Subject: [External]Re: City of Yelm follow-up on future development (Country Meadows Estates

Phase 1 and 2)

Hi Clayton,

Here are my comments for the hearing which I have submitted today 11/24 before 5:00PM.

I am part owner in 10815 Morris RD SE and 10823 Morris RD SE so both of the Country Meadows Phase 1 and 2 developments are attached to my properties.

This land has been in my family for over 100 years and my great grandfather Leopold Hammerschimdt operated Hammerschmidt and Sons Sawmill on Hammerschmith hill in Yelm about 1915.

If you google "Hammersmith Hill" the USGS map will find the latitude and longitude, along with the elevation of the hill which is above these Morris Road properties.

My Comments for the record:

1. I have a strenuous objection to the preliminary plat map for phase one of Country Meadows Estates that dumps a cul-de-sac in the middle of the plat and does not allow for direct communication from Phase 1 and Phase 2 which will communicate to Morris Road. As I discussed in the previous city council meeting, my concern is the traffic on Morris Road to Prairie elementary school which backs up traffic on Morris Road when school starts and ends, which is NOT covered in the Traffic Impact assessment for phase 1 or phase 2.

Interestingly, the Traffic Impact Assessment calculates peak traffic from 4:00 to 5:54 PM (P 24-31) which I believe results in an undervalue assessment favorable to the developer and NOT the city which presumes only 46 AM peak hour trips and 61PM peak hour trips for 59 family homes based on Vancil road observations only (see page 22 of the Phase 1 Traffic Assessment). Additionally, as I previously voiced to the City Council, the cul-de-sac placement forces 16 families on the plots on the cul-de-sac to take an unnecessary trip through the plat to get out to Vancil Road, which I believe is an impediment to emergency vehicle access to these homes. Furthermore, it restricts the foot traffic from these homes to get to Vancil Road to access gas and groceries,

- 2. The Traffic Impact Assessment for Country Meadows Estates Phase 2 which communicates to Morris Road was also done looking at traffic from 4-6 PM, with no indication of traffic patterns during school hours. I would imagine all of the 29 homes planned on this 5 acre plat will most likely access Morris Road and the Bald Hill/5 corners intersections because of the nature of the cul-de-sac creation in the Phase 1 plat as I discussed above. The traffic study for phase 2 suggests that 35 homes may access the east west corridor created by the phase 1 plat. The traffic study also concludes that for the 29 homes in Phase 2, there would only be 31 PM peak hour trips (again favorable to the developer and NOT the city for revenue generation) (see page 25 of the Phase 2 Traffic Assessment).
- 3. Country Meadows Estates appears to be developed by Copper Ridge LLC, which to the best of my knowledge is a multistate developer with considerable assets which I am sure they want to devote to maximizing their sales, so their planning priority is maximizing space to increase the number of homes to generate profits for themselves. I would caution the City Council to give pause to this proposal and remind them that they have the power to improve movement of the day to day traffic and provision of emergency

access for the citizens of the city. The council also has the power to ask for the cul-de-sac on Phase 1 to be removed and appropriate revisions to be submitted to the city.

I appreciate the opportunity to comment on this proposal, despite the fact that I continue not to receive written notice at my current address of these impending activities which affect my property in Yelm.

Joann Brown 282 Beachview Avenue, #28 Pacifica, California 94044

On Tue, Nov 21, 2023 at 10:21 AM Clayton Wiebe < Clayton W@yelmwa.gov > wrote:

Good morning Joann,

This email is a follow-up to our conversation today regarding the proposed development between Morris Rd and Vancil Rd. I have attached two site plans, as this development comprises two projects (Country Meadows Estates Phase 1 and Country Meadows Estates Phase 2).

I also included the 2 traffic studies that were prepared regarding these proposals. If you'd like to reply with a comment, I can add it to our public record and it will be included in our staff report to the Hearing Examiner in advance of the required public hearing(s).

Warm regards,

Clayton Wiebe

Assistant Planner

City of Yelm, WA

Tel: 360.458.8496

Hours: Tue-Fri 6:30 AM – 5:00 PM

www.yelmwa.gov



Clayton Wiebe

From: Lori Graves <lorigraves15@gmail.com>
Sent: Sunday, November 26, 2023 8:35 PM

To: Clayton Wiebe

Subject: [External]Country Meadows Estate Phase 1

Good Morning Mr. Wiebe,

I am writing to you in regard to the above poroposed housing development. I live in the Autumn Hill development. The proposed development is going to cause many issues for those of us already established. We will have issues with mice and rats not to mention other animals living in that area. The traffic will be unmanageable bringing additional traffic to a small area. There are already so many housing areas proposed and not enough people able to afford home ownership. This will add unnecessary stress on an already stressed area.

Please reconsider this housing area as being beneficial to our town.

Thank you,

Lori Graves 10728 Tucannon Ct SE, Yelm, WA 98597 912 433 2043



NISQUALLY INDIAN TRIBE Tribal Historic Preservation Office

4820 She-Nah-Num Drive S.E. Olympia, Washington 98513 360.456.5221 (main) 877.768.8886 (toll free) www.nisqually-nsn.gov

November 27, 2023

To: Clayton Wiebe, Assistant Planner

City of Yelm 106 2nd St SE Yelm, WA 98597

Re: 2023.0163

The Nisqually Indian Tribe's THPO has reviewed the notice of application and supplemental materials that you provided for the above-named project and has no specific comments or concerns at this time. Please keep us informed if there are any Inadvertent Discoveries of Archaeological Resources/Human Burials.

Although the Nisqually Indian Tribe doesn't have any specific concerns, we respect the traditional cultural knowledge of affected tribes and support their opinions on this matter as well.

Sincerely,

Brad Beach, THPO
Nisqually Indian Tribe
360-528-1084
360-456-5221 ext 1277
beach.brad@nisqually-nsn.gov

cc: Annette Bullchild, Director, Nisqually Indian Tribe

Agencies for SEPA/NOA

Agency named	Contact	Email address
Yelm School District	Chris Woods,	Christopher_Woods@ycs.wednet.edu
	Superintendent	
Assistant Fire Marshall	Matt Russell	firemarshal@sethurstonfire.org
WSDOT, Olympic	Andrew Larson	larsona@wsdot.wa.gov
Region		
Dept of Archaeology	Michelle Thompson	SEPA@dahp.wa.gov (primary contact)
and Historic	Stephanie Jolivette	Stephanie.jolivette@dahp.wa.gov (backup contact)
Preservation		
WA Dept of Ecology	SEPA Register	https://secureaccess.wa.gov/myAccess/saw/select.do
Squaxin Island Tribe	Shaun Dinubilo*	sdinubilo@squaxin.us
Nisqually Tribe	Brad Beach*	beach.brad@nisqually-nsn.gov
Washington		
Department of Fish &	Jennifer Eberly	R6SSplanning@dfw.wa.gov
Wildlife		
Comcast	Jane Kang*	eunji_kang@comcast.com
Intercity Transit	Pat Messmer	pmessmer@intercitytransit.com
	Amanda Collins	acollins@intercitytransit.com
School Bus	Gregory Wilson(not	gregory wilson@ycs.wednet.edu
	current)	Need new email address, this one came back
		undeliverable
Police	Rob Carlson	robc@yelmwa.gov

^{*}requests site plans be sent along with the NOA





ENVIRONMENTAL CHECKLIST

Purpose of checklist:

The State Environmental Policy Act (SEPA), chapter <u>43.21C</u> RCW, requires all governmental agencies to consider the environmental impacts of a proposal before making decisions. An environmental impact statement (EIS) must be prepared for all proposals with probable significant adverse impacts on the quality of the environment. The purpose of this checklist is to provide information to help you and the agency identify impacts from your proposal (and to reduce or avoid impacts from the proposal, if it can be done) and to help the agency decide whether an EIS is required.

Instructions for applicants:

This environmental checklist asks you to describe some basic information about your proposal. Governmental agencies use this checklist to determine whether the environmental impacts of your proposal are significant, requiring preparation of an EIS. Answer the questions briefly, with the most precise information known, or give the best description you can.

You must answer each question accurately and carefully, to the best of your knowledge. In most cases, you should be able to answer the questions from your own observations or project plans without the need to hire experts. If you really do not know the answer, or if a question does not apply to your proposal, write "do not know" or "does not apply." Complete answers to the questions now may avoid unnecessary delays later.

Some questions ask about governmental regulations, such as zoning, shoreline, and landmark designations. Answer these questions if you can. If you have problems, the governmental agencies can assist you.

The checklist questions apply to all parts of your proposal, even if you plan to do them over a period of time or on different parcels of land. Attach any additional information that will help describe your proposal or its environmental effects. The agency to which you submit this checklist may ask you to explain your answers or provide additional information reasonably related to determining if there may be significant adverse impact.

Use of checklist for nonproject proposals:

For nonproject proposals complete this checklist and the supplemental sheet for nonproject actions (Part D). The lead agency may exclude any question for the environmental elements (Part B) which they determine do not contribute meaningfully to the analysis of the proposal.

For nonproject actions, the references in the checklist to the words "project," "applicant," and "property or site" should be read as "proposal," "proposer," and "affected geographic area," respectively.

A. Background [Help]

1. Name of proposed project, if applicable:

Country Meadow Estates Phase 1

2. Name of applicant:

AHBL

3. Address and phone number of applicant and contact person:

Sheri Greene, AHBL (253) 383-2422 2215 N. 30th Street #300 Tacoma. WA 98403

4. Date checklist prepared:

August 22, 2023

5. Agency requesting checklist:

City of Yelm

6. Proposed timing or schedule (including phasing, if applicable):

Construction will commence upon issuance of site development permit. It is anticipated the site development permit will be issued in Winter 2023/Spring 2024.

7. Do you have any plans for future additions, expansion, or further activity related to or connected with this proposal? If yes, explain.

Country Meadow Estates Phase 2.

8. List any environmental information you know about that has been prepared, or will be prepared, directly related to this proposal.

SEPA Checklist, Mazama Pocket Gopher Study, Geotechnical Report, Traffic Impact Analysis

9. Do you know whether applications are pending for governmental approvals of other proposals directly affecting the property covered by your proposal? If yes, explain.

10. List any government approvals or permits that will be needed for your proposal, if known.

SEPA Determination, Preliminary Plat Approval, Site Development Permit, Building Permits and NPDES Permit

11. Give brief, complete description of your proposal, including the proposed uses and the size of the project and site. There are several questions later in this checklist that ask you to describe certain aspects of your proposal. You do not need to repeat those answers on this page. (Lead agencies may modify this form to include additional specific information on project description.)

Project proposes construction of a 59-lot residential subdivision with associated roadway. Services will include city water and sewer, and private drainage routed to onsite infiltration facilities.

12. Location of the proposal. Give sufficient information for a person to understand the precise location of your proposed project, including a street address, if any, and section, township, and range, if known. If a proposal would occur over a range of area, provide the range or boundaries of the site(s). Provide a legal description, site plan, vicinity map, and topographic map, if reasonably available. While you should submit any plans required by the agency, you are not required to duplicate maps or detailed plans submitted with any permit applications related to this checklist.

The project site is located off Vancil Road SE, Parcel 22730410300 in Yelm, Washington.

B. ENVIRONMENTAL ELEMENTS [Help]

1. Earth

- a. General description of the site (circle one) Flat, rolling, hilly, steep slopes, mountainous, other.....
- b. What is the steepest slope on the site (approximate percent slope)? The steepest slope is 10% in the center of the site.
- c. What general types of soils are found on the site (for example, clay, sand, gravel, peat, muck)? If you know the classification of agricultural soils, specify them and note any agricultural land of long-term commercial significance and whether the proposal results in removing any of these soils.

According to the Geotechnical Report prepared by Earth Solutions NW dated June 14, 2023, the soils are predominately Spanaway gravelly sandy loam.

d. Are there surface indications or history of unstable soils in the immediate vicinity? If so, describe.

None to our knowledge.

- e. Describe the purpose, type, total area, and approximate quantities and total affected area of any filling, excavation, and grading proposed. Indicate source of fill.
 - The project is in preliminary design but it is anticipated that approximately 7,700 cy of cut and 5,700 cy of fill, for a net export of 2,000 cy will be needed.
- f. Could erosion occur as a result of clearing, construction, or use? If so, generally describe.
 - Minimal erosion could occur during project construction. All applicable BMPs will be followed to prevent or minimize such impacts.
- g. About what percent of the site will be covered with impervious surfaces after project construction (for example, asphalt or buildings)?

 Approximately 54.97% of the site will be covered by impervious surfaces from the construction of the roadways and driveways (500 SF x 59 units). Additional impervious surfaces will be added at the time of home construction.
- h. Proposed measures to reduce or control erosion, or other impacts to the earth, if any: Proposed measures include the use of BMPs to minimize the risk of erosion during construction. A drainage plan will incorporate designs that convey and infiltrate stormwater away from the disturbed areas as much as possible.
- 2. Air [Help]
- a. What types of emissions to the air would result from the proposal during construction, operation, and maintenance when the project is completed? If any, generally describe and give approximate quantities if known. Construction will result in a temporary increase in air pollution, including emissions from equipment and dust from construction activities. Dust controls will include watering soils to prevent blowing of dust. Construction vehicles will be turned off when not in use to help control emissions. Construction activities and equipment will follow the appropriate regulations for controlling emissions to the air. Post-construction emissions would include emissions from vehicle trips associated with the development.
- b. Are there any off-site sources of emissions or odor that may affect your proposal? If so, generally describe.

None to our knowledge.

- c. Proposed measures to reduce or control emissions or other impacts to air, if any:
 Potential BMPs include using water sprays or other non-toxic dust control methods on unpaved roadways, preventing the tracking out of mud onto public streets, covering soil piles when practical, and minimizing work during periods of high winds. Additionally, to minimize air quality and odor issues caused by tailpipe emissions, BMPs will be used. Such BMPs include maintaining engines of construction equipment while also minimizing the idling of construction equipment.
- 3. Water [Help]

a. Surface:

1) Is there any surface water body on or in the immediate vicinity of the site (including year-round and seasonal streams, saltwater, lakes, ponds, wetlands)? If yes, describe type and provide names. If appropriate, state what stream or river it flows into.

None to our knowledge.

2) Will the project require any work over, in, or adjacent to (within 200 feet) the described waters? If yes, please describe and attach available plans.

Not applicable.

3) Estimate the amount of fill and dredge material that would be placed in or removed from surface water or wetlands and indicate the area of the site that would be affected. Indicate the source of fill material.

Not applicable.

4) Will the proposal require surface water withdrawals or diversions? Give general description, purpose, and approximate quantities if known.

No.

5) Does the proposal lie within a 100-year flood plain? If so, note location on the site plan.

No.

6) Does the proposal involve any discharges of waste materials to surface waters? If so, describe the type of waste and anticipated volume of discharge.

No.

b. **Ground**

1) Will groundwater be withdrawn from a well for drinking water or other purposes? If so, give a general description of the well, proposed uses and approximate quantities withdrawn from the well? Will water be discharged to groundwater? Give general description, purpose, and approximate quantities if known.

Water will not be withdrawn; however some stormwater runoff will be directed to stormwater treatment facilities and infiltrated onsite.

2) Describe waste material that will be discharged into the ground from septic tanks or other sources, if any (for example: Domestic sewage; industrial, containing the following chemicals...; agricultural; etc.). Describe the general size of the system, the number of such systems, the number of houses to be served (if applicable), or the number of animals or humans the system(s) are expected to serve.

No waste material will be discharged to the ground. The homes will be served by the City of Yelm STEP collection system and holding tanks will be maintained by the city.

c. Water runoff (including stormwater):

1) Describe the source of runoff (including stormwater) and method of collection and disposal, if any (include quantities, if known). Where will this water flow? Will this water flow into other waters? If so, describe.

Stormwater from the roadways will be collected, treated and conveyed to an onsite infiltration system. The individual homes will have onsite drywells to infiltrate roof runoff.

2) Could waste materials enter ground or surface waters? If so, generally describe.

No waste materials will enter ground or surface waters as a result of this proposal.

3) Does the proposal alter or otherwise affect drainage patterns in the vicinity of the site? If so, describe.

No.

d. Proposed measures to reduce or control surface, ground, runoff water, and drainage pattern impacts, if any:

The project will provide source control of pollutants by providing treatment of stormwater prior to infiltrating onsite. No other measures are proposed.

- 4. Plants [Help]
- a. Check the types of vegetation found on the site:
 - X Deciduous tree: Alder, maple, aspen, other
 - X Evergreen tree: Fir, cedar, pine, other
 - $\frac{X}{-}$ Shrubs
 - X Grass
 - Pasture
 - Crop or grain
 - Orchards, vineyards or other permanent crops.
 - Wet soil plants: Cattail, buttercup, bullrush, skunk cabbage, other
 - Water plants: Water lily, eelgrass, milfoil, other
 - Other types of vegetation
- b. What kind and amount of vegetation will be removed or altered?

Most of the existing vegetation within the project area will be removed.

c. List threatened and endangered species known to be on or near the site.

None to our knowledge.

d. Proposed landscaping, use of native plants, or other measures to preserve or enhance vegetation on the site, if any:

Landscape design and buffer will be in accordance with the City of Yelm Municipal Code. Plans will be submitted to the city with the site development plans for approval.

e. List all noxious weeds and invasive species known to be on or near the site.

Blackberry bushes

5. Animals [Help]

a. List any birds and other animals which have been observed on or near the site or are known to be on or near the site. Examples include:

Birds: Hawk, heron, eagle, congbirds other: $_{
m Crows}$

Mammals: Deer, bear, elk, beaver, other: Rabbits, mice

Fish: Bass, salmon, trout, herring, shellfish, other:

- b. List any threatened and endangered species known to be on or near the site. None known.
- c. Is the site part of a migration route? If so, explain.

The site is within the Pacific Flyway for Migratory Birds.

d. Proposed measures to preserve or enhance wildlife, if any:

No impacts are anticipated to wildlife, therefore no special measures are proposed.

e. List any invasive animal species known to be on or near the site.

None known.

6. Energy and natural resources [Help]

a. What kinds of energy (electric, natural gas, oil, wood stove, solar) will be used to meet the completed project's energy needs? Describe whether it will be used for heating, manufacturing, etc.

The completed project will utilize electricity to provide for heating, cooling and lighting needs.

b. Would your project affect the potential use of solar energy by adjacent properties? If so, generally describe.

No, the project will not affect the use of solar energy by adjacent properties.

What kinds of energy conservation features are included in the plans of this proposal?
 List other proposed measures to reduce or control energy impacts, if any:

The project will meet the 2015 Washington State Energy Code (WSEC). Other conservation features, such as LED lighting and low-flow plumbing fixutres, will be determined upon development.

7. Environmental health [Help]

- a. Are there any environmental health hazards, including exposure to toxic chemicals, risk of fire and explosion, spill, or hazardous waste, that could occur as a result of this proposal? If so, describe. There is the potential for construction equipment and personal vehicles to leak fuel, oil or other fluids necessary to operate the equipment/vehicles. This risk is typical of construction activities and vehicle trips associated with the development, and is minimal. The site will provide water quality treatment prior to infiltrating
- stormwater, further minimizing the risk of impacts.

 1) Describe any known or possible contamination at the site from present or past uses.

None known.

2) Describe existing hazardous chemicals/conditions that might affect project development and design. This includes underground hazardous liquid and gas transmission pipelines located within the project area and in the vicinity.

None known.

3) Describe any toxic or hazardous chemicals that might be stored, used, or produced during the project's development or construction, or at any time during the operating life of the project.

None known.

4) Describe special emergency services that might be required.

No special emergency services will be required other than those normally provided such as police and fire protections.

5) Proposed measures to reduce or control environmental health hazards, if any:

None are anticipated to be required. Specialized erosion and sediment control measures will be implemented if contaminated soils are detected during the construction process. Standard dust control measures will be implemented to mitigate dust emissions resulting from construction activities. Pursuant to State Law, 811 will be contacted prior to any digging activities to prevent damage to on-site utilities.

b. Noise

1) What types of noise exist in the area which may affect your project (for example: traffic, equipment, operation, other)?

There are no off-site sources of noise that will impact this proposal. The primary source of noise in the area is generated from vehicular traffic along Vancil Road SE.

2) What types and levels of noise would be created by or associated with the project on a short-term or a long-term basis (for example: traffic, construction, operation, other)? Indicate what hours noise would come from the site.

Temporary, short-term noise impacts typical of construction projects will occur with operation of equipment during construction. Construction activities will be restricted to the hours permitted under the Yelm Municipal Code. Long term noise will be minimal, and will be typical of residential developments.

3) Proposed measures to reduce or control noise impacts, if any: To mitigate general noise impacts during the construction phase, measures such as locating stationary equipment away from receiving properties, limiting construction hours to the appropriate Yelm ordinance, turn off idling construction equipment, and train construction crews to avoid unnecessarily loud actions near residential areas will be employed.

8. Land and shoreline use [Help]

a. What is the current use of the site and adjacent properties? Will the proposal affect current land uses on nearby or adjacent properties? If so, describe.

The site is currently vacant. It is bounded by single family residential to the north, vacant residential land to the east and south, and Vancil Road SE to the west.

b. Has the project site been used as working farmlands or working forest lands? If so, describe. How much agricultural or forest land of long-term commercial significance will be converted to other uses as a result of the proposal, if any? If resource lands have not been designated, how many acres in farmland or forest land tax status will be converted to nonfarm or nonforest use?

Not to our knowledge.

1) Will the proposal affect or be affected by surrounding working farm or forest land normal business operations, such as oversize equipment access, the application of pesticides, tilling, and harvesting? If so, how:

No.

c. Describe any structures on the site.

There are no structures on the site.

d. Will any structures be demolished? If so, what?

N/A

e. What is the current zoning classification of the site? R-6.

f. What is the current comprehensive plan designation of the site?

R-6, Moderate Density Residential.

g. If applicable, what is the current shoreline master program designation of the site?

Not applicable.

h. Has any part of the site been classified as a critical area by the city or county? If so, specify.

i. Approximately how many people would reside or work in the completed project?

Based on 2.5 persons per household, approximately 148 people will reside in the completed project.

- j. Approximately how many people would the completed project displace? None.
- k. Proposed measures to avoid or reduce displacement impacts, if any:

Does not apply.

I. Proposed measures to ensure the proposal is compatible with existing and projected land uses and plans, if any:

The proposed project is residential, consistent with the surrounding area. The project requires approval through the Preliminary Plat process to ensure it is compatible with existing and proposed land uses.

m. Proposed measures to reduce or control impacts to agricultural and forest lands of longterm commercial significance, if any:

No special measures are proposed.

9. Housing [Help]

a. Approximately how many units would be provided, if any? Indicate whether high, middle, or low-income housing.

59 units are proposed and will be middle income housing.

b. Approximately how many units, if any, would be eliminated? Indicate whether high, middle, or low-income housing.

None.

c. Proposed measures to reduce or control housing impacts, if any:

No special measures are proposed.

10. Aesthetics [Help]

a. What is the tallest height of any proposed structure(s), not including antennas; what is the principal exterior building material(s) proposed?

The height of the structures will not exceed the maximum height allowed in the R-6 zone. The exterior building materials will likely be wood.

b. What views in the immediate vicinity would be altered or obstructed?

The site will transition from a vacant property to an attractive residential neighborhood.

c. Proposed measures to reduce or control aesthetic impacts, if any:

Perimeter landscaping and/or sight obscuring fencing will screen the development.

11. Light and glare [Help]

a. What type of light or glare will the proposal produce? What time of day would it mainly occur?

Exterior lighting from the houses and street lights will occur after dark, typical of a residential neighborhood.

- b. Could light or glare from the finished project be a safety hazard or interfere with views? No. Lighting will be directed downward so s not to interfere with views or provide glare.
- c. What existing offsite sources of light or glare may affect your proposal? There are no off-site sources of light or glare that will impact the proposal.
- d. Proposed measures to reduce or control light and glare impacts, if any:
 Lighting fixtures will be shielded and cast downward to reduce light and glare impacts.
 All lighting fixtures will meet city requirements for light spillage.

12. Recreation [Help]

- a. What designated and informal recreational opportunities are in the immediate vicinity? Prairie Elementary School is located southeast of the site, approximately 0.25 miles away. Ball fields and play equipment are available for public use during non-school hours.
- b. Would the proposed project displace any existing recreational uses? If so, describe. No.
- c. Proposed measures to reduce or control impacts on recreation, including recreation opportunities to be provided by the project or applicant, if any:

The project will provide open space with active recreation amenities for the residences.

13. Historic and cultural preservation [Help]

a. Are there any buildings, structures, or sites, located on or near the site that are over 45 years old listed in or eligible for listing in national, state, or local preservation registers? If so, specifically describe.

There are no known buildings, structures, or sites within the immediate vicinity of the project site that are listed on national, state, or local preservation registers.

b. Are there any landmarks, features, or other evidence of Indian or historic use or occupation. This may include human burials or old cemeteries. Are there any material evidence, artifacts, or areas of cultural importance on or near the site? Please list any professional studies conducted at the site to identify such resources.

None, to our knowledge.

- c. Describe the methods used to assess the potential impacts to cultural and historic resources on or near the project site. Examples include consultation with tribes and the department of archeology and historic preservation, archaeological surveys, historic maps, GIS data, etc. The Washington State Department of Archaeology and Historic Preservation Historic Property Inventory Report was reviewed to determine there are no listings near the project site.
- d. Proposed measures to avoid, minimize, or compensate for loss, changes to, and disturbance to resources. Please include plans for the above and any permits that may be required.

 If cultural or archaeological objects are found during the site preparation work, the Department of Archaeological and Historic Preservation will be notified and appropriate measures will be taken.

14. Transportation [Help]

a. Identify public streets and highways serving the site or affected geographic area, and describe proposed access to the existing street system. Show on site plans, if any.

The project will be served by Vancil Road SE, with an additional access point through Country Meadows Estates Phase 2 to Morris Road.

- b. Is the site or affected geographic area currently served by public transit? If so, generally describe. If not, what is the approximate distance to the nearest transit stop?
 Not to our knowledge.
- c. How many additional parking spaces would the completed project or nonproject proposal have? How many would the project or proposal eliminate?

Each residence will have a two car garage and parking in their driveways.

d. Will the proposal require any new or improvements to existing roads, streets, pedestrian, bicycle or state transportation facilities, not including driveways? If so, generally describe (indicate whether public or private).

Some frontage improvements may be required along Vancil Road SE.

- e. Will the project or proposal use (or occur in the immediate vicinity of) water, rail, or air transportation? If so, generally describe.

 No.
- f. How many vehicular trips per day would be generated by the completed project or proposal? If known, indicate when peak volumes would occur and what percentage of the volume would be trucks (such as commercial and nonpassenger vehicles). What data or transportation models were used to make these estimates?
 - Based on the Traffic Impact Analysis prepared by Heath and Associates dated July 24, 2023, the project will generate 621 average weekday daily trips with 46 AM peak trips and 61 PM peak trips.
- g. Will the proposal interfere with, affect or be affected by the movement of agricultural and forest products on roads or streets in the area? If so, generally describe.

 No.

h. Proposed measures to reduce or control transportation impacts, if any: Payment of traffic facilities charge.

15. Public services [Help]

a. Would the project result in an increased need for public services (for example: Fire protection, police protection, public transit, health care, schools, other)? If so, generally describe.

There will be a need for fire or police services in the event of a fire or accident.

b. Proposed measures to reduce or control direct impacts on public services, if any. Impacts to the road network due to the increase in vehicular traffic will be mitigated through the payment of traffic impact fees. Impacts to schools will be mitigated through the payment of school impact fees. Property taxes collected on the property will reduce impacts to public services.

16. Utilities [Help]

- a. Circle utilities currently available at the site: (ectricity) natural gas (water) refuse service, telephone, sanitary sewer, septic system, other.
- b. Describe the utilities that are proposed for the project, the utility providing the service, and the general construction activities on the site or in the immediate vicinity which might be needed.

PSE: Electricity Comcast: Cable

City of Yelm: Water and Sewer Telephone: Fairpoint Communications

Refuse: Pacific Disposal

C. SIGNATURE

The above answers are true and complete to the best of my knowledge. I understand that the lead agency is relying on them to make its decision.

Signature:

Date Submitted: 8/22/2023

D. SUPPLEMENTAL SHEET FOR NONPROJECT ACTIONS [Help]

(do not use this sheet for project actions)

Because these questions are very general, it may be helpful to read them in conjunction with the list of the elements of the environment.

When answering these questions, be aware of the extent the proposal, or the types of activities likely to result from the proposal, would affect the item at a greater intensity or at a faster rate than if the proposal were not implemented. Respond briefly and in general terms.

- 1. How would the proposal be likely to increase discharge to water; emissions to air; production, storage, or release of toxic or hazardous substances; or production of noise? Proposed measures to avoid or reduce such increases are:
- 2. How would the proposal be likely to affect plants, animals, fish, or marine life?

 Proposed measures to protect or conserve plants, animals, fish, or marine life are:
- 3. How would the proposal be likely to deplete energy or natural resources?

 Proposed measures to protect or conserve energy and natural resources are:
- 4. How would the proposal be likely to use or affect environmentally sensitive areas or areas designated (or eligible or under study) for governmental protection; such as parks, wilderness, wild and scenic rivers, threatened or endangered species habitat, historic or cultural sites, wetlands, flood plains, or prime farmlands?

Proposed measures to protect such resources or to avoid or reduce impacts are:

5. How would the proposal be likely to affect land and shoreline use, including whether it would allow or encourage land or shoreline uses incompatible with existing plans?

Proposed measures to avoid or reduce shoreline and land use impacts are:

6. How would the proposal be likely to increase demands on transportation or public services and utilities?

Proposed measures to reduce or respond to such demand(s) are:

7. Identify, if possible, whether the proposal may conflict with local, state, or federal laws or requirements for the protection of the environment.



City of Yelm WASHINGTON

SEPA#2023.0163

DETERMINATION OF NONSIGNIFICANCE

PROJECT NAME: Country Meadows Estates Phase 1

PROJECT LOCATION: 17835 State Route 507 SE, Yelm WA 98597

PROJECT PARCEL NUMBERS: 22730410300 LAND USE CASE NUMBER: 2023.0163

An application submitted by AHBL, 2215 South 30th St, Suite 300, Tacoma, WA 98403 on behalf of Copper Ridge LLC for a 78 lot subdivision located at 17835 State Route 507 SE, Yelm was received by the City of Yelm on September 7th, 2023. The City has determined the application to be complete on November 1, 2023. The application and any related documents are available for public review during normal business hours at the City of Yelm, Public Services Department, 901 NW Rhoton Rd, Yelm WA. For additional information, please contact the Public Services Department at (360) 458-8406.

Description of proposal: 78-lot single family subdivision.

Lead agency: City of Yelm

Yelm Public Services Department has determined that this proposal does not have a probable significant adverse impact on the environment. An environmental impact statement (EIS) is not required under RCW 43.21C.030 (2)(c). This decision was made after reviewing a completed environmental checklist and other information on file with the City. This information is available to the public on request.

\square This DNS is issued under WAC 197-11-340(2); the lead agency will not act on this proposal for 14 days from the date
below. This may be your only opportunity to comment. Agencies, tribes, and the public are encouraged to review and
comment on the proposed project and its possible environmental impact no later than March 21, 2024. Please send your
comments to the address below.

Responsible official: Gary Cooper

Position/title: Planning and Building Manager, City of Yelm - Public Services

Address: 901 NW Rhoton Rd Yelm WA 98597

Email: GaryC@yelmwa.gov

2:
E

You may appeal this determination to City of Yelm – Public Services Department, 901 NW Rhoton, Yelm WA 98597. All appeals must be filed with City of Yelm in writing with a \$700.00 fee submitted by 4:30 pm on March 21, 2024. You may contact Clayton Wiebe to ask about the procedures for SEPA appeals.

CITY OF YELM COMPREHENSIVE PLAN

The proposed plan is compatible with the following goals and policies of the City of Yelm Comprehensive Plan.

Land Use:

Goal 11-Create safe and vibrant neighborhoods with places that build community and encourage active transportation.

Policy 11.1- Plan at the neighborhood level to increase housing density and diversity while preserving neighborhood character and quality of life.

Transportation:

Goal 2-Create a well maintained transportation system that provides safe and cost effective movement of goods, services, and people.

Policy 2.4- Ensure adequate and safe access to property through a system of public and private roads.

The environmental threshold determination is based on analysis of information contained in the following documents:

- Preliminary civil plans,
- Geotechnical report,
- Trip Generation Report,
- Mazama Pocket Gopher Study,
- Preliminary Stormwater Report,
- SEPA Checklist, T
- Title Report

Notes:

- The issuance of a Determination of Nonsignificance does not constitute project approval. All building plans and site design must meet the following: 2021 International Fire Code, the 2021 International Building Code, the City of Yelm Engineering Engineering Specifications and Standard Details (YMC Title YMC 18.28) and the City of Yelm Municipal Code (CMC Title 18).
- 2. The Determination of Nonsignificance is based on the applicant constructing Phase 1 of Country Meadow's in accordance with the permit SEPA2023-0163, applicant's Preliminary Plans, and applicant's Stormwater Plans.
- 3. If contamination is currently known or observed during construction, sampling of the potentially contaminated media must be conducted. If contamination of soil or groundwater is readily visible, or is revealed by sampling, the Department of Ecology must be notified. Contact the Environmental Report Tracking System Coordinator at the Southwest Regional Office at 360.407.6300. For assistance and information about subsequent cleanup and to identify the type of testing that will be required contact the Toxics Cleanup Program at 360.407.6241.
- 4. Erosion control measures must be in place prior to any clearing, grading, or construction. These control measures must be effective to prevent soil from being carried into surface water by stormwater runoff. Sand, silt, clay particles, and soil will damage aquatic habitat and are considered pollutants.

Any discharge of sediment-laden runoff or other pollutants to waters of the state is in violation of Chapter 90.48, Water Pollution Control, and WAC 173-201A, Water Quality Standards for Surface Waters of the State of Washington and is subject to enforcement action.

- 5. During construction, all releases of oils, hydraulic fluids, fuels, other petroleum products, paints, solvents, and other deleterious materials must be contained and removed in a manner that will prevent their discharge to waters and soils of the state. The cleanup of spills should take precedence over other work.
 - 6. In the event any archaeological or historic materials are encountered during project activity, work in the immediate area (initially allowing for a 100' buffer; this number may vary by circumstances) must stop and the following actions taken:
 - a. Implement reasonable measures to protect the discovery site, including any appropriate stabilization or covering; and
 - b. Take reasonable steps to ensure the confidentiality of the discovery site; and
 - c. Take reasonable steps to restrict access to the site of discovery.

The project proponent will notify the concerned Tribes and all appropriate local, state and federal agencies including the Department of Archaeology and Historic Preservation and the City of Yelm Community Development. The agencies and Tribes(s) will discuss possible measures to remove or avoid cultural material and will reach an agreement with the project proponent regarding actions to be taken and disposition of material.

If human remains are uncovered, the City of Yelm Police Department shall be notified first and the above steps followed. IF the remains are determined to be Native, consultation with the affected Tribes will take place in order to mitigate the final disposition of said remains.


See the Revised Code of Washington, Chapter 27.53, "Archaeological Sites and Resources," for applicable laws and statutes. See also Washington State Executive Order 05-05, "Archaeological and Cultural Resources." Additional state and federal law(s) may also apply.

CC: WA Dept of Ecology with SEPA checklist



COUNTRY MEADOWS ESTATES PHASE 1 PRELIMINARY PLAT

A PORTION OF THE NE 1/4 OF THE SE 1/4 OF SEC. 30, TWN. 17 N., RGE. 02 E., W.M., CITY OF YELM, THURSTON COUNTY, WASHINGTON.

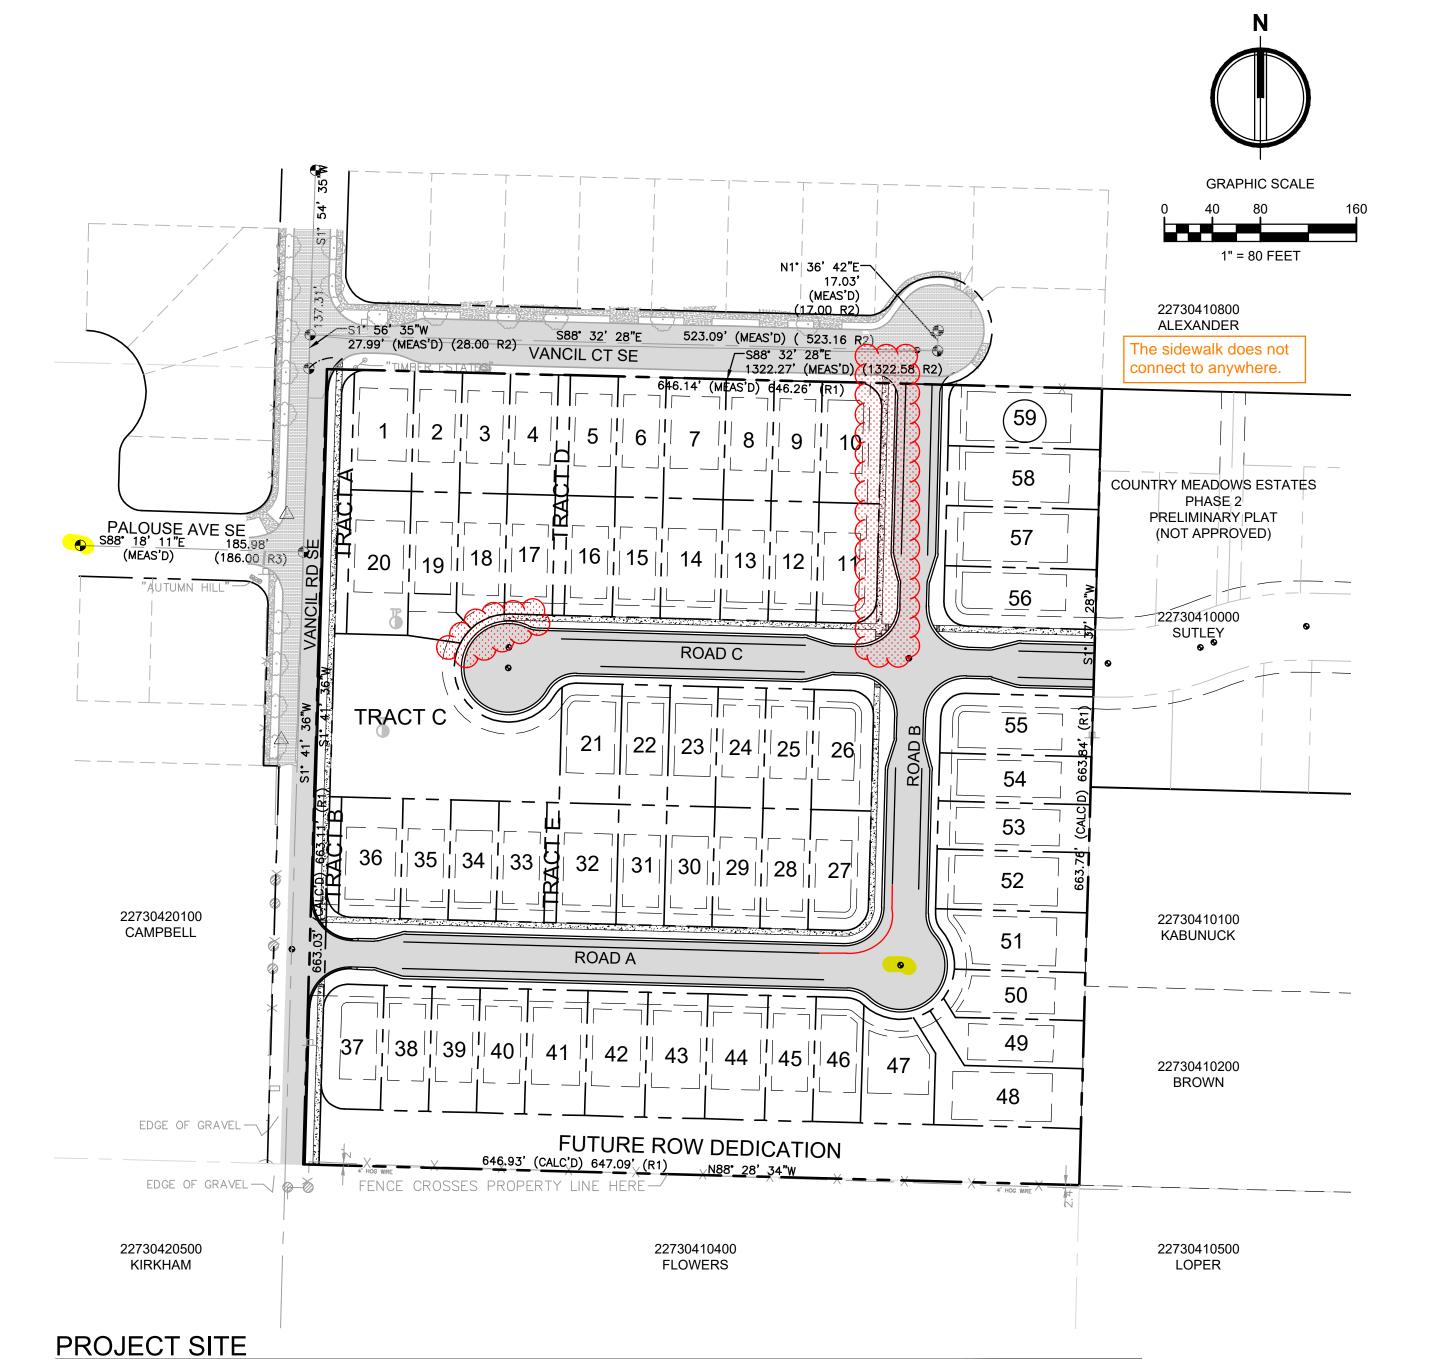

DEVELOPER

COPPER RIDGE, LLC P.O.BOX 73790 PUYALLUP, WA 98403 CONTACT: EVAN MANN

CIVIL ENGINEER

AHBL ENGINEERS, PLANNERS, & SURVEYORS 2215 NORTH 30TH STREET, SUITE 300 TACOMA, WA 98403 PH. (253) 383-2422 FAX (253) 383-2572 CONTACT: MATT WEBER, P.E.

SURVEYOR

AHBL ENGINEERS, PLANNERS, & SURVEYORS 2215 NORTH 30TH STREET, SUITE 300 TACOMA, WA 98403 PH. (253) 383-2422 CONTACT: DAVE FOLLANSBEE, PLS.

LEGAL DESCRIPTION

THE NORTHWEST QUARTER OF THE NORTHEAST QUARTER OF THE SOUTHEAST QUARTER OF SECTION 30, TOWNSHIP 17 NORTH, RANGE 2 EAST, W.M.;

EXCEPTING THEREFROM THE WEST 15 FEET FOR COUNTY ROAD KNOWN AS VANCIL ROAD, THURSTON COUNTY, WASHINGTON.

THERE IS NO MENTION OR DEPICTION OF SAID DITCH ON SAID

VERTICAL DATUM

NAVD 1988 VERTICAL DATUM ON ORTHOMETRICALLY CORRECTED GPS OBSERVATIONS USING WSRN AND GEOID

BASIS OF BEARING

WASHINGTON STATE PLANE SOUTH PROJECTION, BASED ON GPS OBSERVATIONS USING WSRN AND GEOID 2012A. UNITS OF MEASUREMENT ARE US SURVEY FEET.

> VANCIL RD SE YELM, WA 98597

R6, RESIDENTIAL


SITE DATA

PARCEL NUMBER: 22730410300

ADDRESS:

EXISTING ZONING:

SITE AREA: 428,902 SF (9.84 AC)

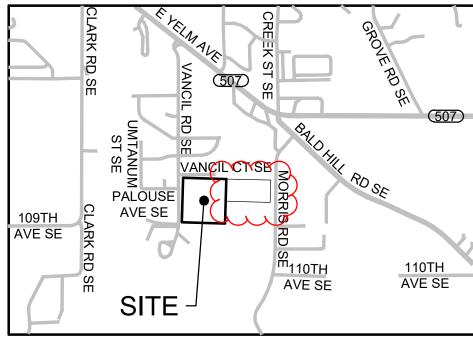

VICINITY MAP SCALE: 1" = 1,320' (1/4 MILE)

LEGEND PROPOSED **EXISTING FOUND MONUMENT AS NOTED** SET NAIL AND WASHER MAIL BOX **GATE POST** TEST PIT SANITARY SEWER CLEANOUT STORM CATCH BASIN **GAS VALVE GUY ANCHOR** UTILITY POWER POLE LUMINAIRE **BLOW OFF VALVE** FIRE HYDRANT HOSE BIB IRRIGATION CONTROL VALVE WATER METER WATER MANHOLE WATER VALVE DECIDUOUS TREE U=UNKNOWN STORM LINE SEWER PAINT LINE GAS LINE ELECTRICAL LINE OVERHEAD UTILITIES FENCE **ASPHALT** CONCRETE

Please add this column to the Sheet List

		Sheet List Table
İ	Sheet Number	Sheet Title
Ī	C0.1	COVER SHEET
Ī	C0.2	EXISTING CONDITIONS
Ī	C1.1	PLAT MAP
Ī	C2.1	ROAD A CONCEPT PLAN AND PROFILE
	C2.2	ROAD B CONCEPT PLAN AND PROFILE
Ī	C2.3	ROAD C CONCEPT PLAN AND PROFILE
	C2.4	VANCIL RD SE CONCEPT PLAN AND PROFILE
	C3.1	CONCEPT GRADING PLAN
Ī	C4.1	CONCEPT STORM PLAN
0	C5.1	CONCEPT UTILITY PLAN
1	C6.1	CONCEPTUAL LANDSCAPE PLAN

<u>-</u>		Sheet List Table							
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-	1	C0.1	COVER SHEET						
<u>-</u>	2	C0.2	EXISTING CONDITIONS						
-	3	C1.1	PLAT MAP						
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-	5	C2.2	ROAD B CONCEPT PLAN AND PROFILE						
-	6	C2.3	ROAD C CONCEPT PLAN AND PROFILE						
-	7	C2.4	VANCIL RD SE CONCEPT PLAN AND PROFILE						
-	8	C3.1	CONCEPT GRADING PLAN						
-	9	C4.1	CONCEPT STORM PLAN						
بر ب	10	C5.1	CONCEPT UTILITY PLAN						
-	11	C6.1	CONCEPTUAL LANDSCAPE PLAN						

FILL SPECIFICATION

IMPORTED FILL MATERIAL SHALL NOT CONTAIN PETROLEUM PRODUCTS, OR SUBSTANCES WHICH ARE HAZARDOUS, DANGEROUS, TOXIC, OR WHICH OTHERWISE VIOLATE ANY STATE, FEDERAL, OR LOCAL LAW, ORDINANCE, CODE, REGULATION, RULE, ORDER, OR STANDARD.

UTILITY NOTE

THE LOCATIONS OF EXISTING UNDERGROUND UTILITIES ARE APPROXIMATE ONLY AND HAVE NOT BEEN INDEPENDENTLY VERIFIED BY THE OWNER OR ITS REPRESENTATIVE. THE CONTRACTOR SHALL DETERMINE THE EXACT LOCATION OF ALL EXISTING UTILITIES BEFORE COMMENCING WORK AND AGREES TO BE FULLY RESPONSIBLE FOR ANY AND ALL DAMAGES THAT HAPPEN DUE TO THE CONTRACTOR'S FAILURE TO LOCATE EXACTLY AND PRESERVE ANY AND ALL UNDERGROUND UTILITIES. AHBL ASSUMES NO LIABILITY FOR THE LOCATION OF UNDERGROUND UTILITIES.

TRENCH NOTE

IF WORKERS ENTER ANY TRENCH OR OTHER EXCAVATION FOUR OR MORE FEET IN DEPTH THAT DOES NOT MEET THE OPEN PIT REQUIREMENTS OF WSDOT SECTION 2-09.3(3)B, IT SHALL BE SHORED AND CRIBBED. THE CONTRACTOR ALONE SHALL BE RESPONSIBLE FOR WORKER SAFETY AND AHBL ASSUMES NO RESPONSIBILITY. ALL TRENCH SAFETY SYSTEMS SHALL MEET THE REQUIREMENTS OF THE WASHINGTON INDUSTRIAL SAFETY AND HEALTH ACT, CHAPTER 49.17 RCW.

WETLAND DELINEATION

NO WETLANDS HAVE BEEN DELINEATED ON-SITE OR IMMEDIATELY ADJACENT TO THE PROJECT SITE.

CUT = 7,700 CU. YDS FILL = 5,700 CU. YDS NET = 2,000 CU. YDS EXPORT

NOTE:
THE ABOVE QUANTITIES ARE ESTIMATES ONLY INTENDED FOR
THE ABOVE QUANTITIES ARE ESTIMATES ONLY INTENDED FOR BID PURPOSES. THE PERMITTING PROCESS. DO NOT USE FOR BID PURPOSES. THE QUANTITIES DO NOT HAVE STRIPPING, COMPACTION, OR CUT OR FILL ADJUSTMENT FACTORS APPLIED TO THEM, NOR DO THEY ACCOUNT FOR ROADWAY SECTION.

EARTHWORK QUANTITIES

With the succession of the suc 1 of 11 Sheets APPLICATION #999???

DATE: September 1, 2023 FILENAME: Q:\2023\2230251\10_CIV\CAD_Preliminary Plat\2230251-SH-COVR.dwg

2215 North 30th Street, Suite 300 Tacoma, WA 98403 Project Title: **COUNTRY MEADOWS ESTATES**

PHASE 1 PRELIMINARY PLAT

COPPER RIDGE LLC

P.O.BOX 73790 PUYALLUP, WA 98373

KURT WILSON / EVAN MANN

<u>Project No.</u>


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Issue Set & Date:

PRELIMINARY PLAT

9/01/2023



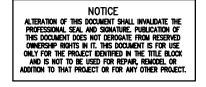

Revisions:

Sheet Title:

COVER SHEET

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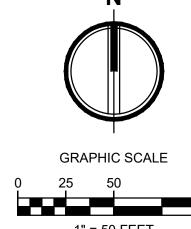
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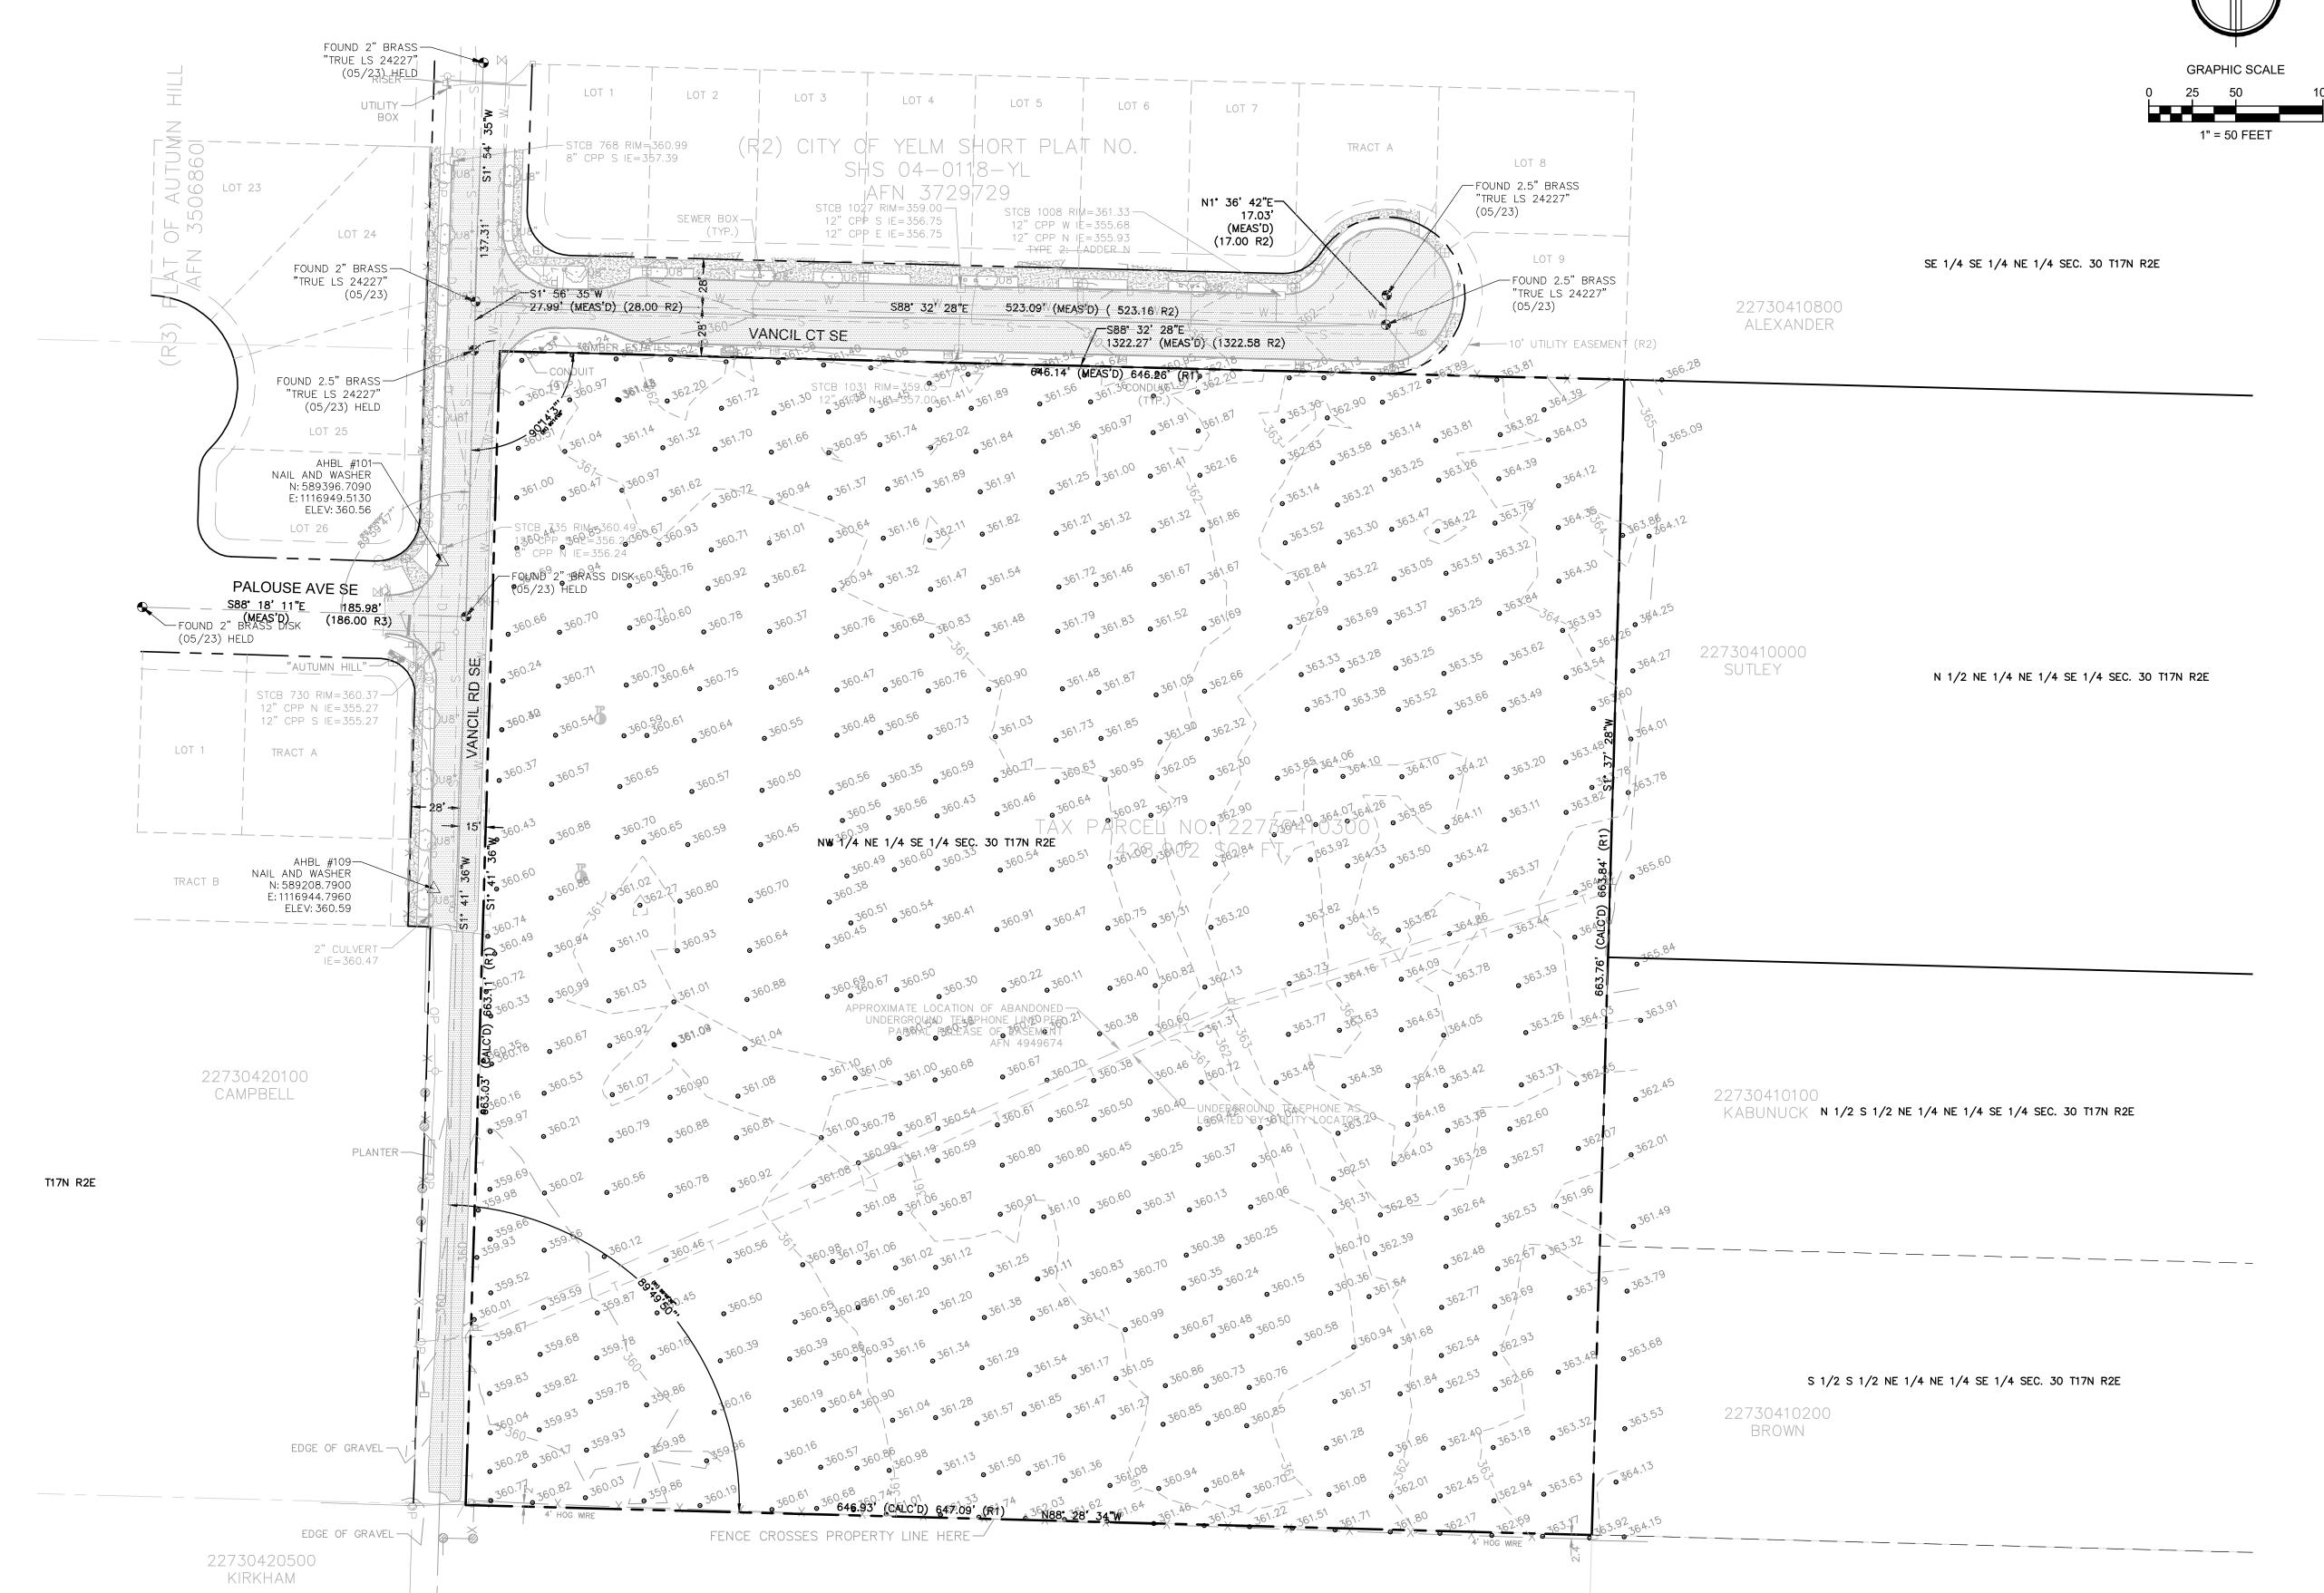
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Call before you dig.

COUNTRY MEADOWS ESTATES PHASE 1 PRELIMINARY PLAT

A PORTION OF THE NE 1/4 OF THE SE 1/4 OF SEC. 30, TWN. 17 N., RGE. 02 E., W.M., CITY OF YELM, THURSTON COUNTY, WASHINGTON.





Project Title: COUNTRY

MEADOWS ESTATES PHASE 1 PRELIMINARY PLAT

COPPER RIDGE LLC

P.O.BOX 73790 PUYALLUP, WA 98373 KURT WILSON / EVAN MANN


Project No.

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Issue Set & Date:

PRELIMINARY PLAT

9/01/2023



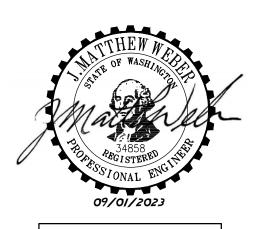

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EXISTING CONDITIONS


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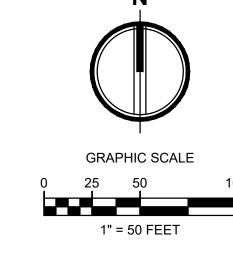
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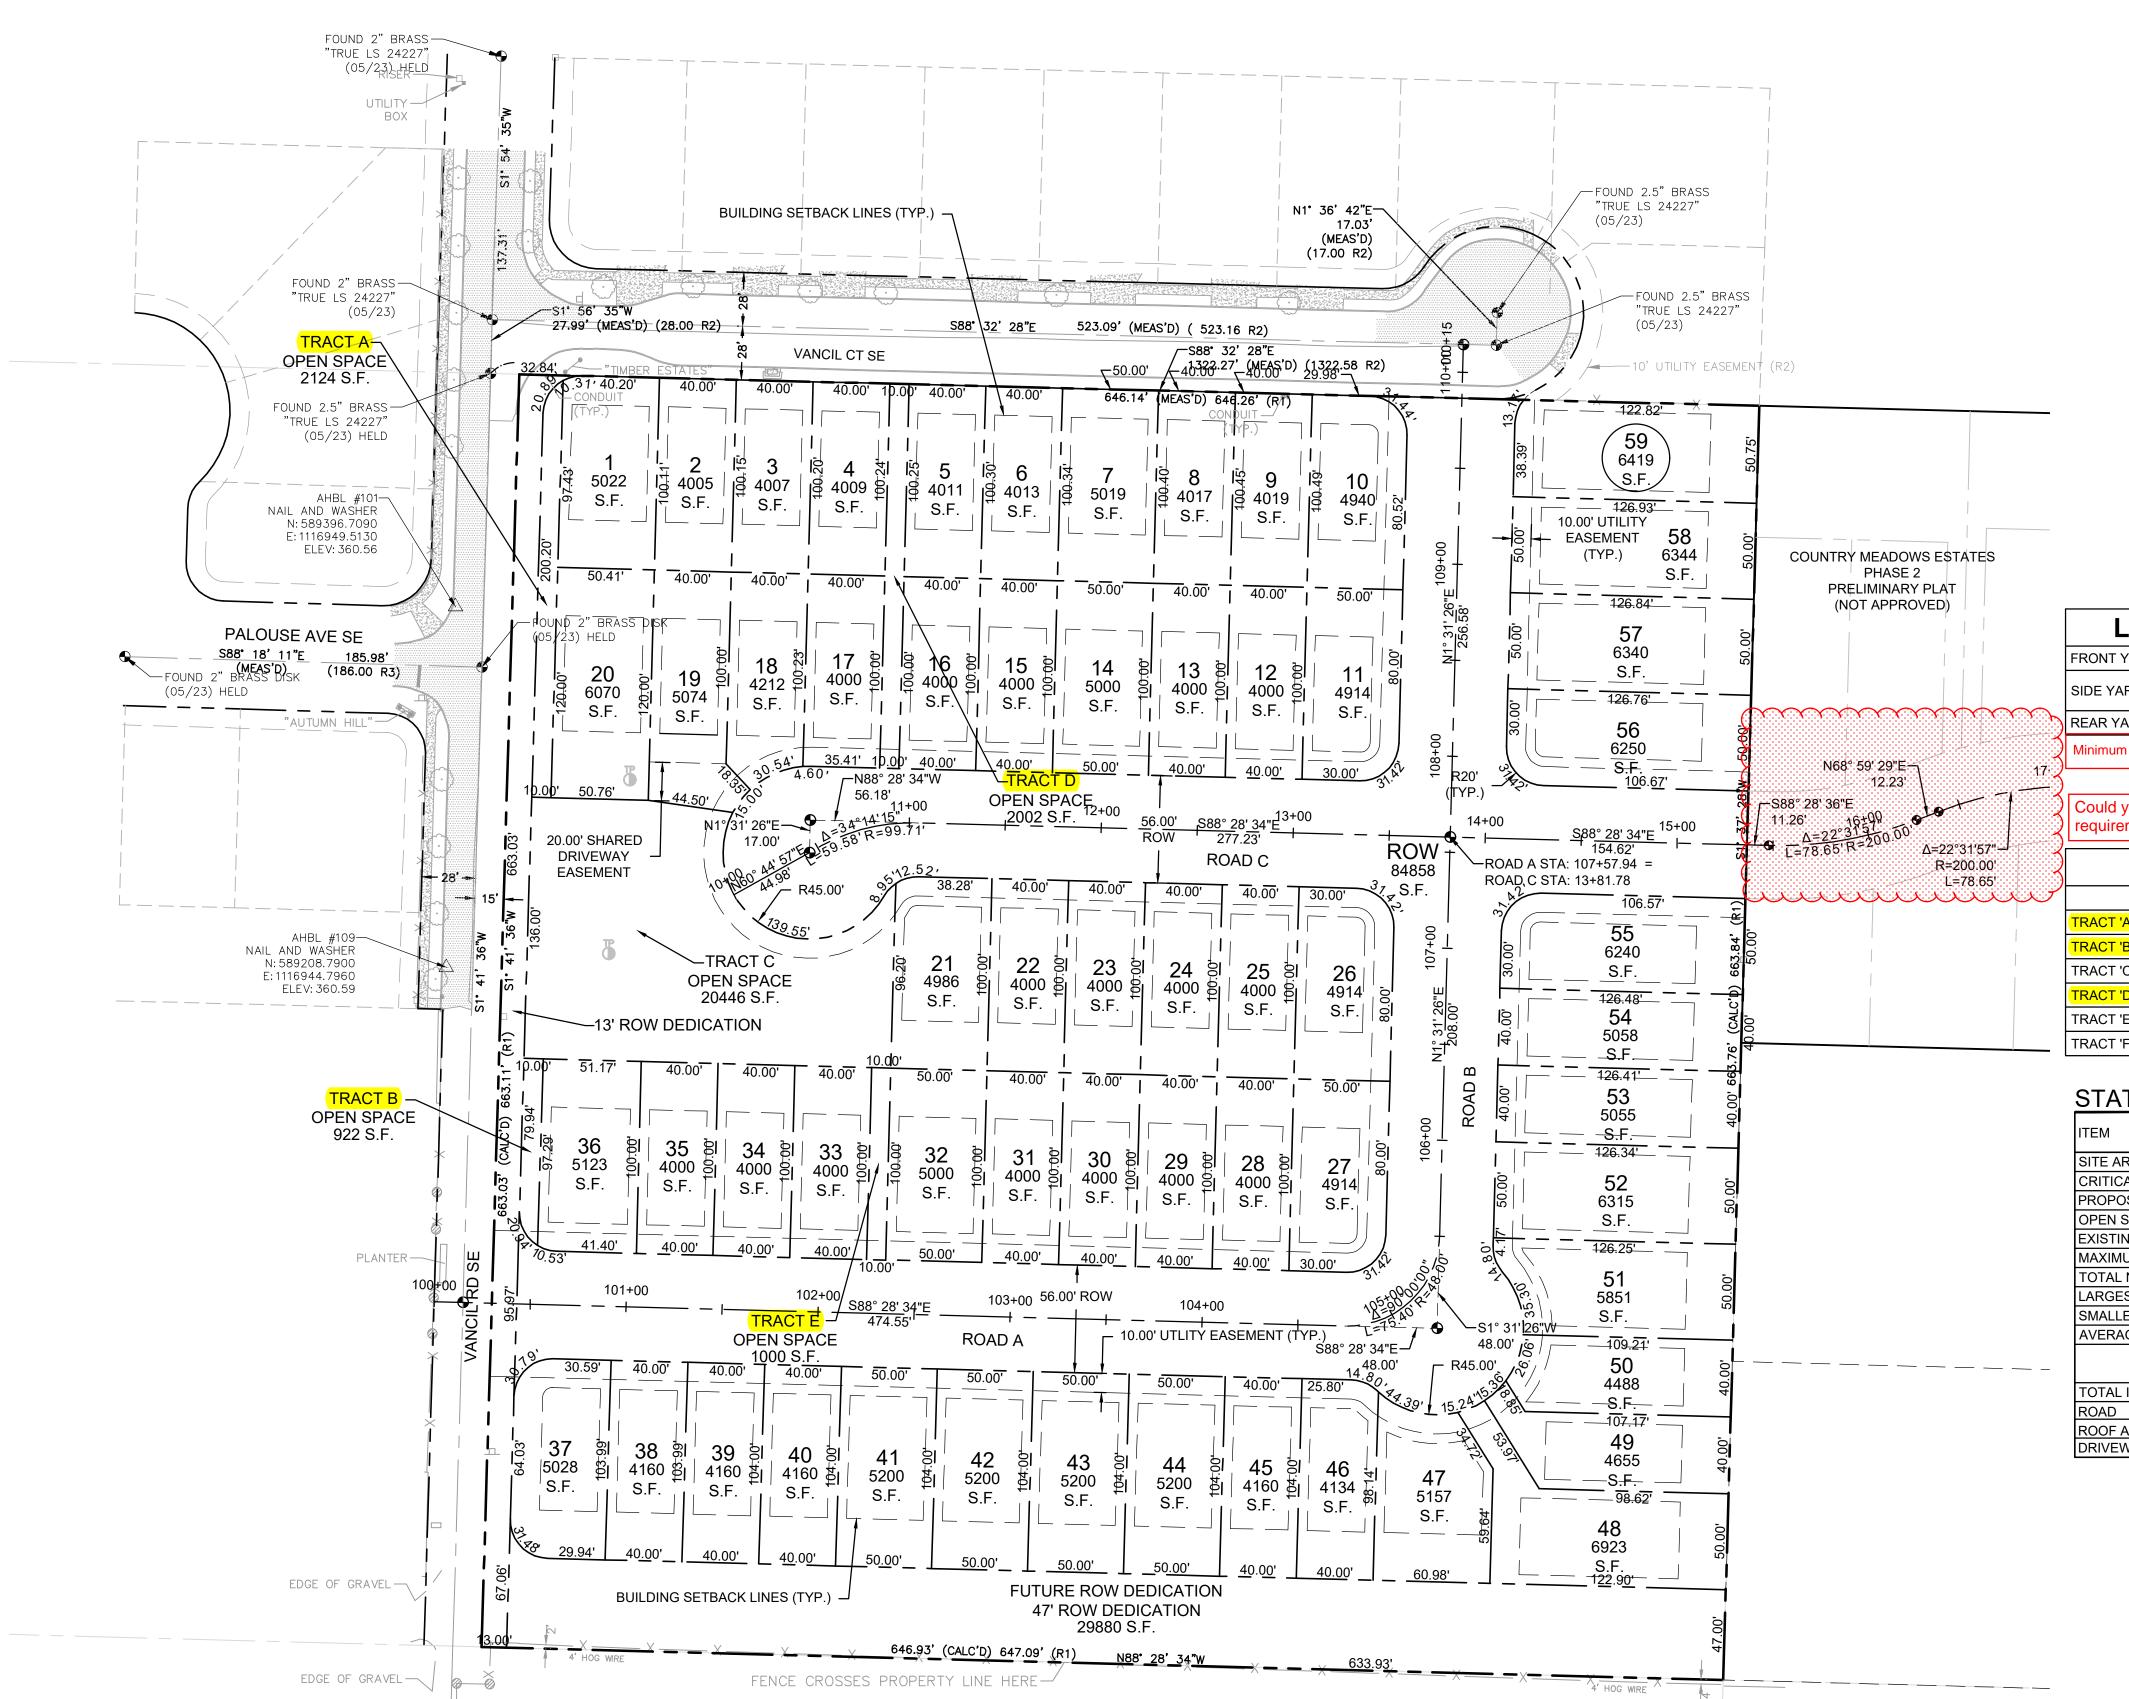
2 of 11 Sheets

COUNTRY MEADOWS ESTATES PHASE 1 PRELIMINARY PLAT

A PORTION OF THE NE 1/4 OF THE SE 1/4 OF SEC. 30, TWN. 17 N., RGE. 02 E., W.M., CITY OF YELM, THURSTON COUNTY, WASHINGTON.





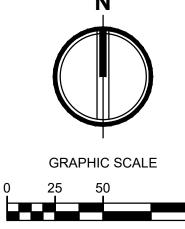

	LOT SETBACKS - SINGLE FAMILY						
	FRONT YARD	15 FT					
(SIDE YARD	5 FT 15 FT (CORNER LOT)					
	REAR YARD	25 FT					
	·						

Minimum driveway approach (Length) 20 FT

Could you please justify how track A, B, and D meet the open space

$\left.\right\rangle$	TRACT IDENTIFICATION						
•	ITEM	SQUARE FEET	ACRES				
	TRACT 'A' - OPEN SPACE	2,124	0.05				
	TRACT 'B' - OPEN SPACE	922	0.02				
	TRACT 'C' - OPEN SPACE	20,466	0.47				
	TRACT 'D' - OPEN SPACE	2,002	0.05				
	TRACT 'E' - OPEN SPACE	1,000	0.02				
	TRACT 'F' - FUTURE ROW DEDICATION	29,880	0.68				

STATISTICAL BREAKDOWN

ITEM	DESCRIPTION (OR AREA	
I I EIVI	SQUARE FEET	ACRES	
SITE AREA	428,902	9.84	
CRITICAL AREAS	0	0.00	
PROPOSED ONSITE ROAD ROW	84,856	1.95	
OPEN SPACE (5% MINIMUM = 21,445 SF)	26,514	0.60	
EXISTING & PROPOSED ZONING:	R-6, RESIDENTI	AL	
MAXIMUM DENSITY (6 DU/ACRE)	59.04 (USE 59)		
TOTAL NO. OF LOTS PROPOSED (SINGLE FAMILY)	59		
LARGEST LOT AREA (LOT 48)	6,923	0.16	
SMALLEST LOT AREA (MULTIPLE LOTS)	4,000	0.11	
AVERAGE LOT AREA	4,885	0.11	
TOTAL IMPERVIOUS SURFACE (54.97%)	235,772	5.41	
ROAD	58,772	1.35	
ROOF AREA (2,500 SF x 59 UNITS)	147,500	3.39	
DRIVEWAYS (500 SF x 59 UNITS)	29,500	0.68	



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COUNTRY MEADOWS ESTATES PHASE 1 PRELIMINARY PLAT

COPPER RIDGE LLC

P.O.BOX 73790 PUYALLUP, WA 98373

KURT WILSON / EVAN MANN

<u>Project No.</u>

Project Title:


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Issue Set & Date:

PRELIMINARY PLAT

9/01/2023



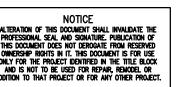

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PLAT MAP

Designed by: Drawn by:

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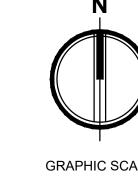
3 of 11 Sheets

Checked by:

APPLICATION #999???

COUNTRY MEADOWS ESTATES PHASE 1 PRELIMINARY PLAT

A PORTION OF THE NE 1/4 OF THE SE 1/4 OF SEC. 30, TWN. 17 N., RGE. 02 E., W.M., CITY OF YELM, THURSTON COUNTY, WASHINGTON.



COUNTRY
MEADOWS ESTATES
PHASE 1
PRELIMINARY PLAT

Project Title:

Client:
COPPER RIDGE LLC

P.O.BOX 73790 PUYALLUP, WA 98373

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Project No.


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Revisions:

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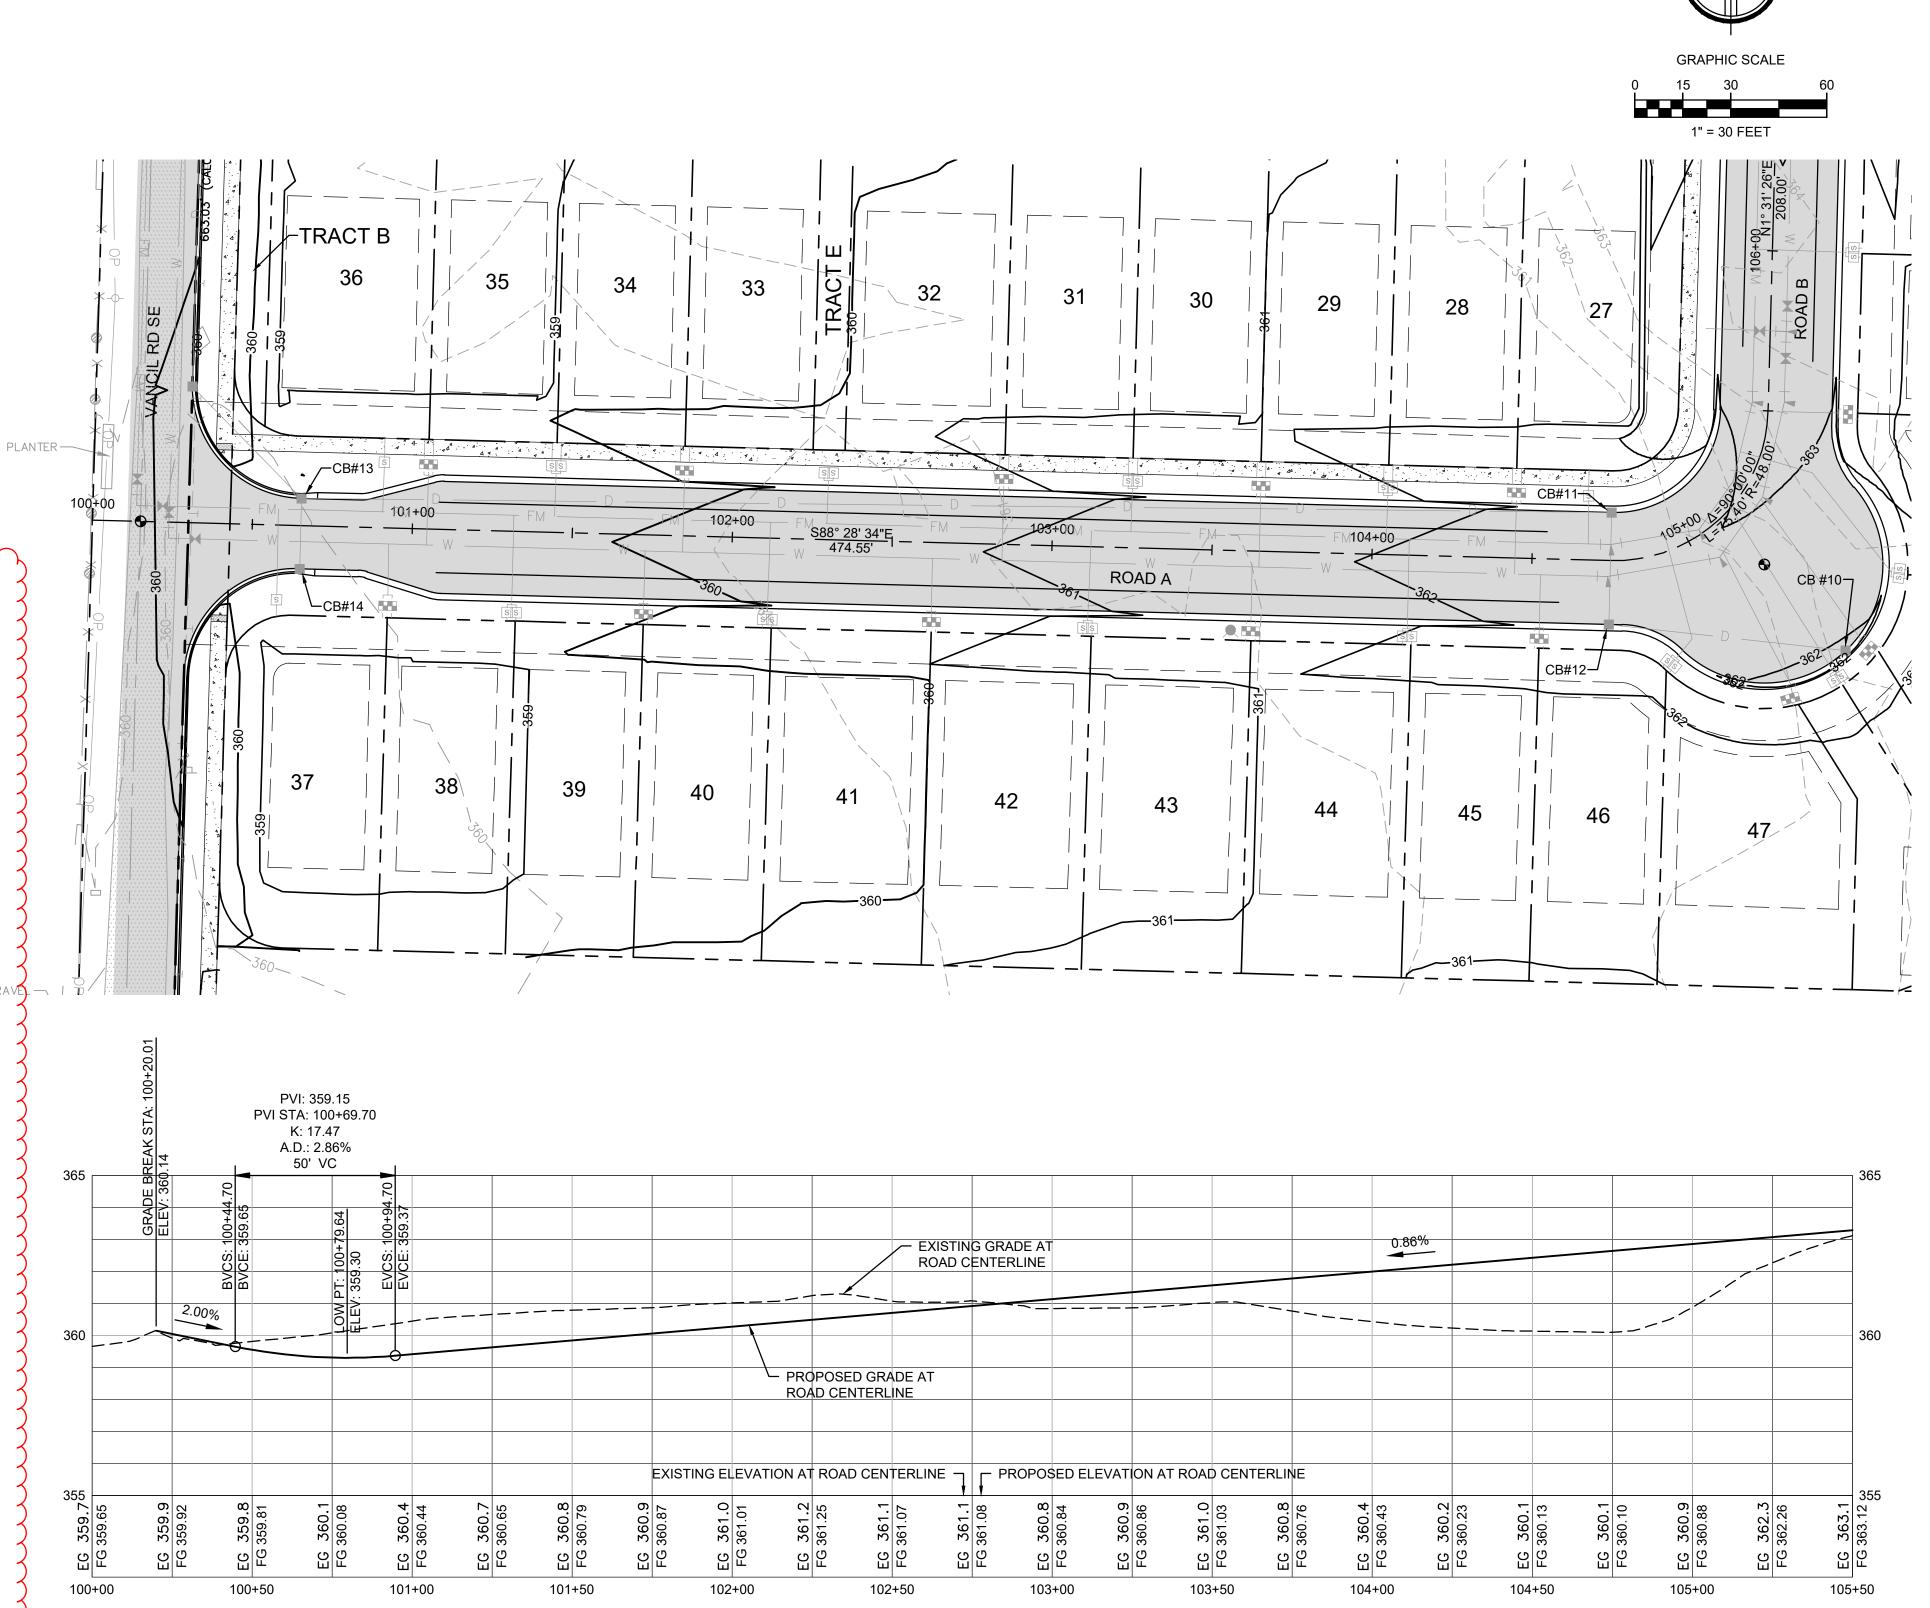
ROAD A CONCEPT PLAN AND PROFILE

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by: Checked by: MW/SK

Sheet No.

C2.14 of 11 Sheets

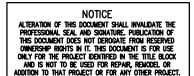

GENERAL NOTES:

1. "ON STREET" PARKING PERMITTED.

LIGHTING, PAVEMENT STRUCTURE, ETC.

2. REFER TO RELEVANT SECTIONS OF THE DEVELOPMENT GUIDELINES FOR ADDITIONAL INFORMATION ON STORM DRAINAGE, STREET

Having a road detail is not necessary for each page it can be

11' 7.5' 6' 5'

APPROVED

CITY OF YELM DEPT. OF PUBLIC WORKS


LOCAL ACCESS

RESIDENTIAL

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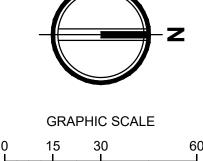
ROAD A PROFILE


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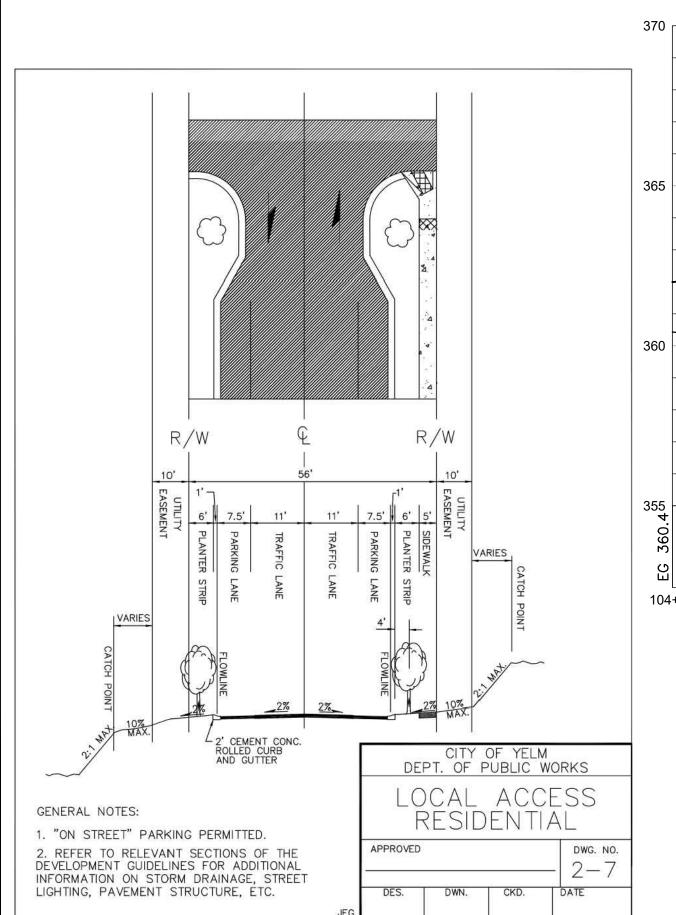



COUNTRY MEADOWS ESTATES PHASE 1 PRELIMINARY PLAT

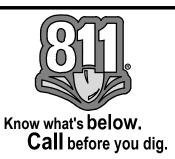A PORTION OF THE NE 1/4 OF THE SE 1/4 OF SEC. 30, TWN. 17 N., RGE. 02 E., W.M., CITY OF YELM, THURSTON COUNTY, WASHINGTON.





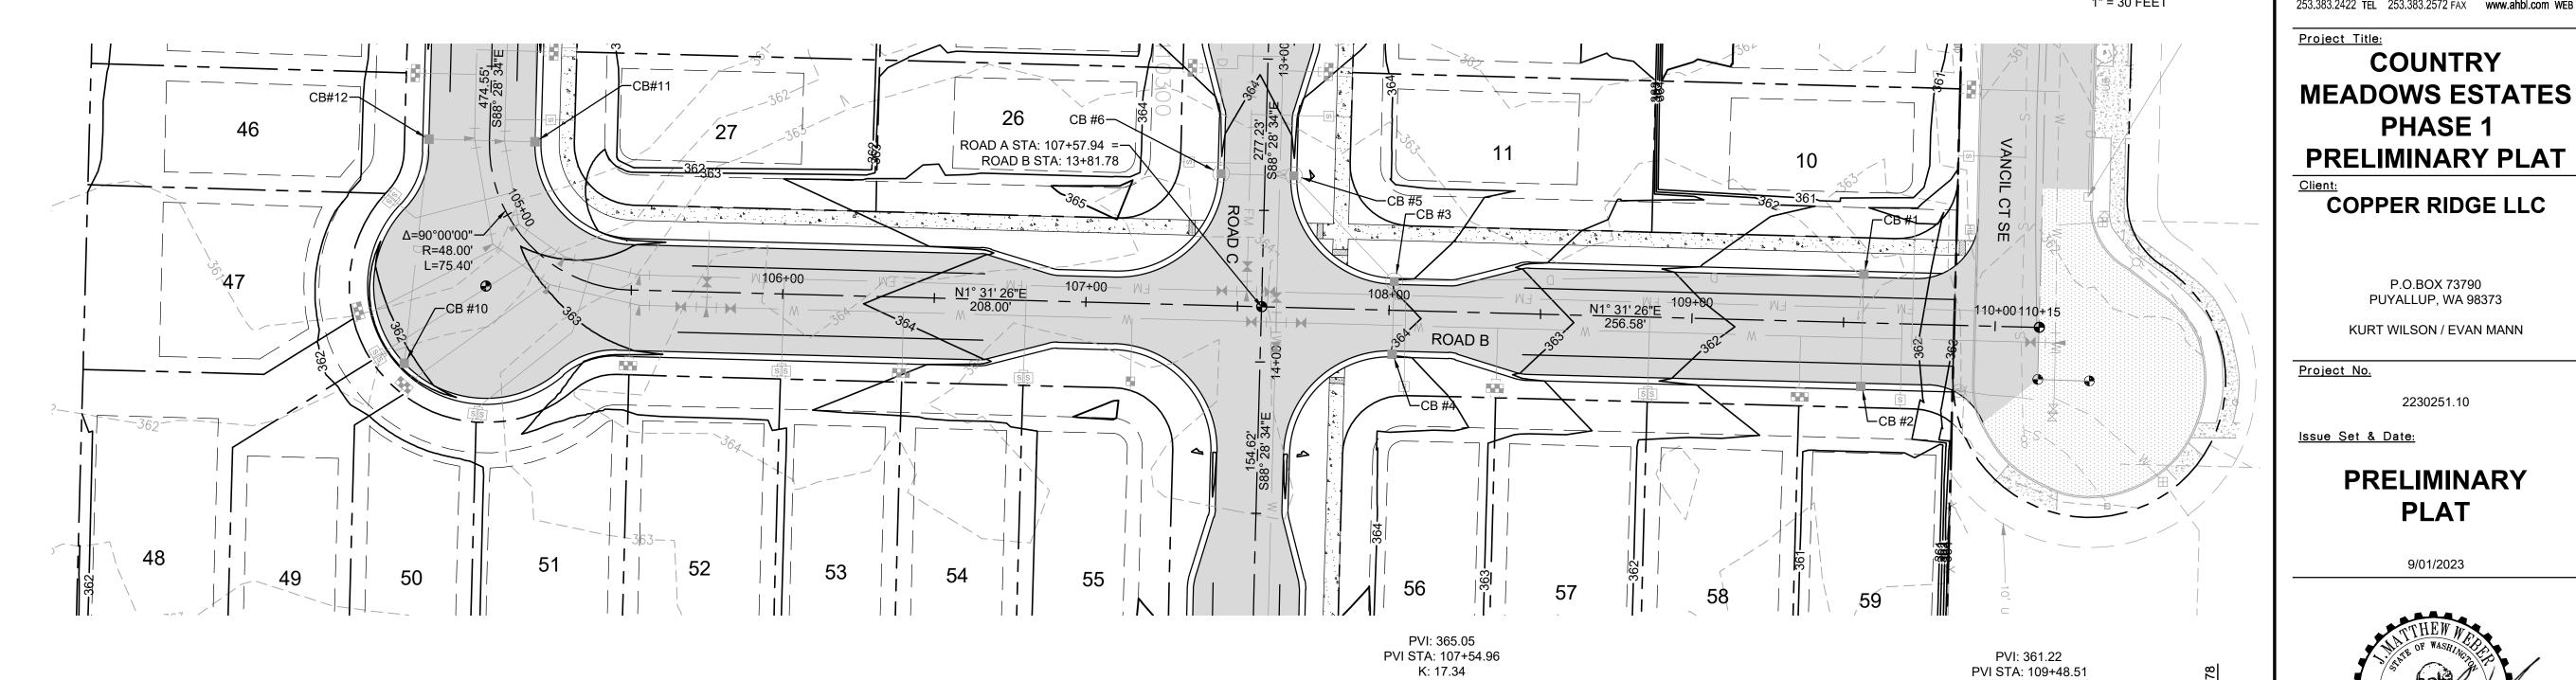

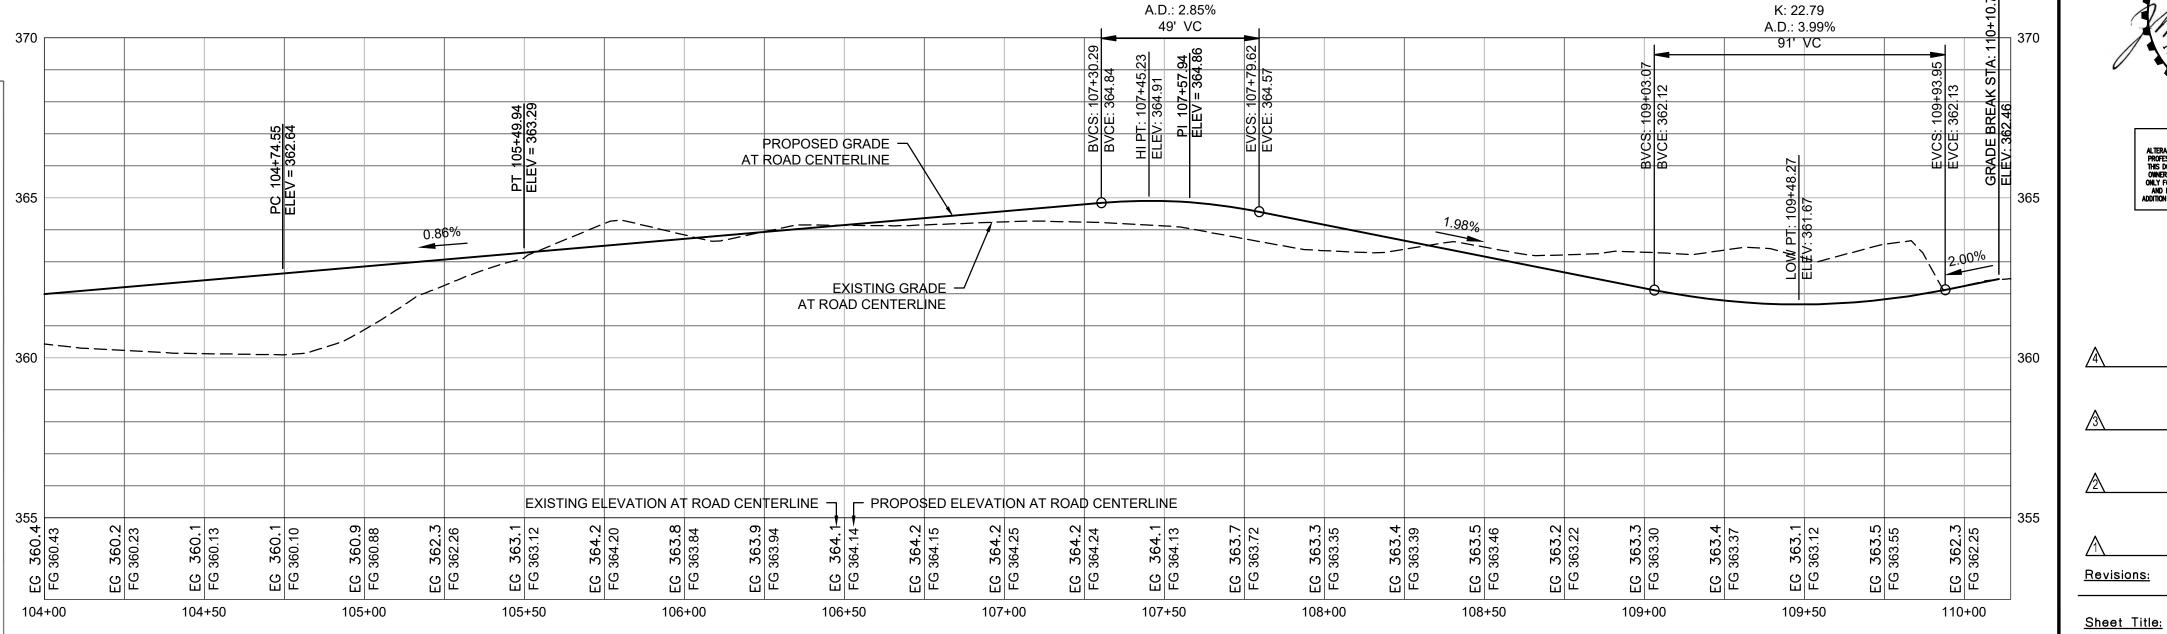

ROAD B PROFILE SCALE: H;1" = 30', V:1" = 3'

Sheet No.

5 of 11 Sheets

ROAD B CONCEPT

PLAN AND PROFILE

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COUNTRY

PHASE 1

COPPER RIDGE LLC

P.O.BOX 73790 PUYALLUP, WA 98373

KURT WILSON / EVAN MANN

2230251.10

PRELIMINARY

PLAT


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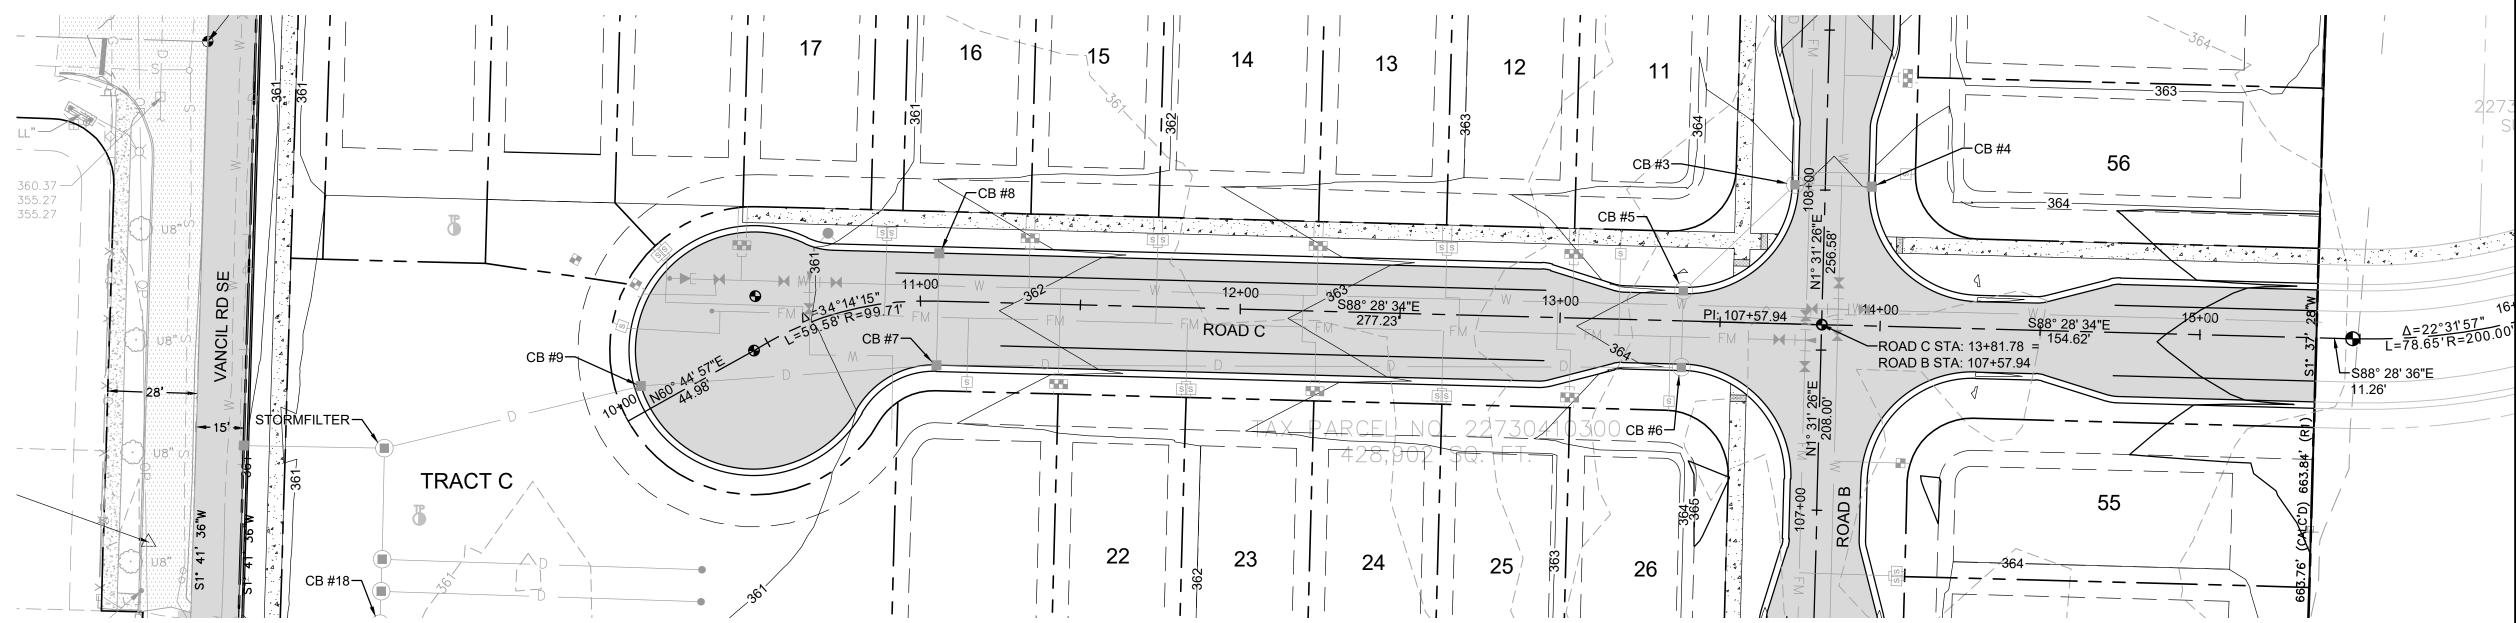
APPLICATION #999???


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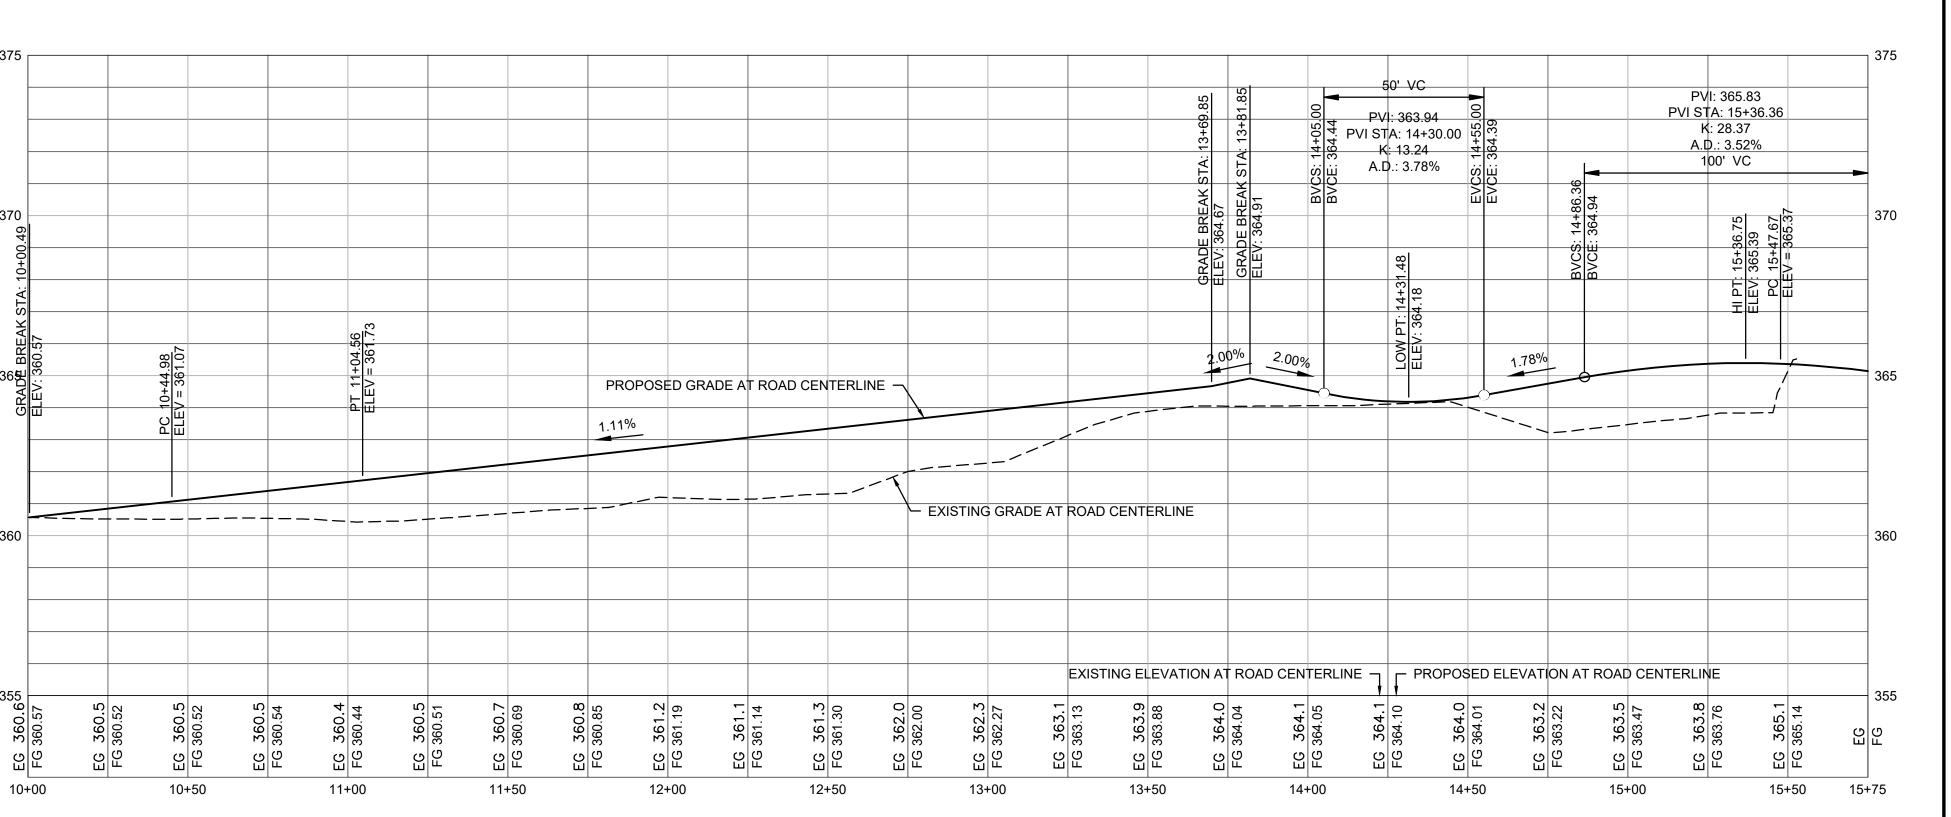
COUNTRY MEADOWS ESTATES PHASE 1 PRELIMINARY PLAT

A PORTION OF THE NE 1/4 OF THE SE 1/4 OF SEC. 30, TWN. 17 N., RGE. 02 E., W.M., CITY OF YELM, THURSTON COUNTY, WASHINGTON.





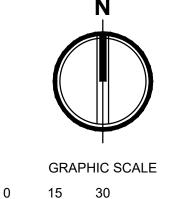

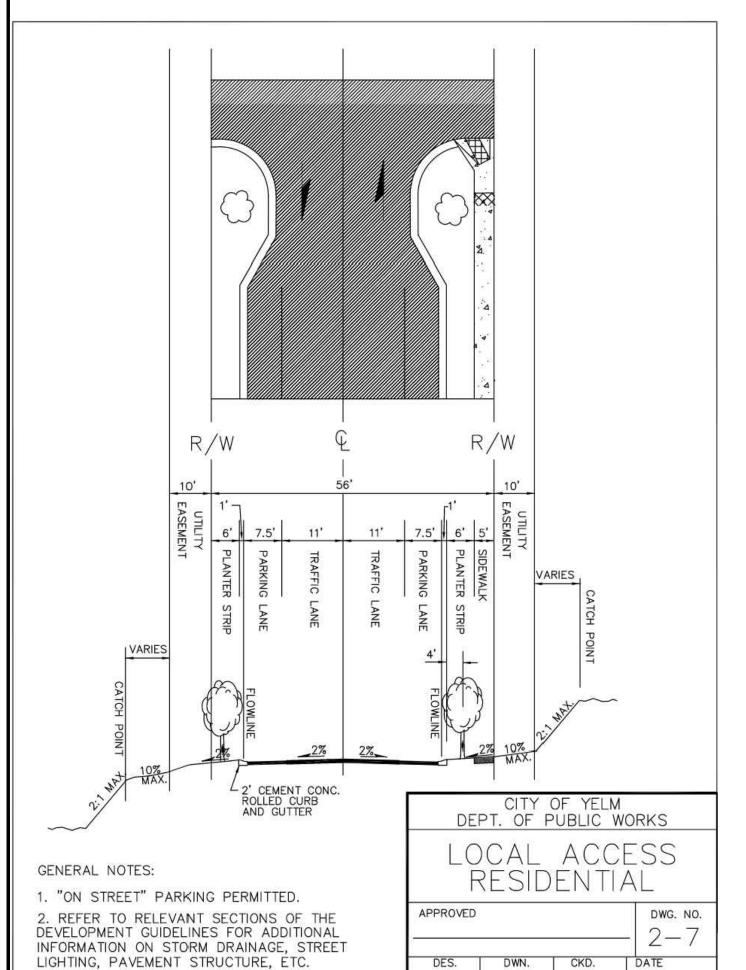

ROAD C PROFILE

LOCAL ACCESS RESIDENTIAL

APPLICATION #999???

COUNTRY **MEADOWS ESTATES** PHASE 1 PRELIMINARY PLAT

COPPER RIDGE LLC

P.O.BOX 73790 PUYALLUP, WA 98373 KURT WILSON / EVAN MANN

Project No.

Project Title:

2230251.10

Issue Set & Date:

PRELIMINARY PLAT

9/01/2023





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Sheet Title:

ROAD C CONCEPT PLAN AND PROFILE


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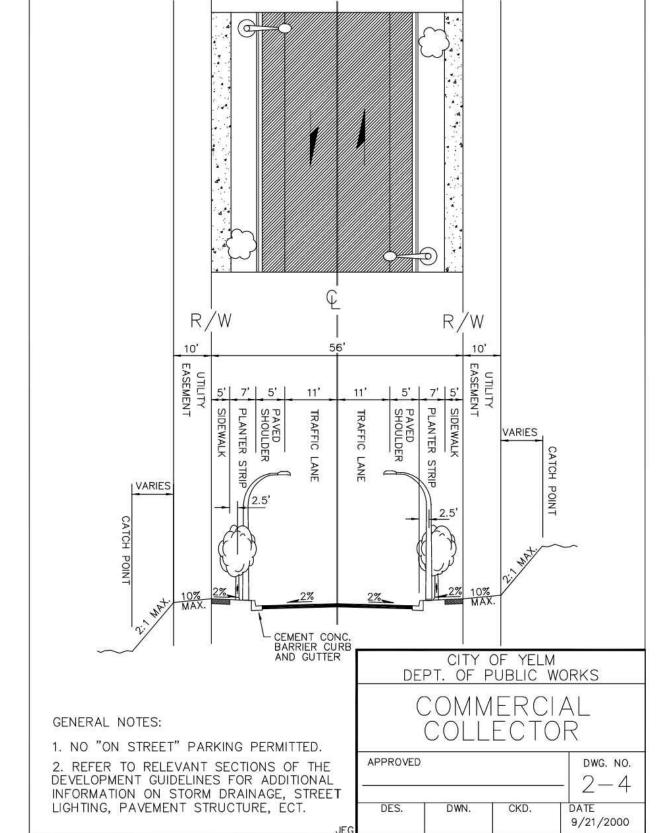
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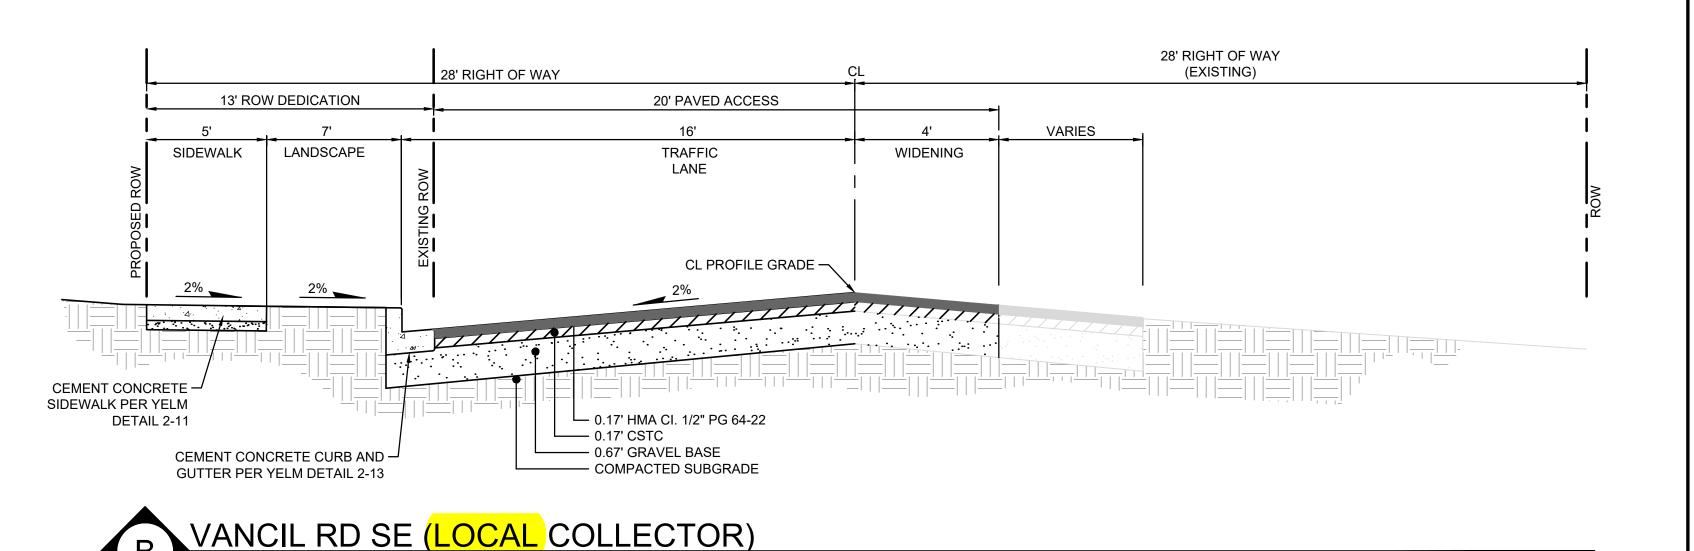
6 of 11 Sheets


COUNTRY MEADOWS ESTATES PHASE 1 PRELIMINARY PLAT

A PORTION OF THE NE 1/4 OF THE SE 1/4 OF SEC. 30, TWN. 17 N., RGE. 02 E., W.M., CITY OF YELM, THURSTON COUNTY, WASHINGTON.





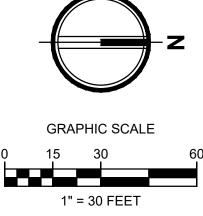

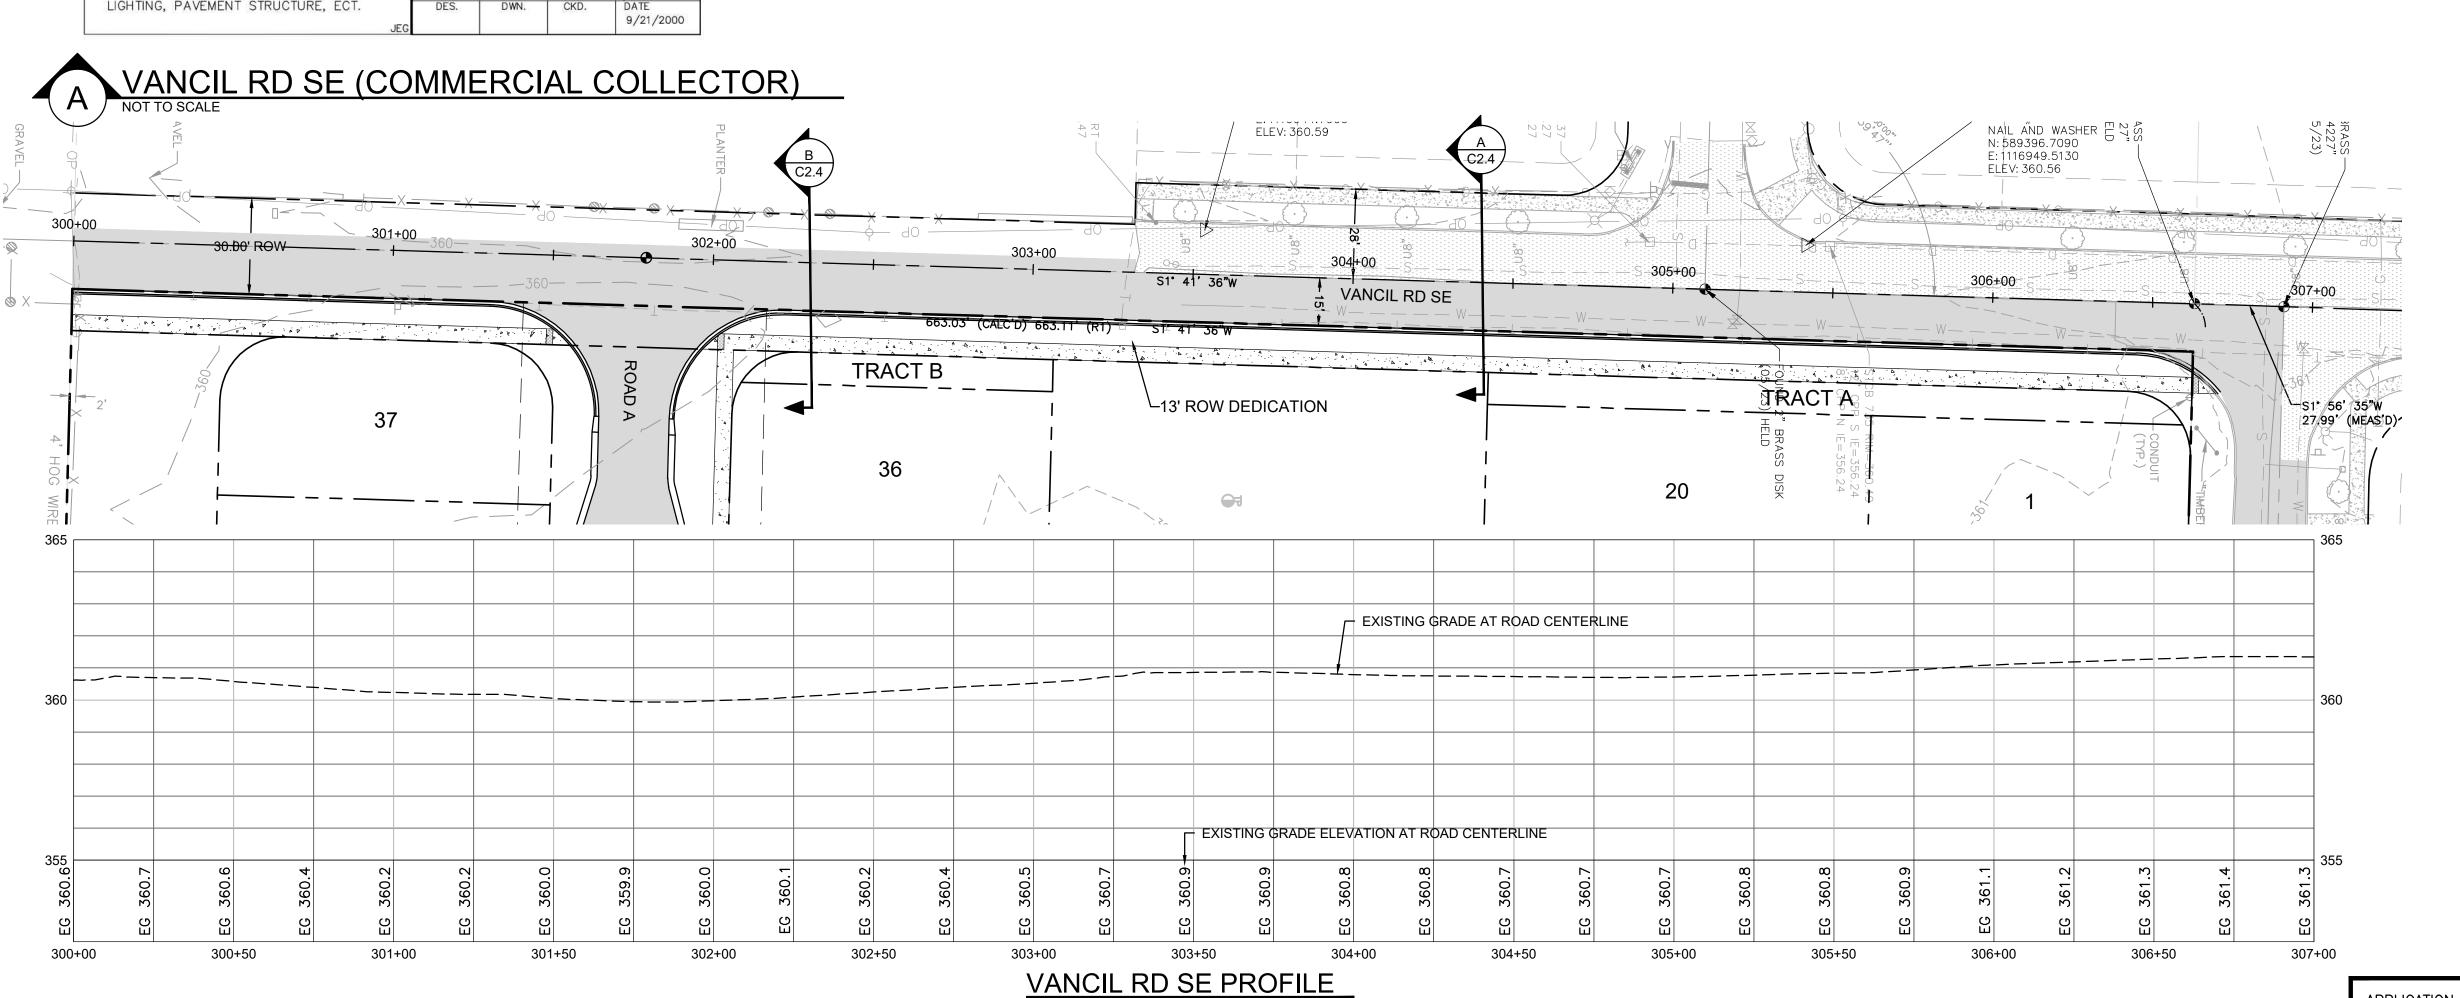

SCALE: H;1" = 30', V:1" = 3'

Project Title: COUNTRY **MEADOWS ESTATES** PHASE 1 PRELIMINARY PLAT

COPPER RIDGE LLC

P.O.BOX 73790 PUYALLUP, WA 98373 KURT WILSON / EVAN MANN

<u>Project No.</u>

2230251.10

Issue Set & Date:

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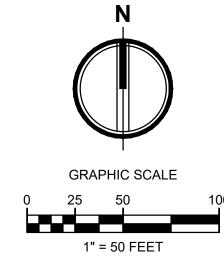
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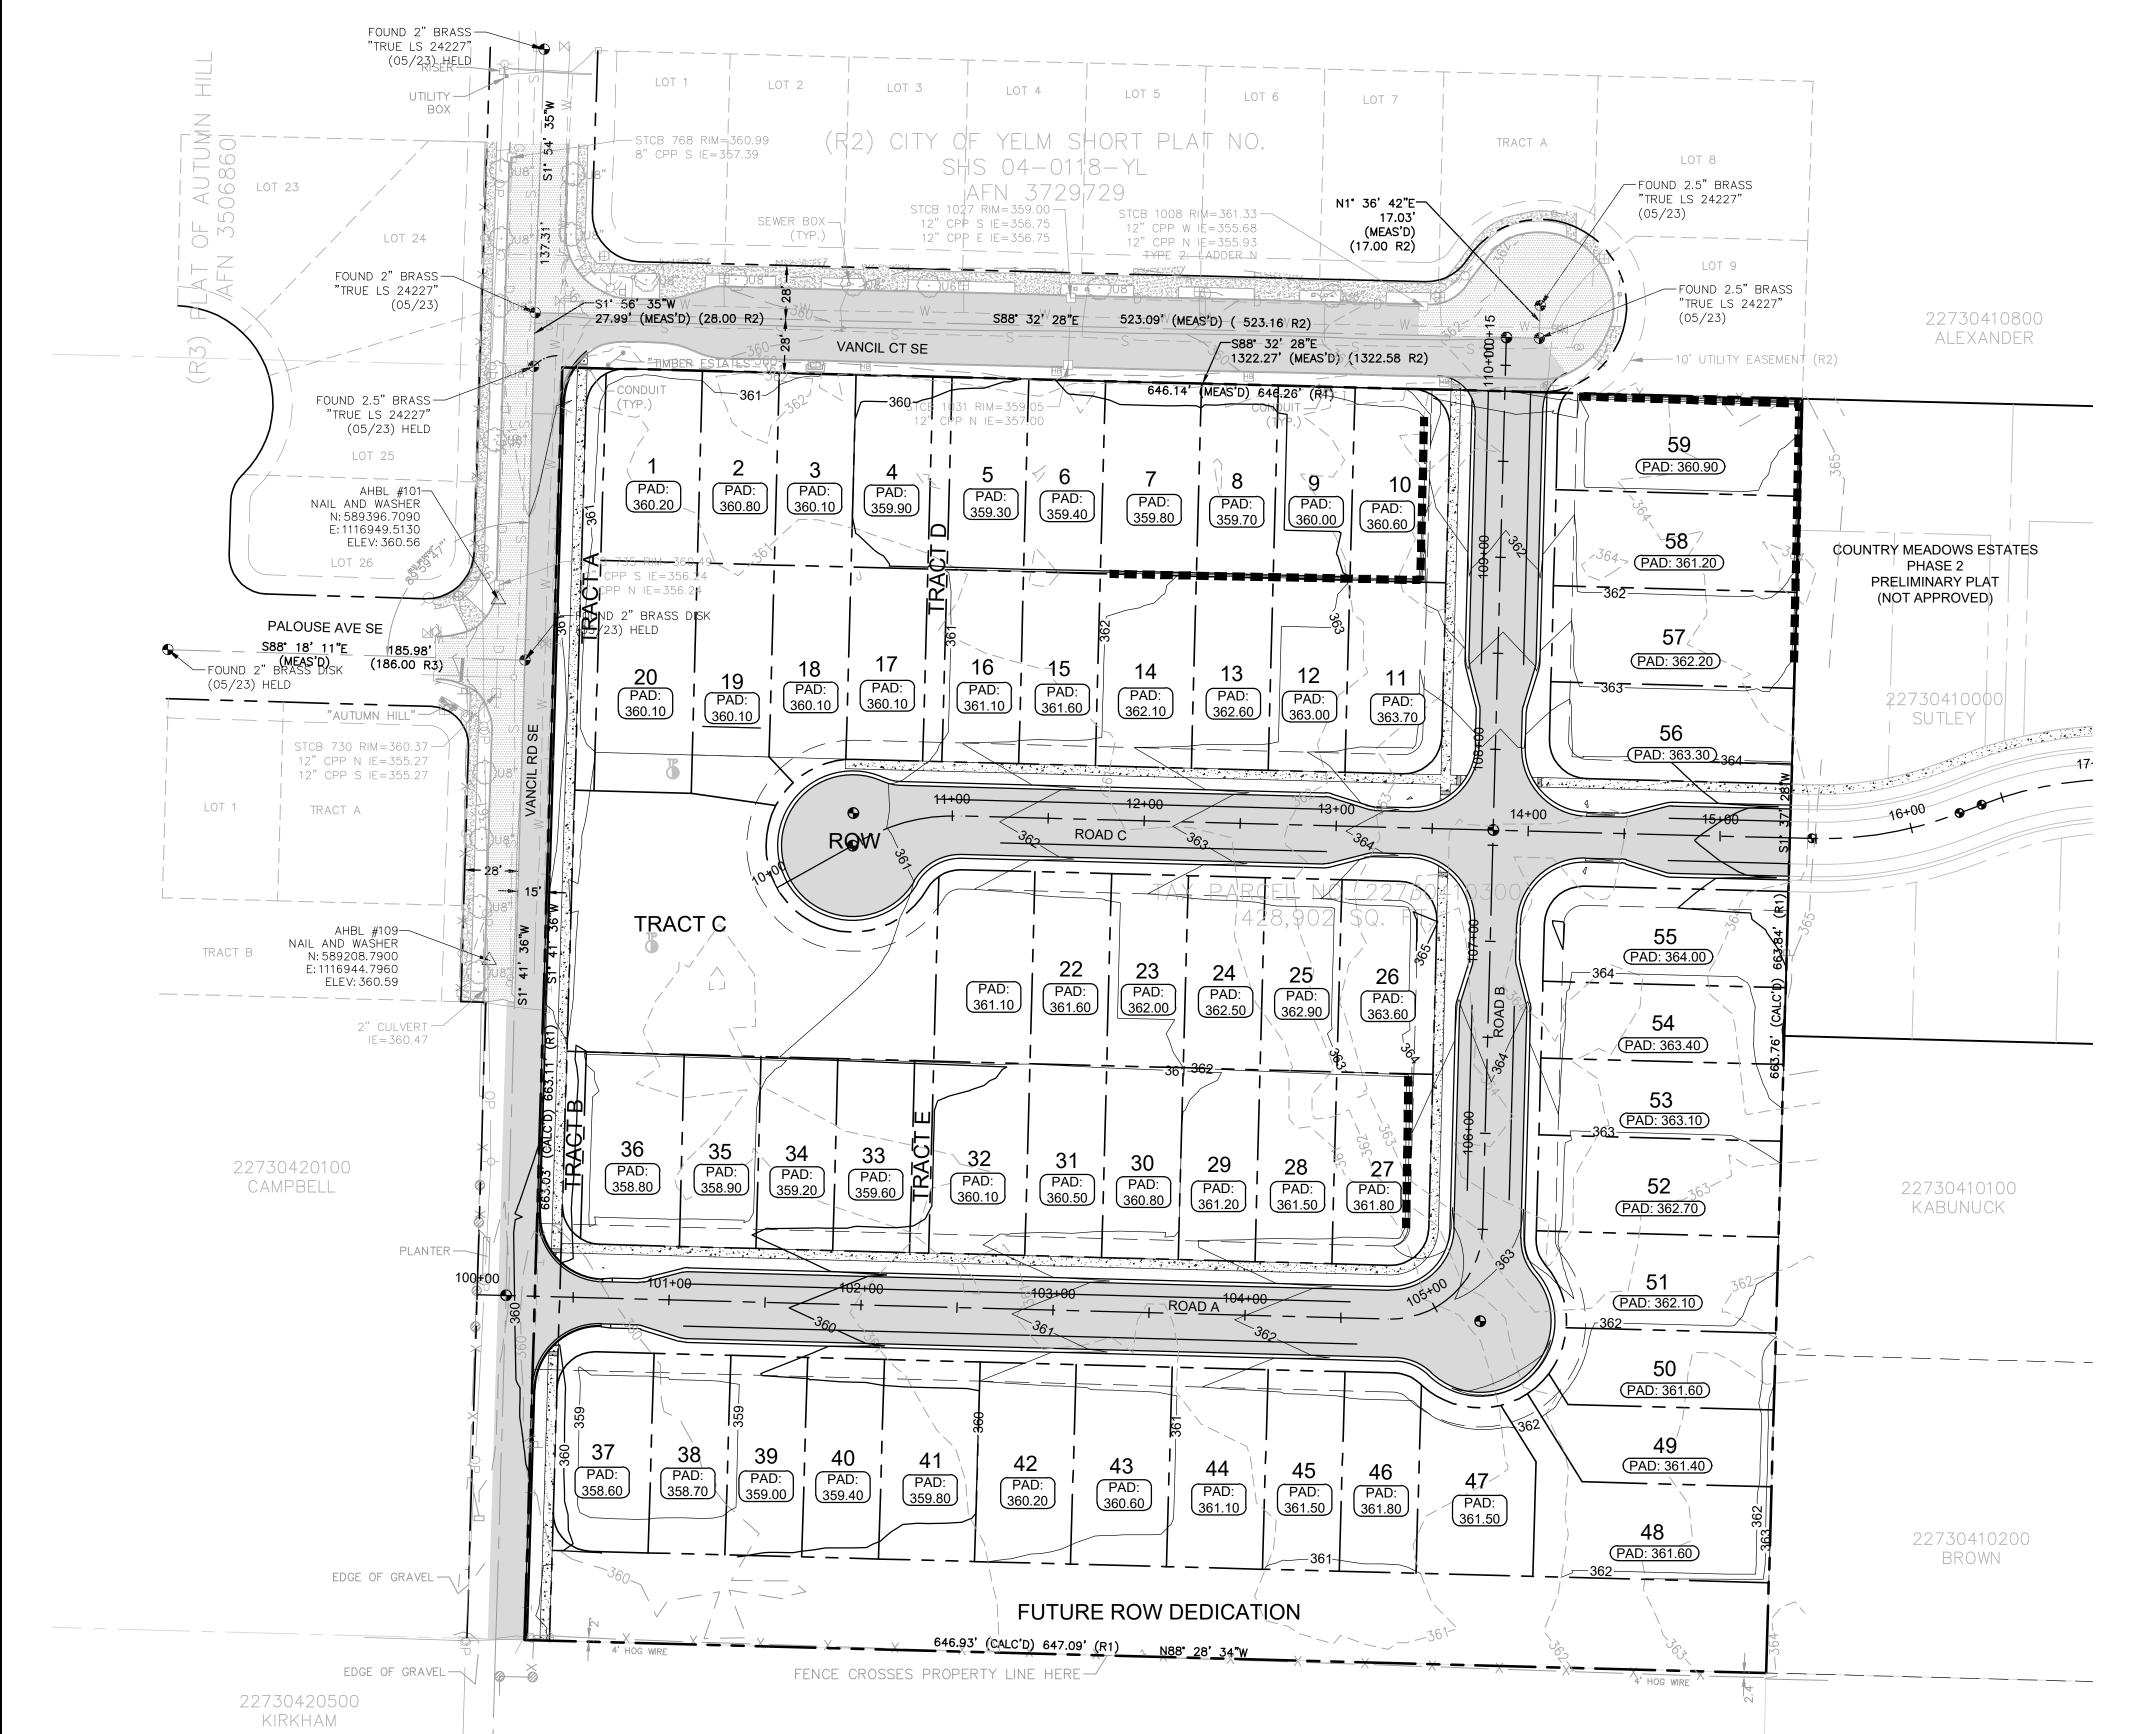
APPLICATION #999???



COUNTRY MEADOWS ESTATES PHASE 1 PRELIMINARY PLAT

A PORTION OF THE NE 1/4 OF THE SE 1/4 OF SEC. 30, TWN. 17 N., RGE. 02 E., W.M., CITY OF YELM, THURSTON COUNTY, WASHINGTON.





EARTHWORK QUANTITIES

CUT = 7,700 CU. YDS FILL = 5,700 CU. YDS

NET = 2,000 CU. YDS EXPORT

THE QUANTITIES DO NOT HAVE STRIPPING, COMPACTION, OR CUT OR FILL ADJUSTMENT FACTORS APPLIED TO THEM, NOR DO THEY ACCOUNT FOR ROADWAY SECTION.



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Project Title: COUNTRY **MEADOWS ESTATES** PHASE 1 PRELIMINARY PLAT

COPPER RIDGE LLC

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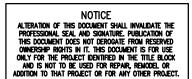
<u>Project No.</u>

Issue Set & Date:

PRELIMINARY PLAT

9/01/2023





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Sheet Title:

CONCEPT **GRADING PLAN**

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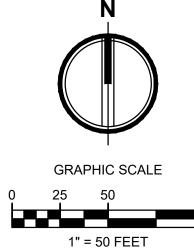
Sheet No.

8 of 11 Sheets

APPLICATION #999???


COUNTRY MEADOWS ESTATES PHASE 1 PRELIMINARY PLAT

A PORTION OF THE NE 1/4 OF THE SE 1/4 OF SEC. 30, TWN. 17 N., RGE. 02 E., W.M., CITY OF YELM, THURSTON COUNTY, WASHINGTON.





ROOF RUNOFF WILL BE INFILTRATED WITHIN THE PRIVATE SYSTEM LOCATED ON EACH LOT.

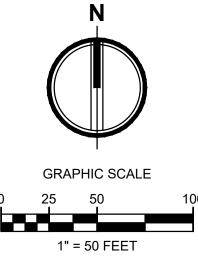

Issue Set & Date: **PRELIMINARY PLAT** 9/01/2023

2215 North 30th Street, Suite 300 Tacoma, WA 98403

COUNTRY

MEADOWS ESTATES

PHASE 1

PRELIMINARY PLAT

COPPER RIDGE LLC

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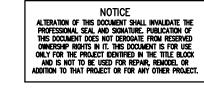
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Project Title:

Project No.






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CONCEPT STORM PLAN

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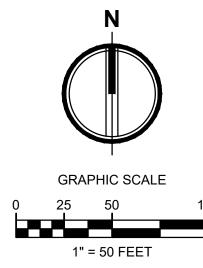
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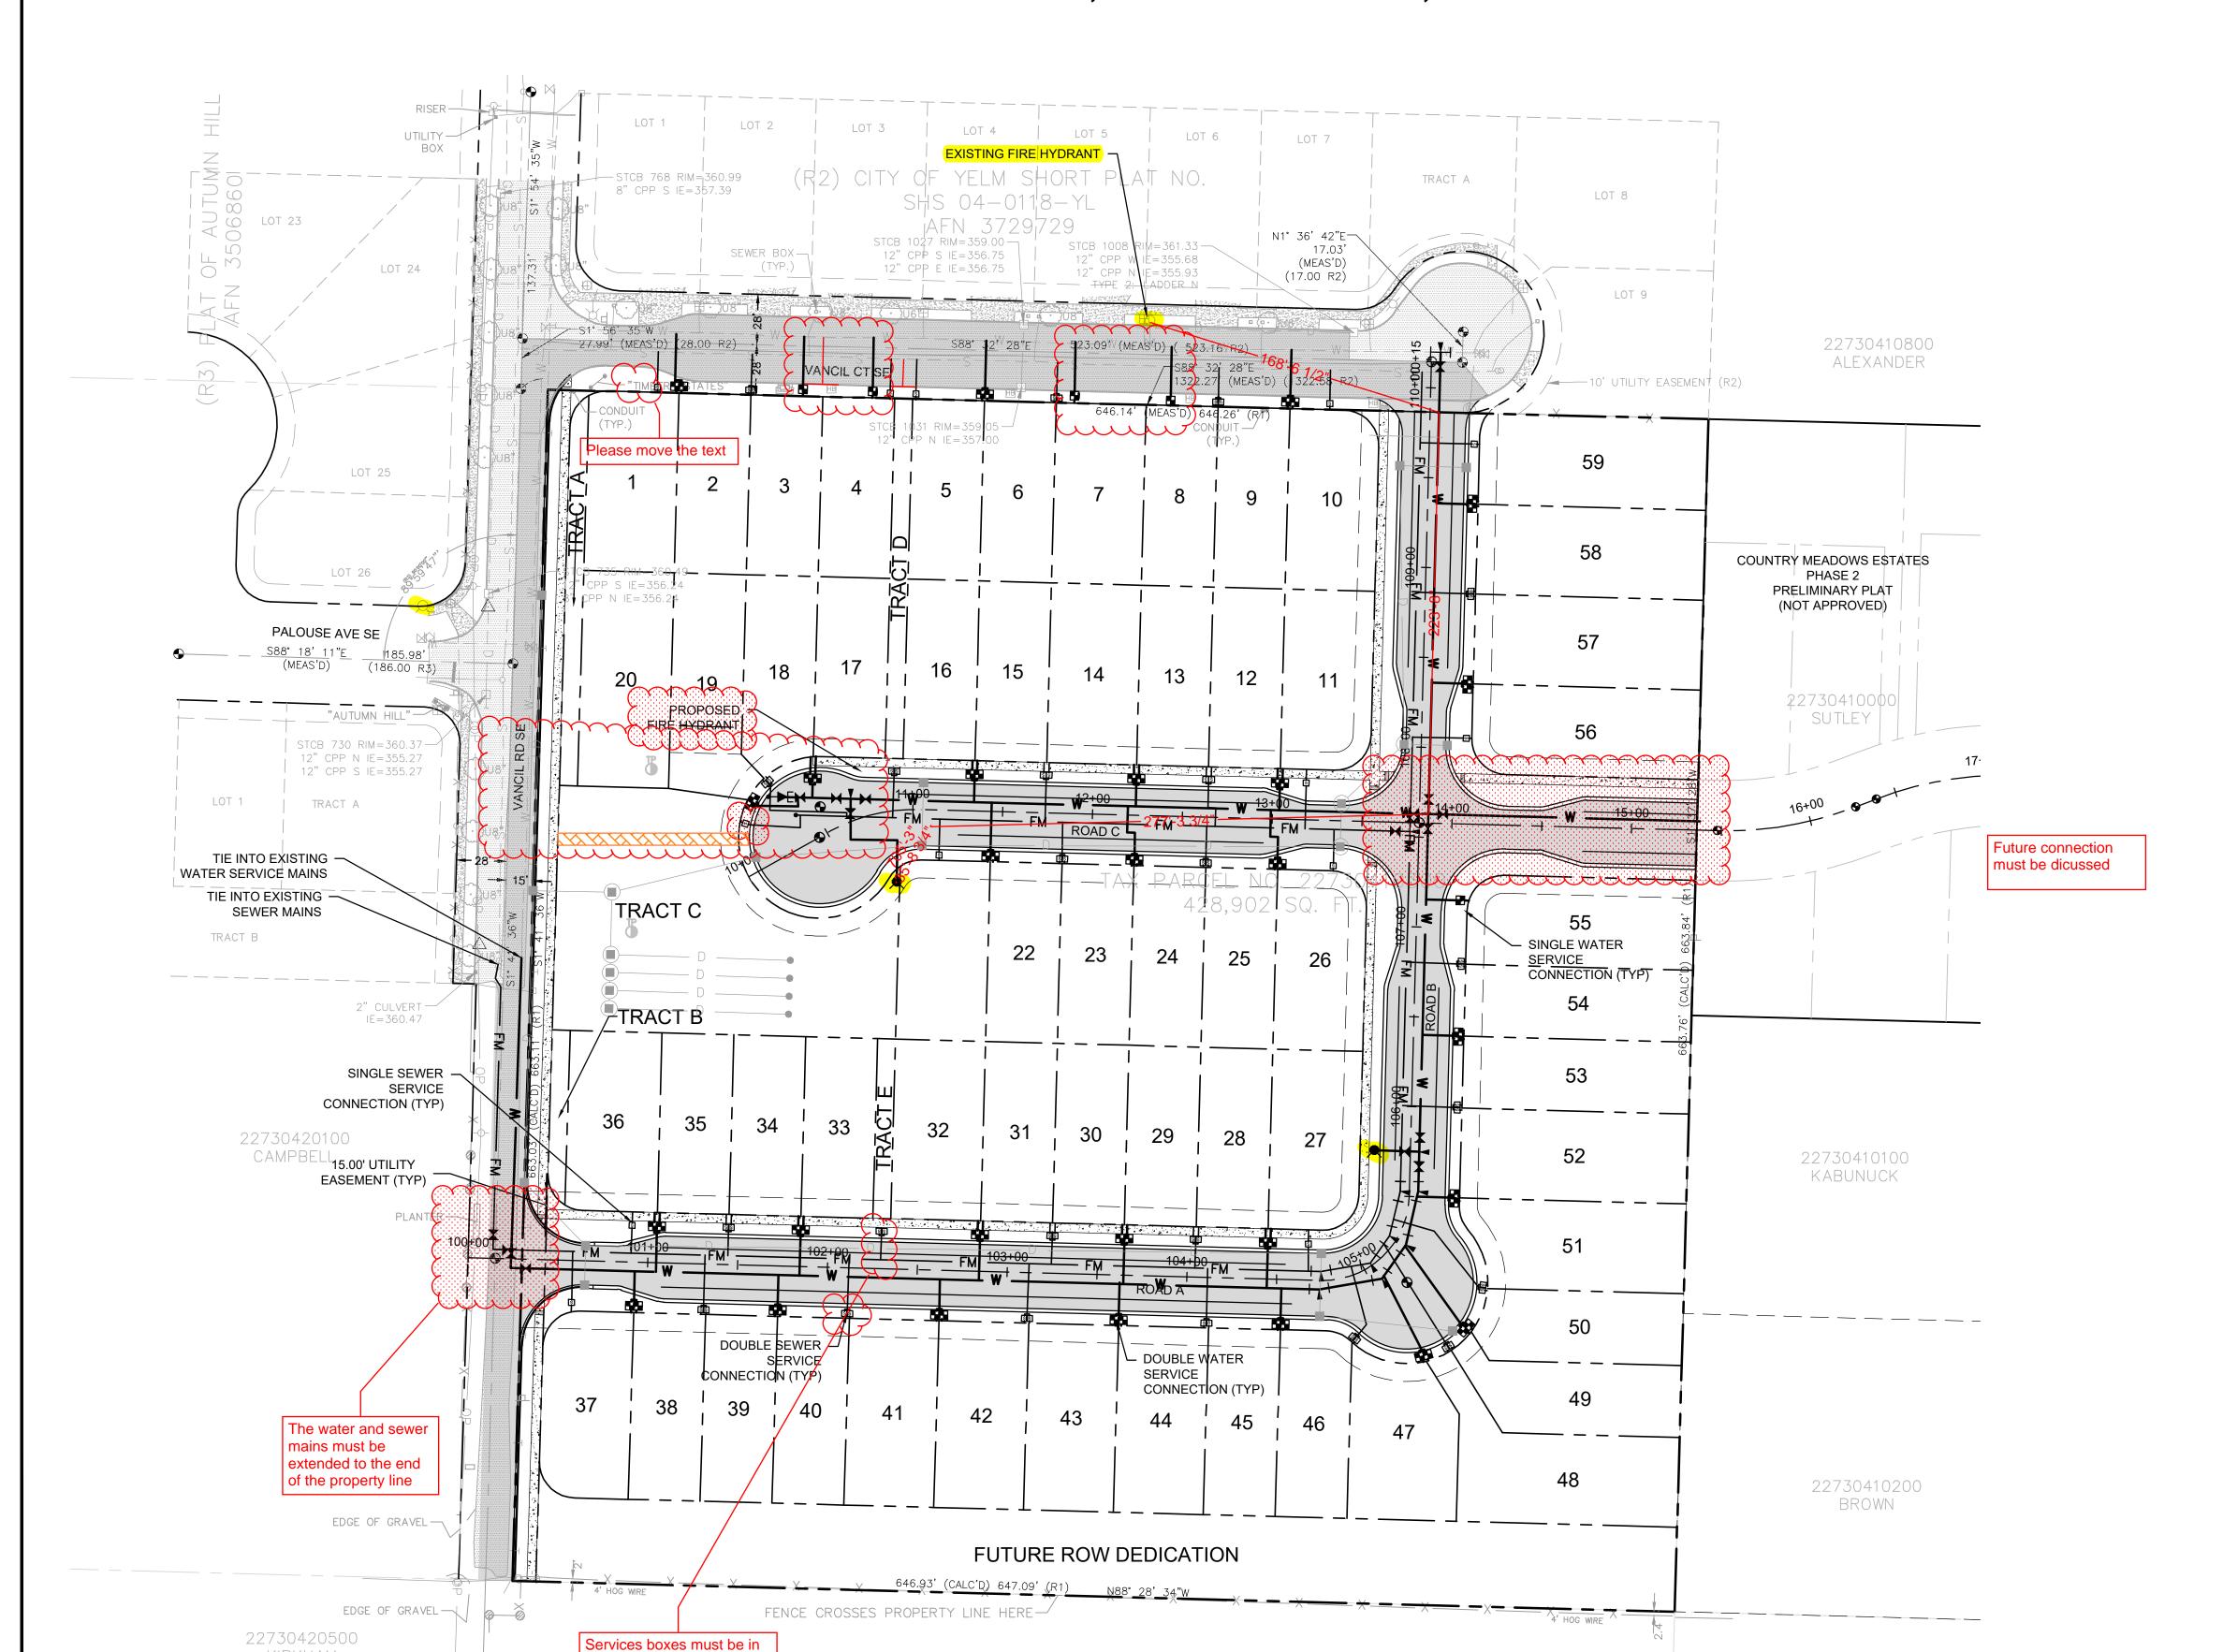
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COUNTRY MEADOWS ESTATES PHASE 1 PRELIMINARY PLAT

A PORTION OF THE NE 1/4 OF THE SE 1/4 OF SEC. 30, TWN. 17 N., RGE. 02 E., W.M., CITY OF YELM, THURSTON COUNTY, WASHINGTON.





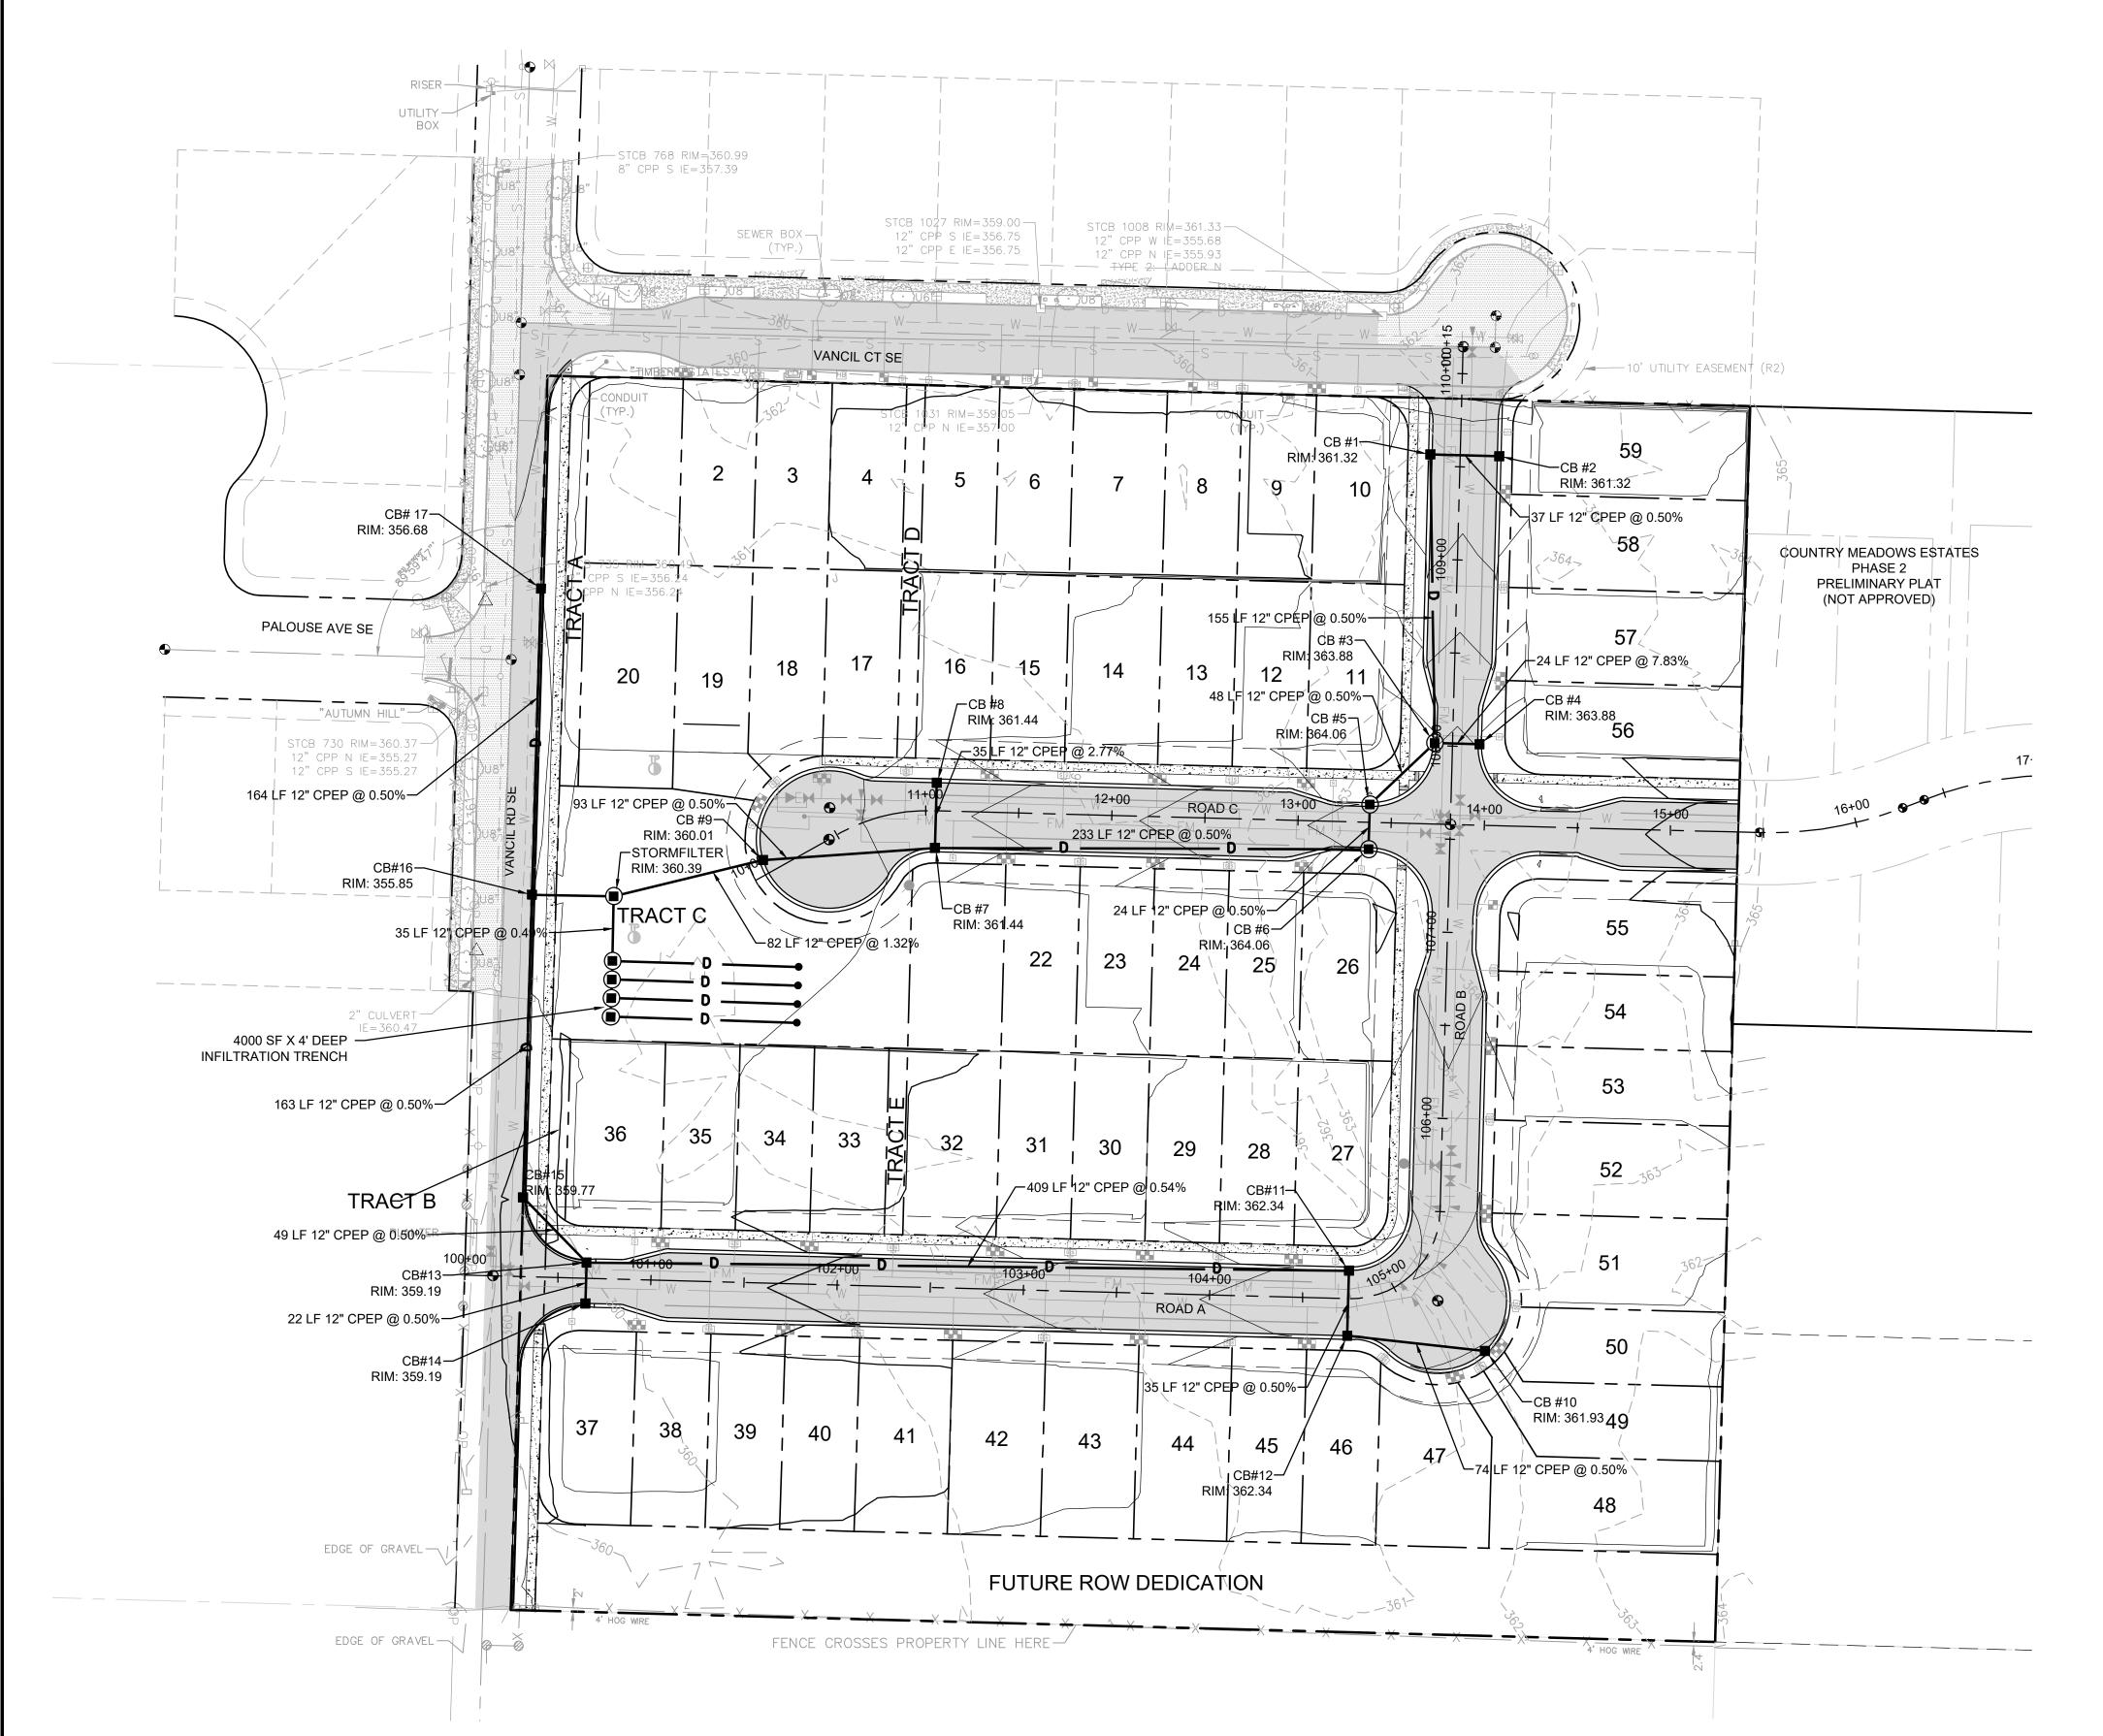

2215 North 30th Street, Suite 300 Tacoma, WA 98403

Project Title: COUNTRY **MEADOWS ESTATES**

PHASE 1 PRELIMINARY PLAT

COPPER RIDGE LLC

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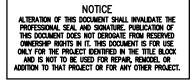
Issue Set & Date:

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9/01/2023





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Sheet Title:

CONCEPT UTILITY PLAN

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<u>Sheet No.</u>

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APPLICATION #999???

front of each property. Please correct the location of all the service boxes.

KIRKHAM



"TRUE LS 24227"

FOUND 2.5" BRASS

AHBL #101— NAIL AND WASHER

N: 589396.7090

E: 1116949.5130 ELEV: 360.56

"AUTUMN HILL"

N: 589208.7900 E: 1116944.7960


ELEV: 360.59


PLANTER-


"TRUE LS 24227" (05/23) HELD

COUNTRY MEADOWS ESTATES PHASE 1 PRELIMINARY PLAT

A PORTION OF THE NE 1/4 OF THE SE 1/4 OF SEC. 30, TWN. 17 N., RGE. 02 E., W.M., CITY OF YELM, THURSTON COUNTY, WASHINGTON.

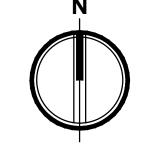

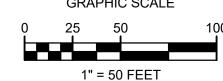

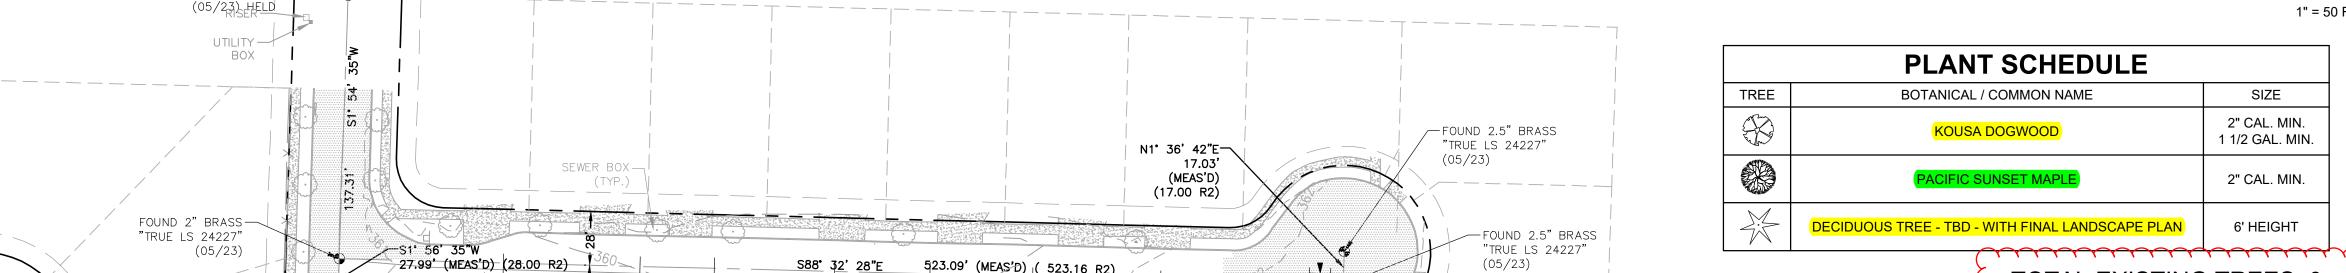

S88' 32' 28"E 1322.27' (MEAS'D) (1322.58 R2)

25

29

FUTURE ROW DEDICATION

646.93' (CALC'D) 647.09' (R1) N88' 28' 34"W

FENCE CROSSES PROPERTY LINE HERE-

VANCIL CT SE

TRACT C

TOTAL EXISTING TREES: 0

TOTAL REMOVED TREES:

TOTAL RETAINED TREES:

TOTAL REPLACEMENT TREES NEEDED:

A PORTION OF THE REPLACEMENT TREES REQUIRED FOR COUNTRY MEADOW ESTATES PHASE 2 WILL BE PLANTED WITHIN COUNTRY MEADOW ESTATES PHASE 1.

STREET TREES PHASE 1:	
STREET TREES PHASE 2:	
ADDITIONAL TREES PHASE 1:	
ADDITIONAL TREES PHASE 2:	
TOTAL REPLACEMENT TREES:	

NOT

COUNTRY MEADOWS ESTATES

PRELIMINARY PLAT

- THIS IS A PRELIMINARY LANDSCAPE DESIGN. SPECIES AND LOCATION OF PROPOSED TREES IS SUBJECT TO CHANGE.
- 2. FINAL LANDSCAPE, TREE RETENTION AND VEGETATION PLAN TO BE PREPARED BY A LICENSED LANDSCAPE ARCHITECT AND SUBMITTED TO THE CITY OF YELM FOR APPROVAL PRIOR TO THE ISSUANCE OF SITE DEVELOPMENT PERMIT.
- 3. PERIMETER LANDSCAPE TO BE PLANTED PER YELM CODE.
- 4. STREET TREES SPACED 35' O.C. PLACEMENT ADJUSTED FOR DRIVEWAYS, UTILITIES, AND STREET LIGHTS, SHRUBS AND GROUNDCOVER PER YELM MUNICIPAL CODE 18.55.020 (C).
- 5. IN ACCORDANCE WITH YMC18.55.050, LANDSCAPE AREAS SHALL HAVE IRRIGATION SYSTEM OR BE WITHIN 75 FEET OF A HOSE SPIGOT. IRRIGATION SYSTEM SHALL BE DESIGN/BUILD. CONTRACTOR TO COORDINATE.

STREETSCAPE

- 1. PURPOSE: STREETSCAPE LANDSCAPING IS INTENDED TO PROVIDE VISUAL RELIEF WHERE CLEAR SIGHT IS DESIRED. THIS LANDSCAPING IS UTILIZED ALONG PEDESTRIAN CORRIDORS AND WALKS FOR SEPARATION OF PEDSTRIANS FROM STREET AND PARKING AREAS WHILE PROVIDING AN ATTRACTIVE SETTLING AND OVERSTORY CANOPY.
- WHEN REQUIRED: STREETSCAPE LANDSCAPING IS REQUIRED AS PART OF STREET FRONTAGE IMPROVEMENTS.
- 3 DESCRIPTIO
- a. THIS TYPE OF LANDSCAPING CONSISTS OF STREET TREES FOR A LARGE OVERSTORY CANOPY ALONG STREETS AND PEDESTRIAN CORRIDORS AND APPROVED VEGETATION FOR GROUNDCOVER.
- b. STREET TREES SHALL BE CHOSEN FROM A STREET TREE LIST AS ADOPTED BY THE YELM TREE ADVISORY BOARD. DECORATIVE PROTECTION MAY BE PLACED AROUND THE TREES.
- c. GROUNDCOVER SHALL BE A MINIMUM FOUR-INCH POTS SPACED 18 TO 20 INCHES ON CENTER OR ONE-GALLON POTS AT 20 INCHES ON CENTER. LOW GROWTH SHRUBS SHALL BE ONE-GALLON POTS AT THREE FEET ON CENTER. SHRUBS SHALL BE 18 TO 24 INCHES IN HEIGHT AT FIVE FEET ON CENTER OR THREE-GALLON POT AT FIVE FEET ON CENTER.
- d. EARTHEN BERMS WITH GRASS OR OTHER VEGETATIVE GROUNDCOVER AND OTHER DESIGN FEATURES MAY BE WORKED INTO LANDSCAPING PROVIDED THE RESULTANT EFFECT OF PROVIDING A PEDESTRIAN-FRIENDLY ENVIRONMENT AND VISUAL RELIEF WHERE CLEAR SITE IS REQUIRED CAN BE ACHIEVED.
- e. THE MINIMUM WIDTH FOR STREETSCAPE LANDSCAPING SHALL BE SIX FEET TO PROVIDE ROOTING AREA FOR LARGE STREET TREES AND TO PROVIDE ADEQUATE STREETSCAPE. A FOUR-FOOT WIDTH MAY BE USED THROUGH PARKING AREA PEDESTRIAN WALKS WHERE ACCENT TREES ARE USED AND LESS WIDTH IS REQUIRED.
- f. PLANTING THEME SHALL BE A RATIO OF THREE STREET TREES TO ONE ACCENT TREE.
- g. TREES SHALL BE SPACED 35 FEET ON CENTER STARTING 15 FEET FROM THE PROPERTY LINE. TREE SPACING MAY BE ADJUSTED TO ALLOW UNOBSTRUCTED SIGHT DISTANCE ON EITHER SIDE OF A DRIVEWAY AND AT STREET INTERSECTIONS. TREE SPACING MAY ALSO BE ADJUSTED WHEN IN CONFLICT WITH LUMINAIRE POLES.

APPLICATION #999???



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COUNTRY
MEADOWS ESTATES
PHASE 1
PRELIMINARY PLAT

COPPER RIDGE LLC

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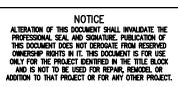
Project Title:

Issue Set & Date:

PRELIMINARY PLAT

9/01/2023





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Revisions:

Sheet Title:

CONCEPTUAL LANDSCAPE PLAN

<u>Drawn by:</u> <u>Checked by:</u> MW/SK

Sheet No.

C6.111 of 11 Sheets

EDGE OF GRAVEL

EDGE OF GRAVEL